


100% CONSTRUCTION DOCUMENTS
BUILDING 56 - 2ND FLOOR
NRCS CONSOLIDATION
-- FOR CONSTRUCTION --

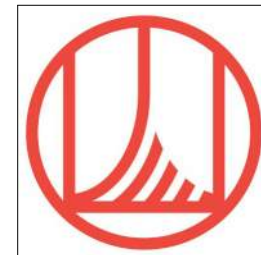

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Principal: Dave Anderson
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BUILDING 56 - 2ND FLOOR NRCS CONSOLIDATION

GENERAL SERVICES ADMINISTRATION ~ DENVER FEDERAL CENTER ~ BUILDING 56



100% CD ISSUE

JULY 25, 2019

7/25/2019 **G 0 01**

SHEET 1 OF 50

8/8/2019 12:01:07 PM

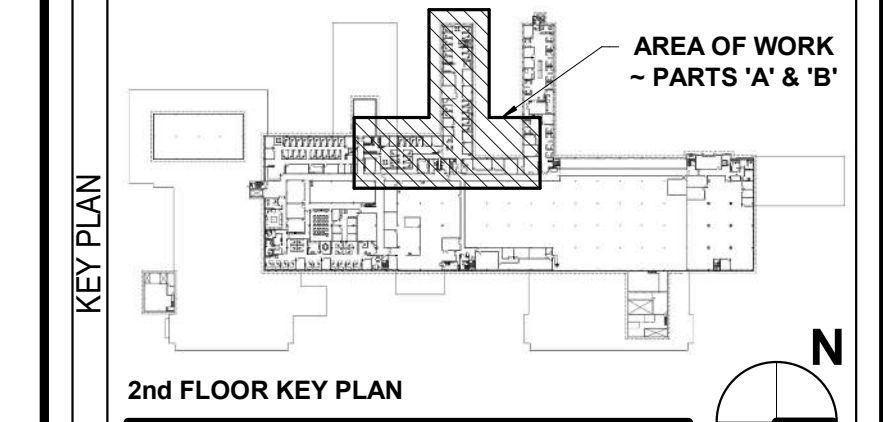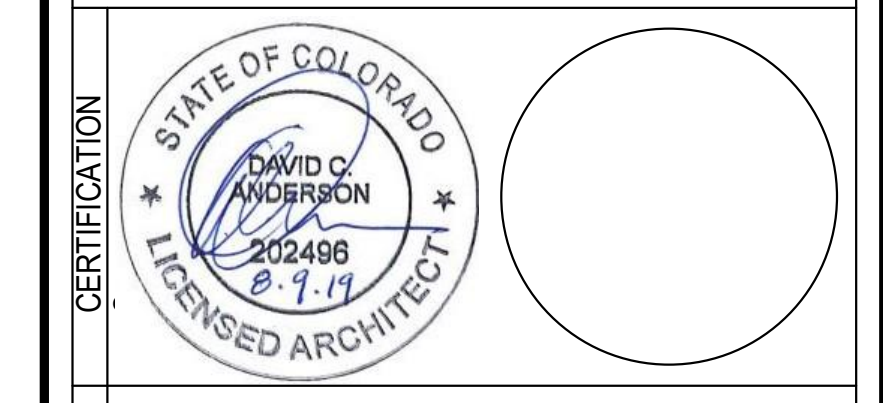

MARK	DATE	DESCRIPTION

CONTRACTORS	CONTRACT NO.	GS-08P-JB-D-0017
CONTRACTORS	A/E TASK NO.	EP-GS-P-08-16-JB-7053
CONTRACTORS	CONS. CONTR.	GS-08P-13-JB-D-0032
CONTRACTORS	CONS. WORK	
CONTRACTORS	PRIM A/E	ANDERSON HALLAS ARCHITECTS PC
CONTRACTORS	SUB A/E	
CONTRACTORS	CONSTR. CON.	
BUILDING	NAME	BUILDING 56
BUILDING	STREET	6TH STREET
BUILDING	CITY/ST./ZIP	DENVER, COLORADO 80255
BUILDING	BUILDING NO.	BUILDING 56
BUILDING	OTHER BUILDING NOS	
BUILDING	FACILITY CODE	
PROJECT	PROJECT TITLE	BUILDING 56 - NRCS
PROJECT	PROJECT DESCRIPTION	BUILDING 56 - 2ND FLOOR NRCS CONSOLIDATION
PROJECT	PROJECT NO.	EP-GS-P-08-16-JB-7053
PROJECT	GSA PM	BEN REKO
PROJECT	SUBMISSION	100 CD ISSUE
PROJECT	SUB. DATE	07/25/2019
DRAWING	DRAWING TITLE	CODE AND EGRESS INFORMATION
DRAWING	FILE NAME	
DRAWING	FLOOR NO.	2ND FLOOR
DRAWING	DRAWN BY	DAM / LB DATE DRAFTED: 04/15/2019
DRAWING	CHECKED BY	DCA / RS SHEET SIZE: 22X34
DRAWING	DRAWING NO.	G 0 03
DRAWING	DISCIPLINE	SHEET TYPE SEQUENCE
DRAWING		SHEET 3 OF 50

BUILDING CODE ANALYSIS
 Code analysis is based on the 2015 International Building Code, and the 2015 International Existing Building Code. Refer to Mechanical, Plumbing, Electrical & Fire Protection sheets for additional information.

Date: 02.15.2019
 Analysis By: RAS
 Project Number: 2017360
 Project Name: NRCS Consolidation
 Address: Building 56 6th Street
 Denver, CO 80255

SCOPE OF WORK:
 This project is a tenant finish to a small portion of the 2nd floor of Building 56, located in the Federal Center. The scope includes minor wall reconfiguration, new interior finishes, a new break room, and minor reconfiguration of mechanical, electrical and fire protection systems. No work to the building envelope is included.

PROJECT OCCUPANCY: B
CONSTRUCTION TYPE:
 Type IIB, with a fully automatic NFPA 13 sprinkler system

PROJECT AREA: 9750sf

OCCUPANT LOAD:
 Business(100sf/person): 8265sf = 83
 Mechanical/ Support (300sf/person): 810sf = 3
 Total Occupant Load: 86

BUILDING HEIGHT AND NUMBER OF STORIES: Unchanged
BUILDING AREA: Unchanged

FIRE PROTECTION:
 Existing fire sprinkler system to be upgraded to comply with Section 903.
 Portable fire extinguishers required per section 906, and located per GSA P100 in mechanical, electrical, IT and Break Rooms. Contractor to verify existing extinguishers are present, code compliant, and in working order. If not, replace.
 Existing fire alarm system to be upgraded to comply with Section 907.


EGRESS:
 Egress width: 32" + 64" provided. Required width = 32" min.
 Two exits provided. - Required # = 2
 Exit Access Travel Distance: 96' max. provided. 300' max. required.
 Common Path of Egress Travel Distance: 58' max. provided. 100' max. provided.

PLUMBING FIXTURE COUNT: unchanged

FIRE SAFETY/EGRESS LEGEND


- EGRESS DOOR W/ EXIT SIGNAGE
- EGRESS PATH
- AREA OF WORK
- ASSUMED (E) 2HR RATED PARTITION
- DIRECTION OF EGRESS TRAVEL
- FIRE EXTINGUISHER CABINET
- EXIT SIGNAGE
- EMERGENCY LIGHT

100% CONSTRUCTION DOCUMENTS
 BUILDING 56 - 2ND FLOOR
 NRCS CONSOLIDATION
 -- FOR CONSTRUCTION --

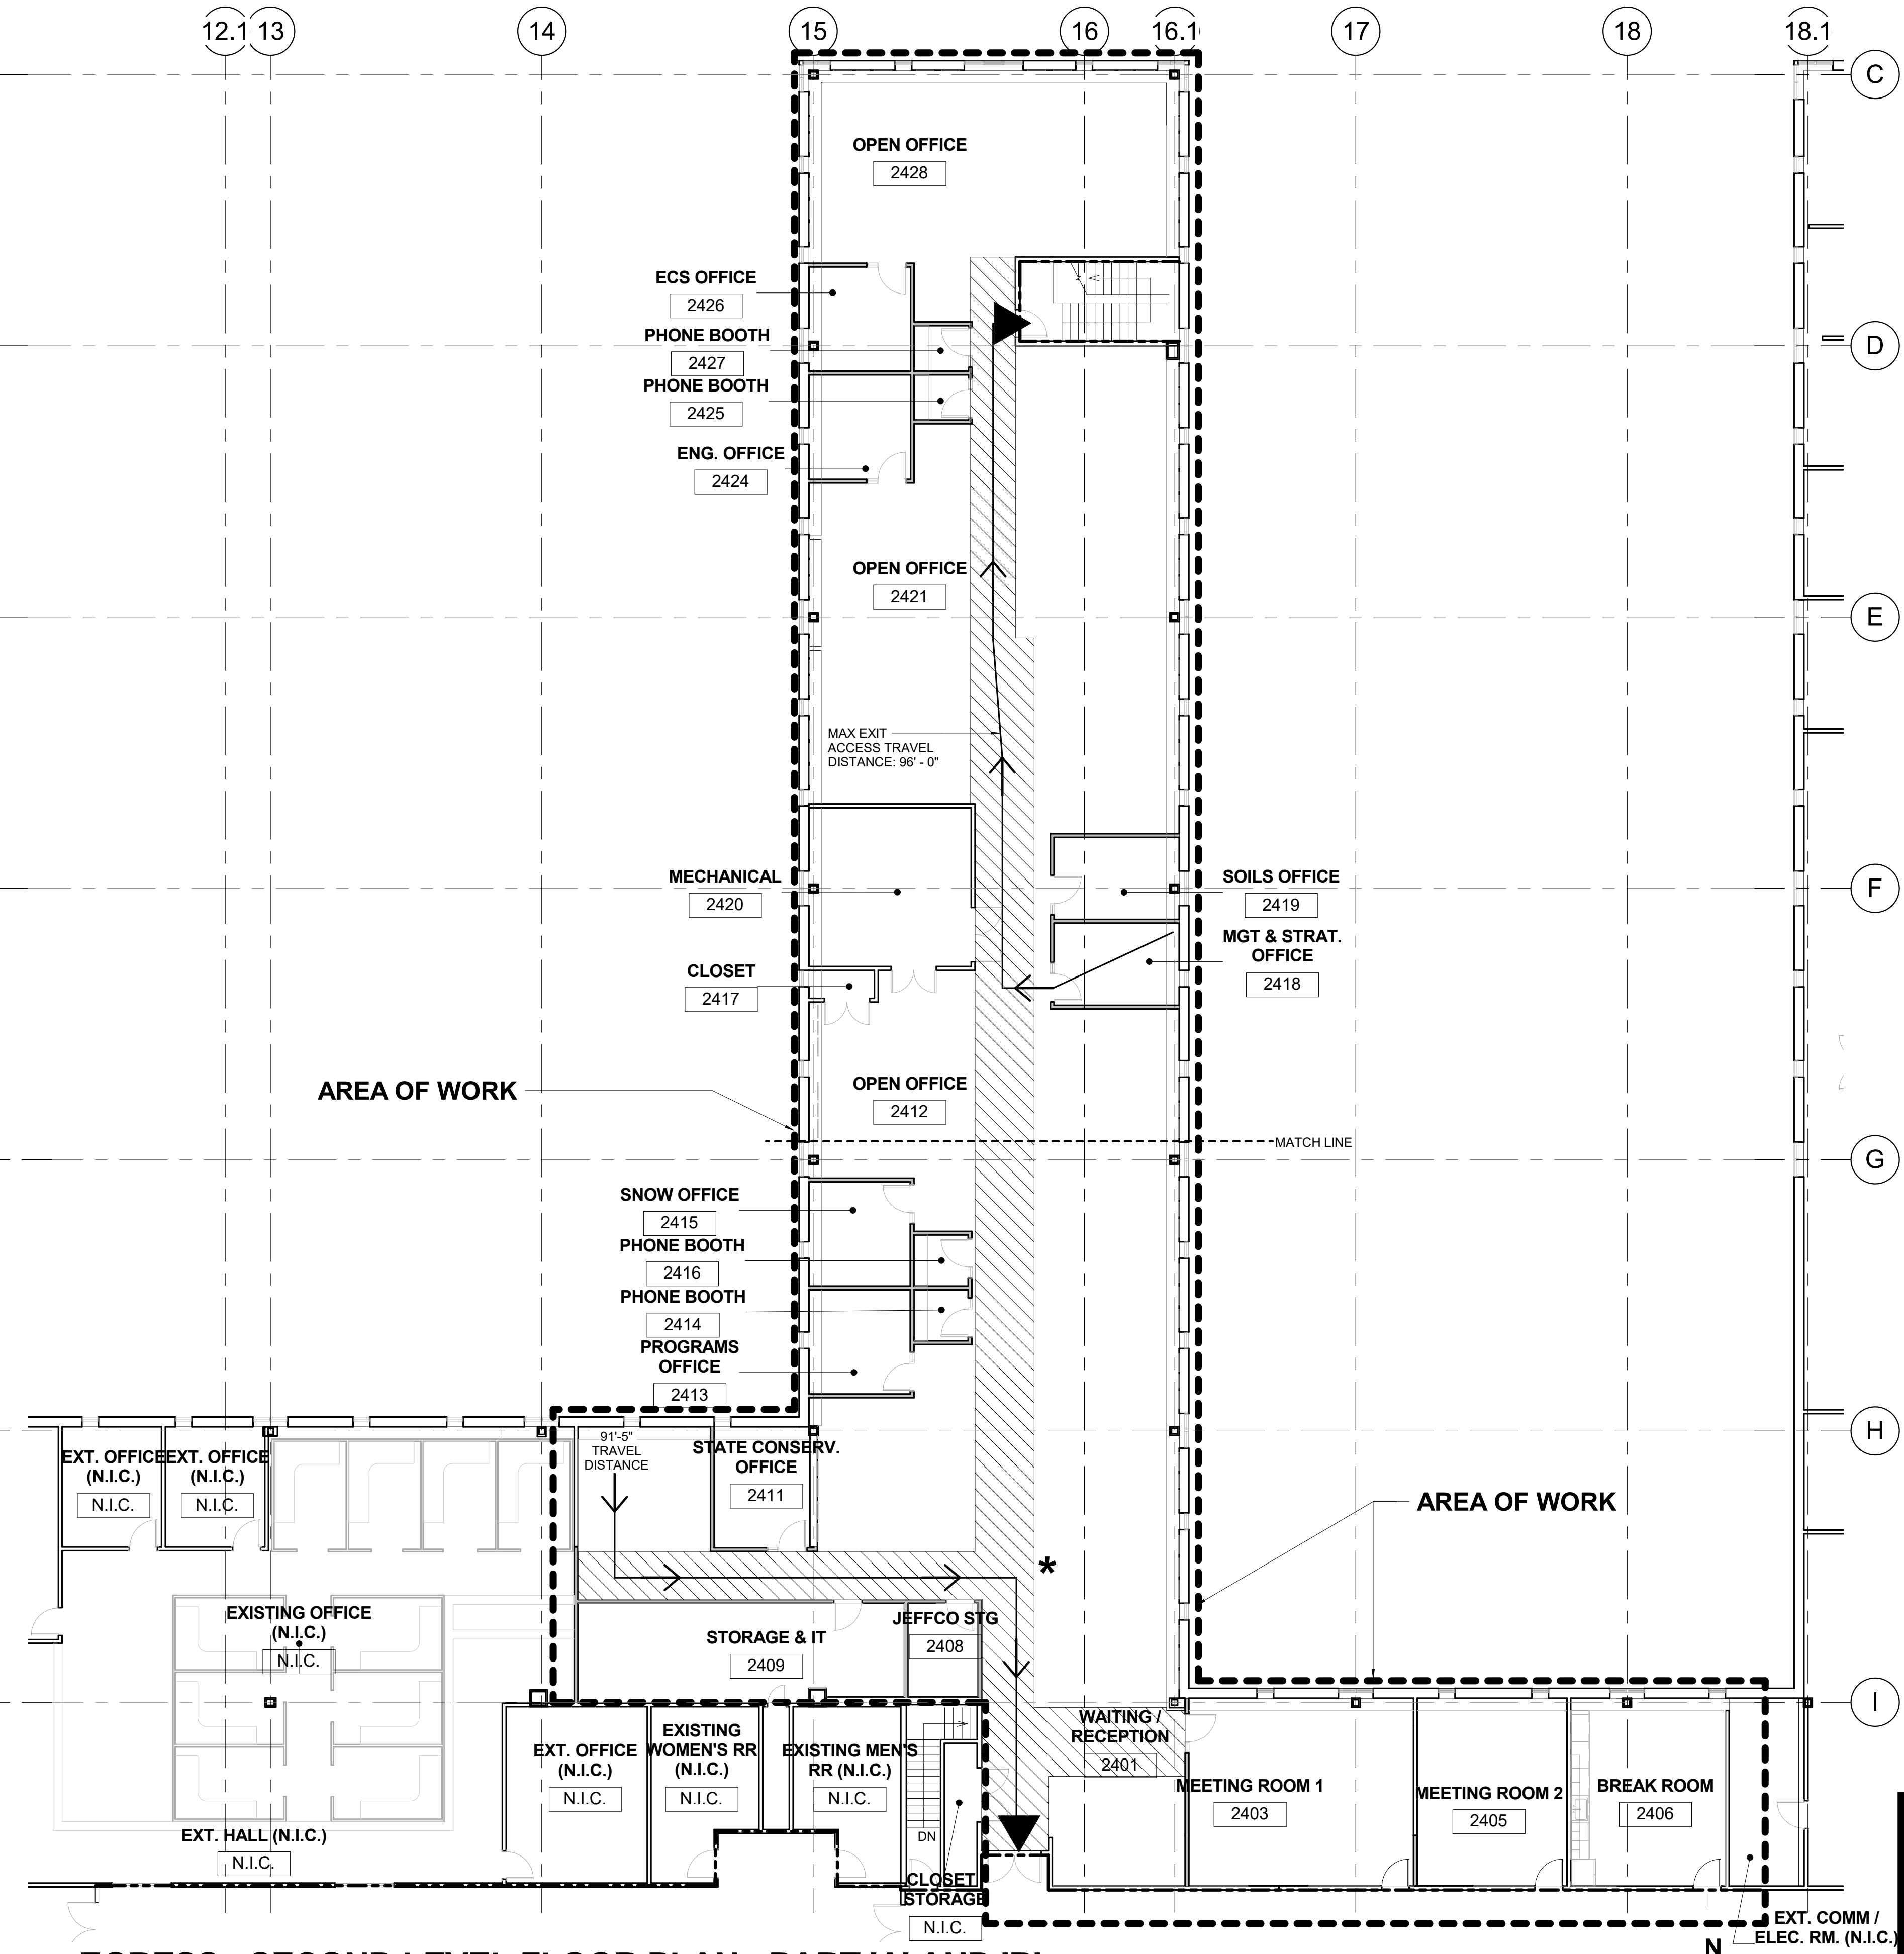


EGRESS - SECOND LEVEL FLOOR PLAN - PART 'A' AND 'B'
 3/32" = 1'-0"


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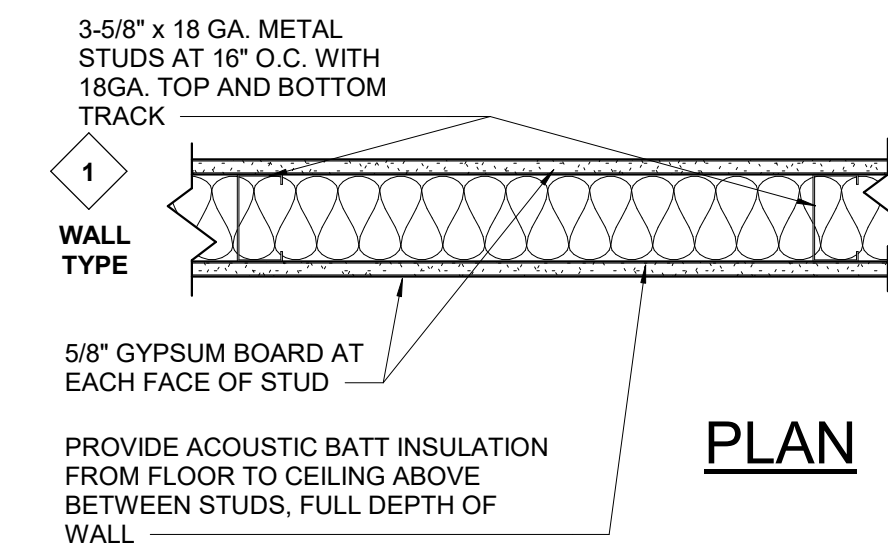
2 CEILING TYPE C1 - Typical ACT Ceiling
1 1/2" = 1'-0"

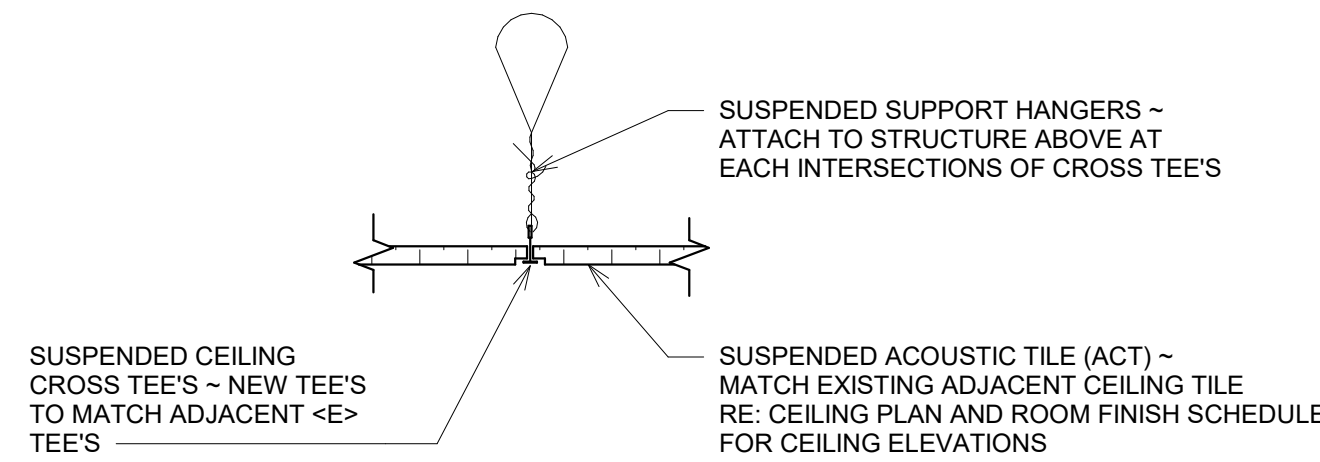

SECTION

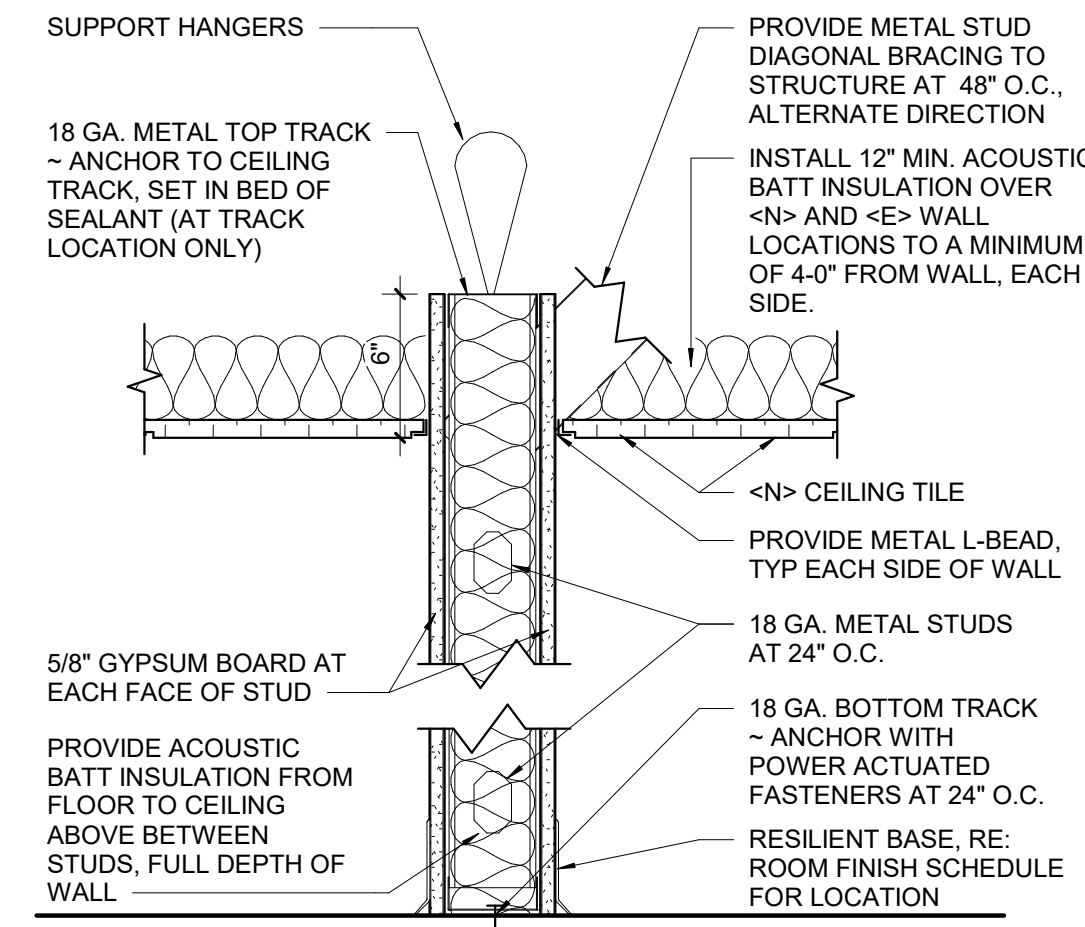


SECTION

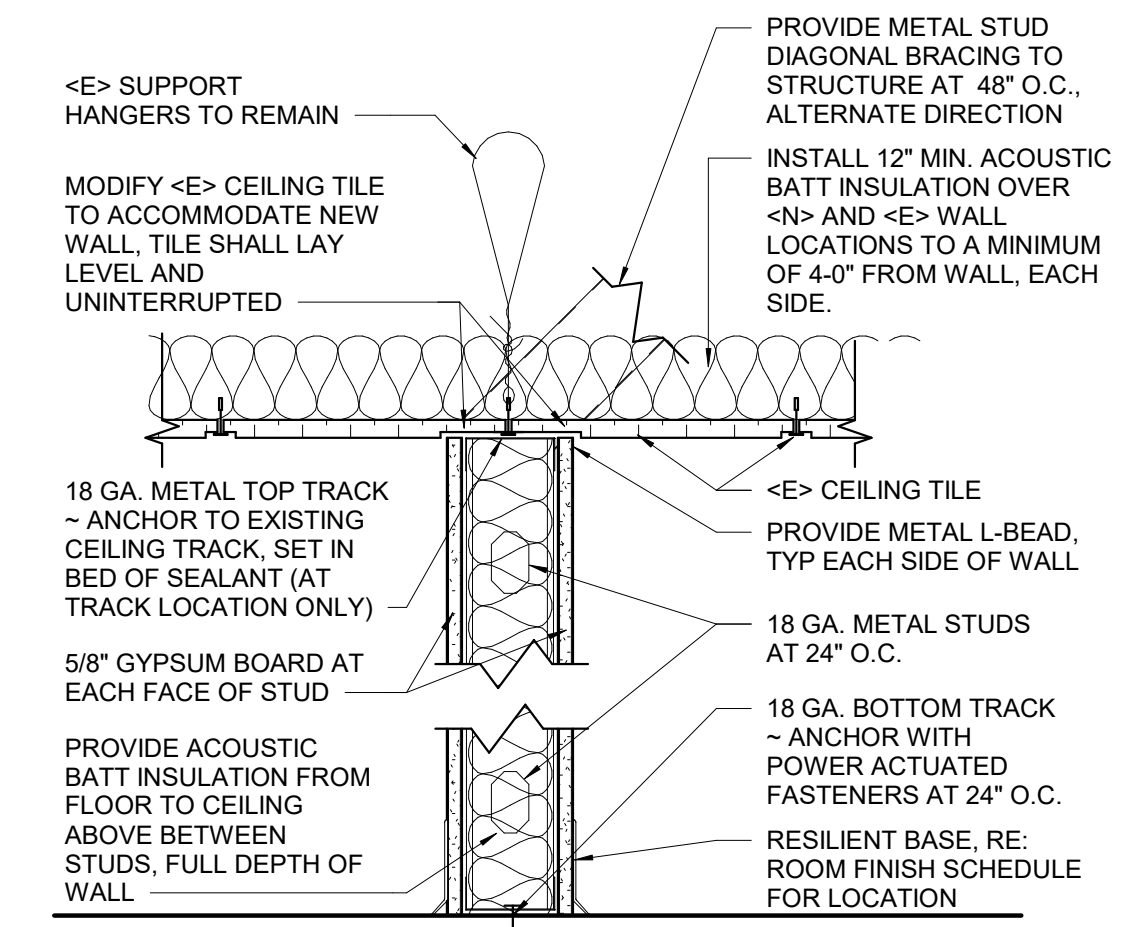


UN-RATED

1.1 = SAME AS WALL TYPE WT1, WALL CONSTRUCTED WITH 6" 18GA. METAL STUDS AT 16" O.C. WITH TOP AND BOTTOM TRACKS

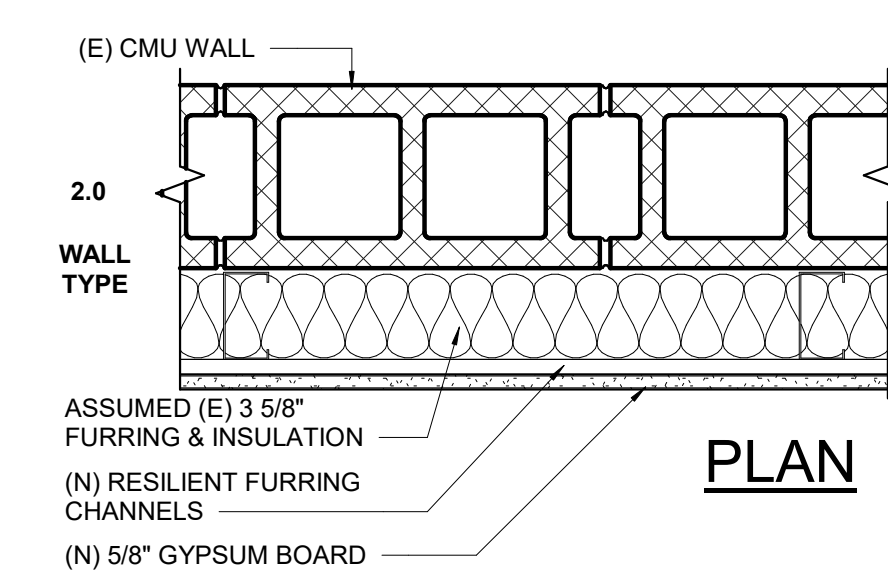

UN-RATED

2 HR FIRE RATED
UL UL404B
NOTE: CONTRACTOR TO VERIFY (E) WALL ASSEMBLY IN FIELD. NOTIFY ARCHITECT IF DIFFERENT THAN DRAWN.

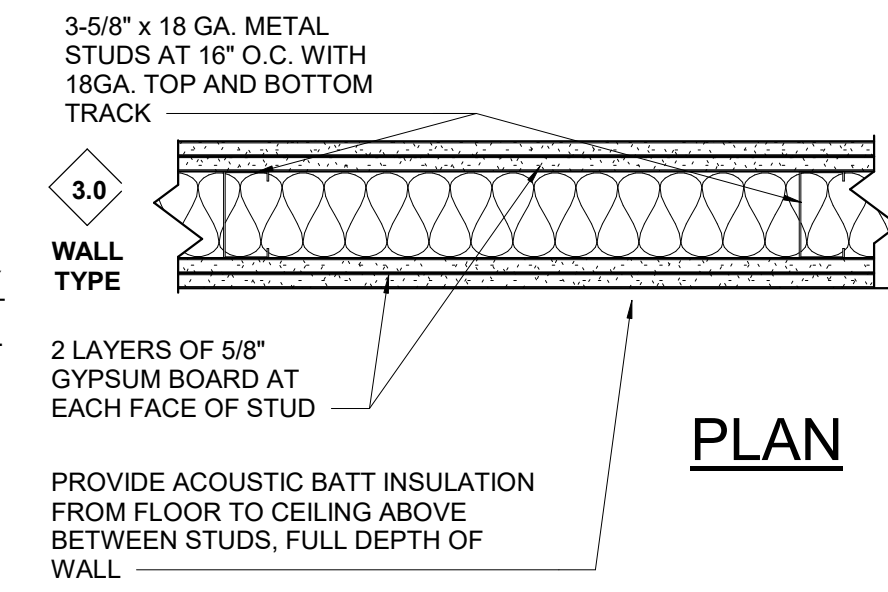


UN-RATED 3.1 = SAME AS WALL TYPE WT1, WALL - NO ACOUSTIC BATT INSULATION

1 WALL TYPES
1 1/2" = 1'-0"

100% CONSTRUCTION DOCUMENTS
*BUILDING 56 - 2ND FLOOR
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GENERAL SERVICES ADMINISTRATION
GSA
Project Manager
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Principal: **Dave Anderson**
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CERTIFICATION

KEY PLAN

REVISION NOTES

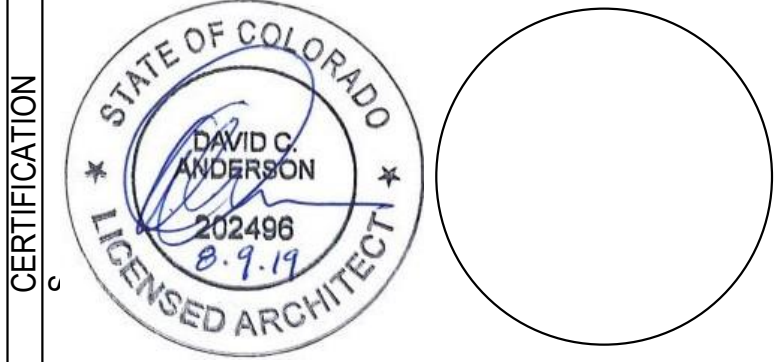MARK	DATE	DESCRIPTION

GRAPHIC SCALE


CONTRACTORS

BUILDING


PROJECT

DRAWING

A/E CON. NO.	GS-08P-JB-D-0017
A/E TASK NO.	EP-GS-P-08-16-JB-7053
CONS. CONTR.	GS-08P-13-JB-D-0032
CONS. WORK	
PRIM A/E	ANDERSON HALLAS ARCHITECTS PC
SUB A/E	
CONSTR. CON.	
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PROJECT DESCRIPTION	BUILDING 56 - 2ND FLOOR NRCS CONSOLIDATION
PROJECT NO.	EP-GS-P-08-16-JB-7053
GSA PM	BEN REKO
SUBMISSION	100 CD ISSUE
SUB. DATE	07/25/2019
DRAWING TITLE	WALL TYPES CEILING TYPES
FILE NAME	
FLOOR NO.	
DRAWN BY	DAM / LB DATE DRAFTED: 04/15/2019
CHECKED BY	DCA / RS SHEET SIZE: 22X34
DRAWING NO.	G 0 04
DISCIPLINE	SHEET TYPE SEQUENCE
SHEET	4 OF 50

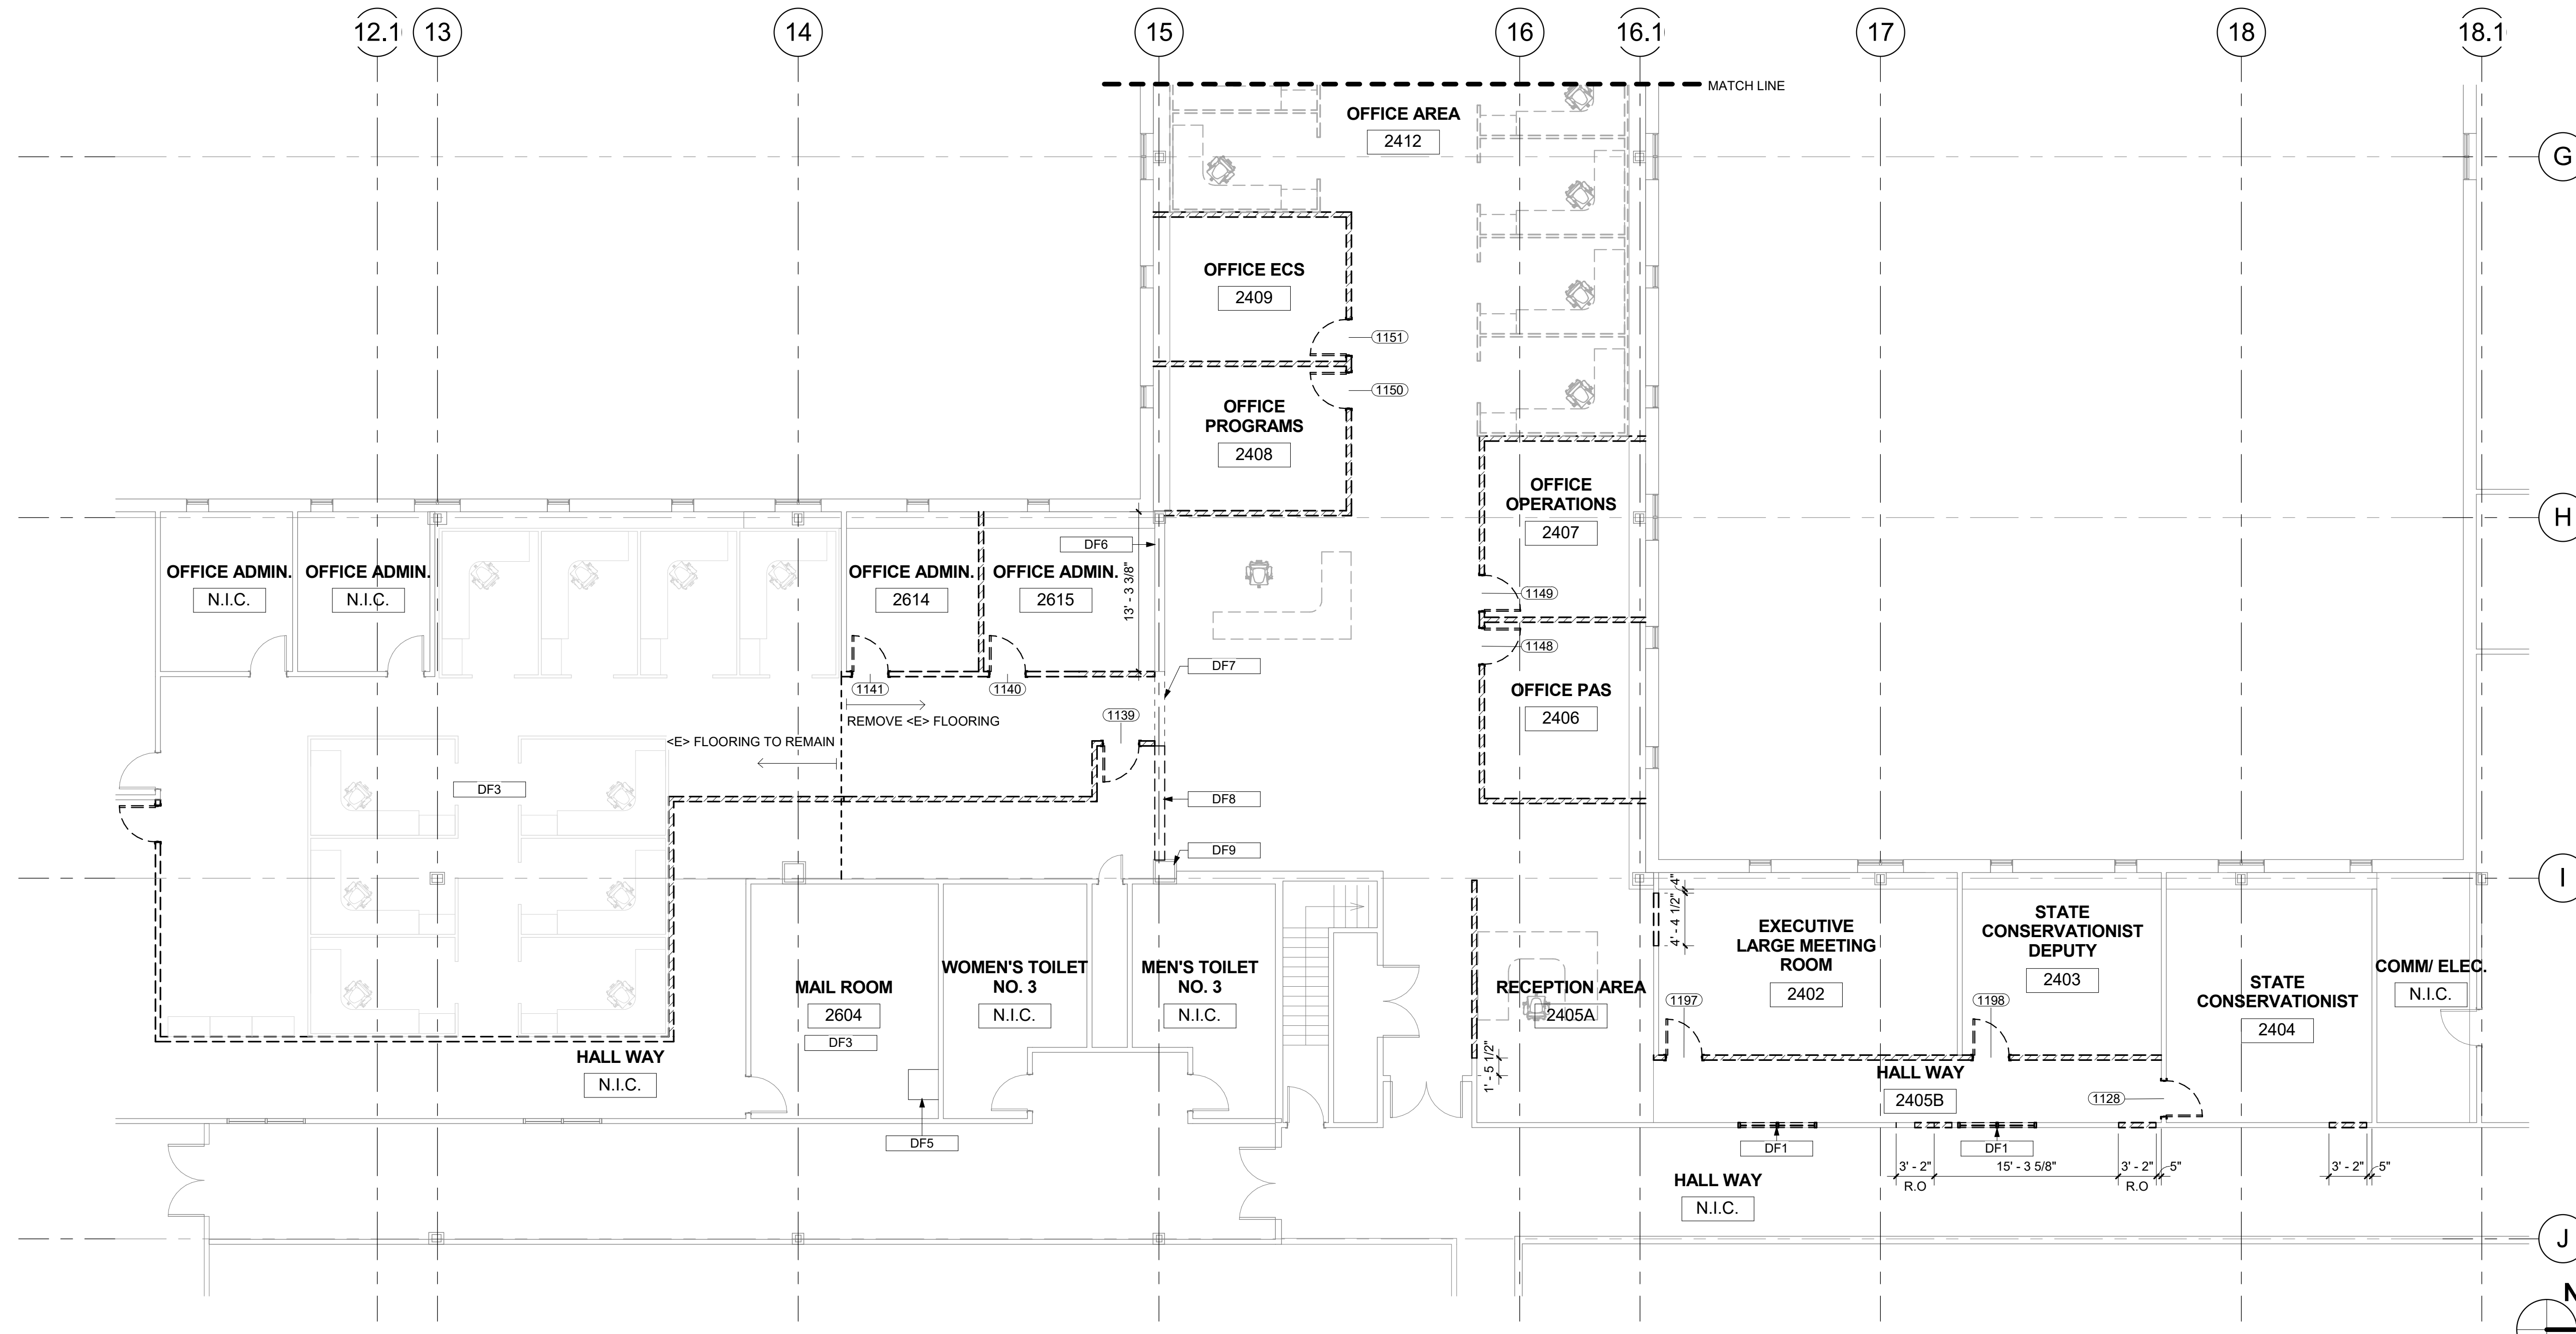

1 DEMO - SECOND LEVEL FLOOR PLAN - PART 'A'
1/8" = 1'-0"

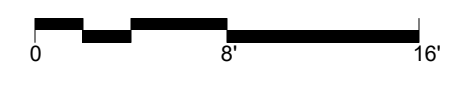

DEMO KEYNOTES	
Key Value	Keynote Text
DF1	REMOVE <E> INTERIOR WINDOW
DF3	<E> FINISHES TO REMAIN
DF5	COORDINATE RELOCATION OF IT EQUIPMENT WITH NRCS IT STAFF, RE: ELEC.
DF6	REMOVE (E) GWB, THIS SIDE
DF7	REMOVE (E) PORTION OF (E) MASONRY WALL (E) BEAM TO REMAIN
DF8	(E) SOFFIT TO REMAIN
DF9	(E) COLUMN TO REMAIN

DEMO LEGEND	
	WALL TO BE REMOVED IN ITS ENTIRETY
	DOOR TO BE REMOVED AND SALVAGED FOR REINSTALLATION
	KEYNOTE TAG
	DOOR TAG - DOOR TO BE SALVAGED FOR REUSE
	MATCH LINE


GENERAL AND SALVAGE NOTES:

- CAREFULLY REMOVE ALL <E> INTERIOR DOOR LEAVES FOR REINSTALLATION (13 TOTAL DOORS).
- COORDINATE REMOVAL AND REINSTALLATION OF MISC WALL MOUNTED ITEMS WITH OWNER
- CONTRACTOR TO COORDINATE REMOVAL/REUSE OF (E) CUBICLES, FURNITURE, & CASEWORK WITH NRCS & GSA
- REMOVE ALL FLOORING WITHIN AREA. SALVAGE <E> CARPET TO PATCH WHERE WALL REMOVED AT ADJACENT SPACE TO SOUTH.
- CAREFULLY REMOVE ALL <E> WINDOW COVERINGS. PROTECT & STORE FOR REINSTALLATION IN SAME LOCATION.
- ALL <E> EXTERIOR WINDOWS TO REMAIN, PROTECT IN PLACE.

100% CONSTRUCTION DOCUMENTS
*BUILDING 56 - 2ND FLOOR
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GENERAL SERVICES ADMINISTRATION Ben Reko Project Manager D.F.C. BUILDING 41 - SUITE 246 DENVER, COLORADO - 80255 303.236.0855 Phone / 720.412.2812 Cell benreko@gsa.gov																																																																																												
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8/8/2019 12:00:42 PM



1 DEMO - SECOND LEVEL FLOOR PLAN - PART 'B'

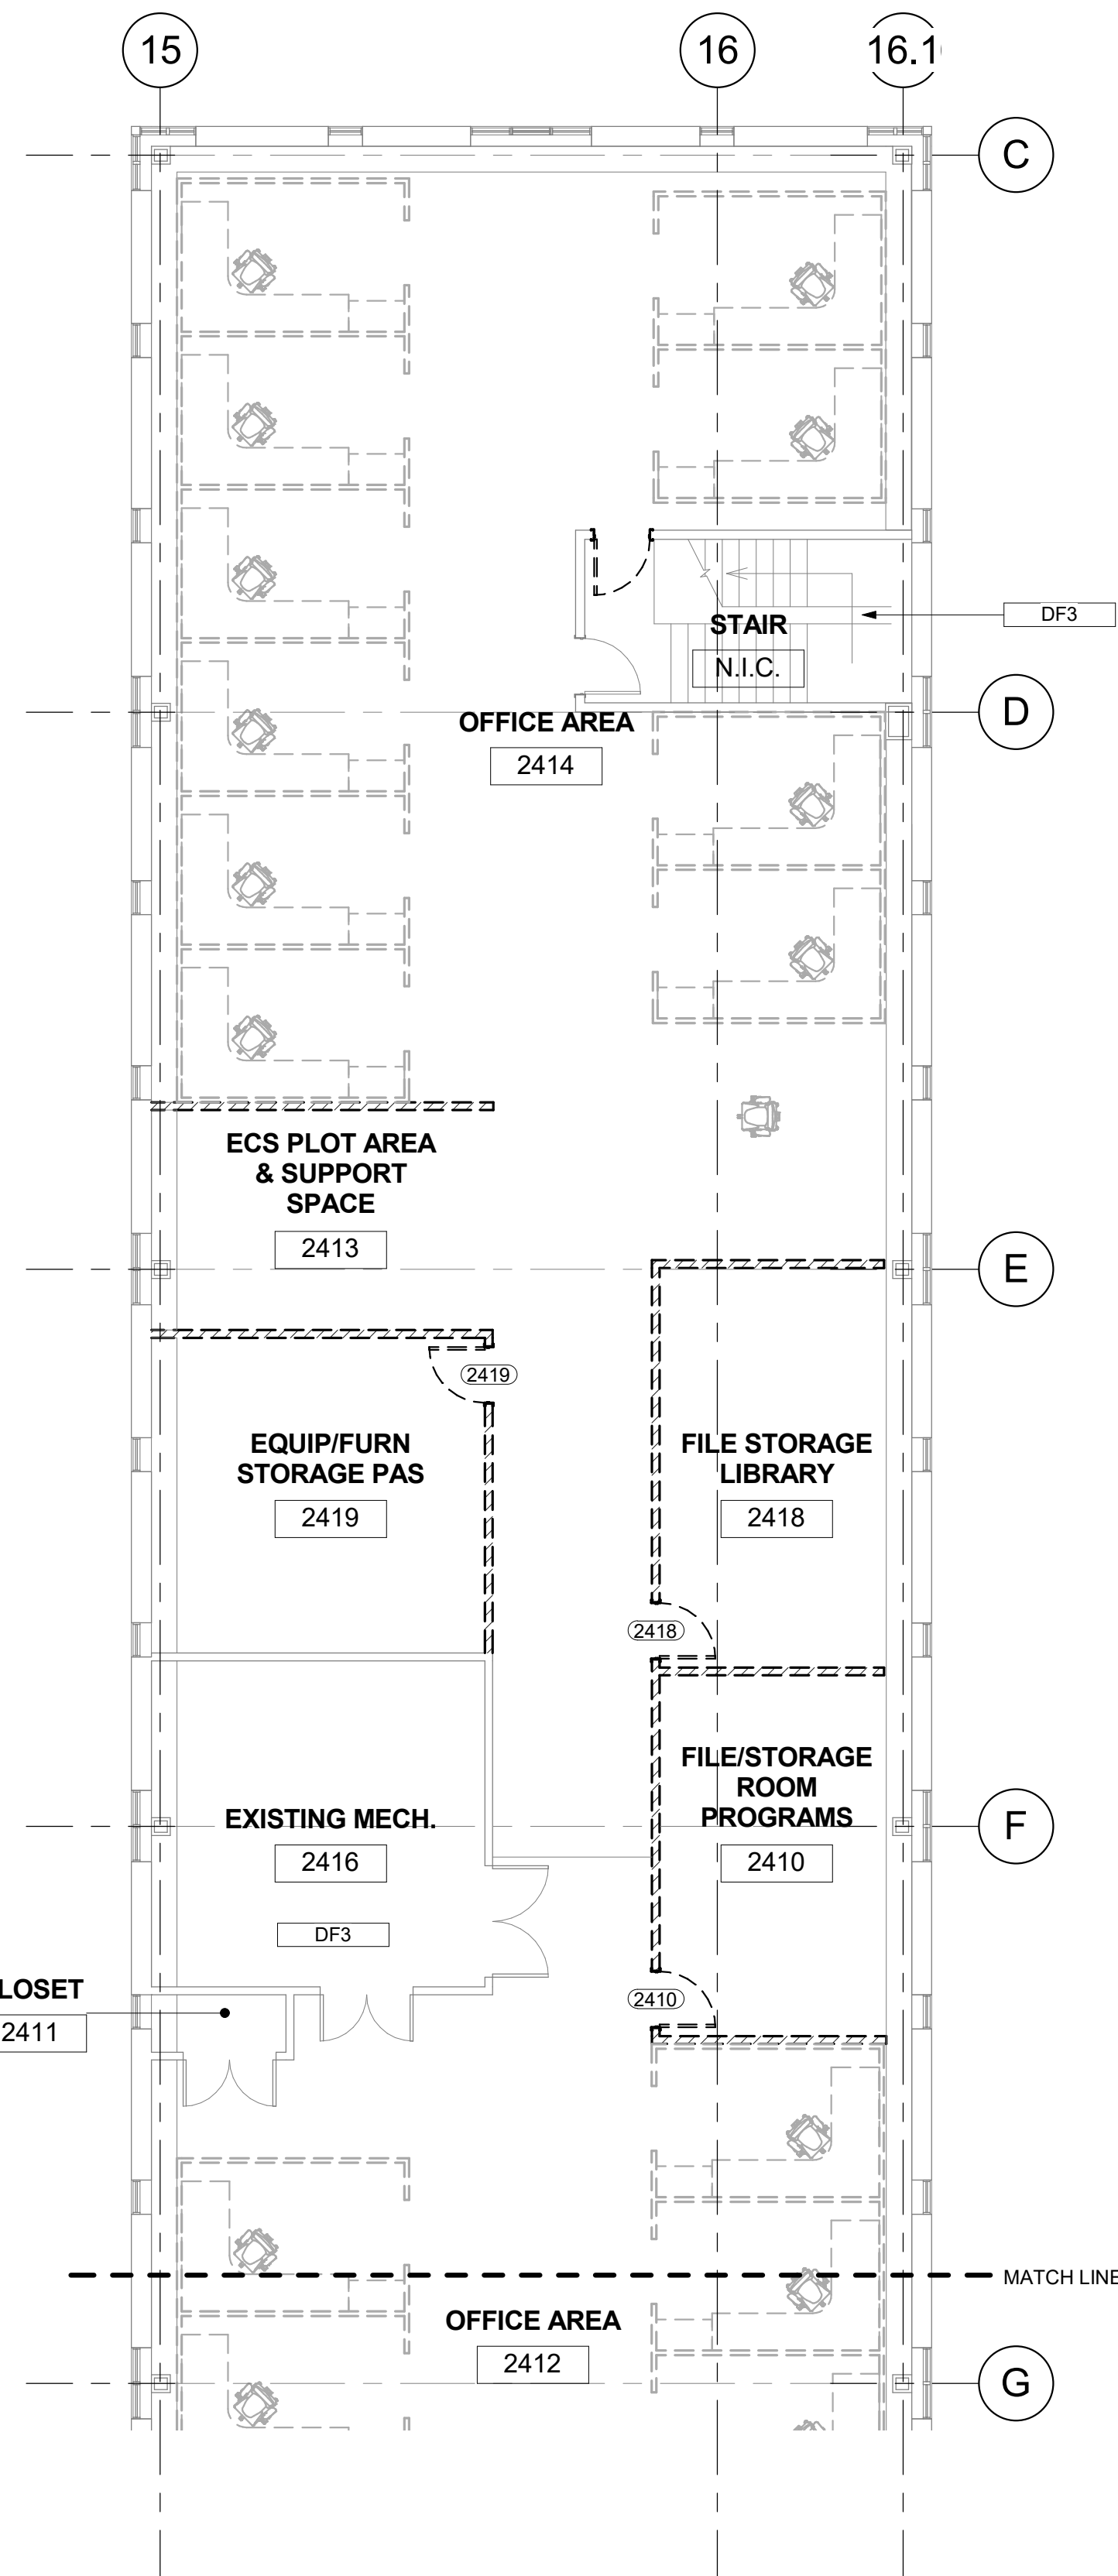1/8" = 1'-0"

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DEMO KEYNOTES

Key Value	Keynote Text
DF3	<E> FINISHES TO REMAIN

DEMO LEGEND

- ▧ WALL TO BE REMOVED IN ITS ENTIRETY
- DOOR TO BE REMOVED AND SALVAGED FOR REINSTALLATION
- XX KEYNOTE TAG
- DOOR TAG - DOOR TO BE SALVAGED FOR REUSE
- - - - MATCH LINE

CERTIFICATION

KEY PLAN

2nd FLOOR KEY PLAN

MARK	DATE	DESCRIPTION



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A/E CON. NO.	GS-08P-JB-D-0017
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NAME	BUILDING 56
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BUILDING NO.	BUILDING 56
OTHER BUILDING NOS	
FACILITY CODE	

PROJECT	
PROJECT TITLE	BUILDING 56 - NRCS
PROJECT DESCRIPTION	BUILDING 56 - 2ND FLOOR NRCS CONSOLIDATION
PROJECT NO.	EP-GS-P-08-16-JB-7053
GSA PM	BEN REKO
SUBMISSION	100 CD ISSUE
SUB. DATE	07/25/2019
DRAWING TITLE	ENLARGED DEMO FLOOR PLAN - PART 'B'
FILE NAME	
FLOOR NO.	2ND FLOOR
DRAWN BY	DAM / LB DATE DRAFTED: 04/15/2019
CHECKED BY	DCA / RS SHEET SIZE: 22X34
DRAWING NO.	A 4 02
DISCIPLINE	SHEET TYPE SEQUENCE
SHEET	6 OF 50

100% CONSTRUCTION DOCUMENTS


BUILDING 56 - 2ND FLOOR
NRCS CONSOLIDATION
-- FOR CONSTRUCTION --

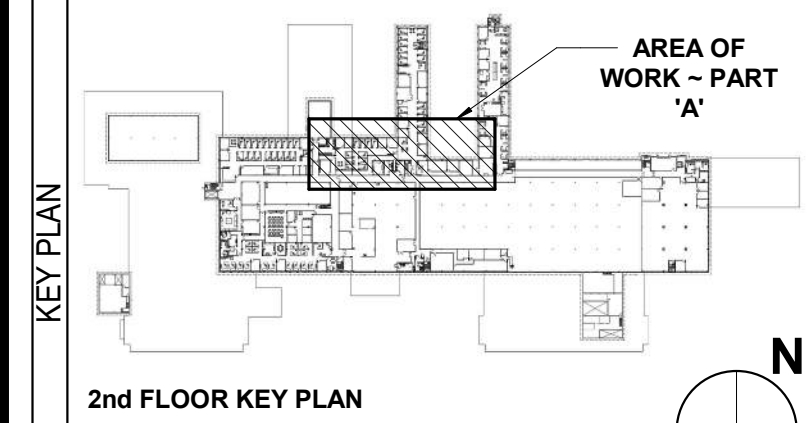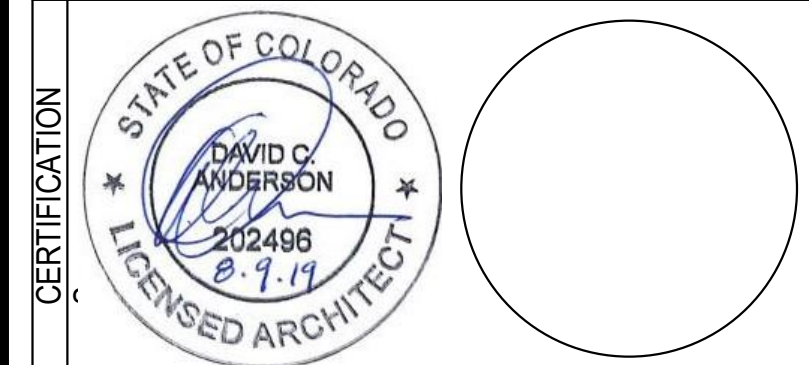



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PROJECT NO.	EP-GS-P-08-16-JB-7053
GSA PM	BEN REKO
SUBMISSION	100 CD ISSUE
SUB. DATE	07/25/2019
DRAWING TITLE	ENLARGED NEW FLOOR PLAN - PART 'A'
FILE NAME	
FLOOR NO.	2ND FLOOR
DRAWN BY	DAM / LB DATE DRAFTED: 04/15/2019
CHECKED BY	DCA / RS SHEET SIZE: 22X34
DRAWING NO.	A 4 03
DISCIPLINE	SHEET TYPE SEQUENCE
	SHEET 7 OF 50



1 NEW - SECOND LEVEL FLOOR PLAN - PART 'A'
1/8" = 1'-0"

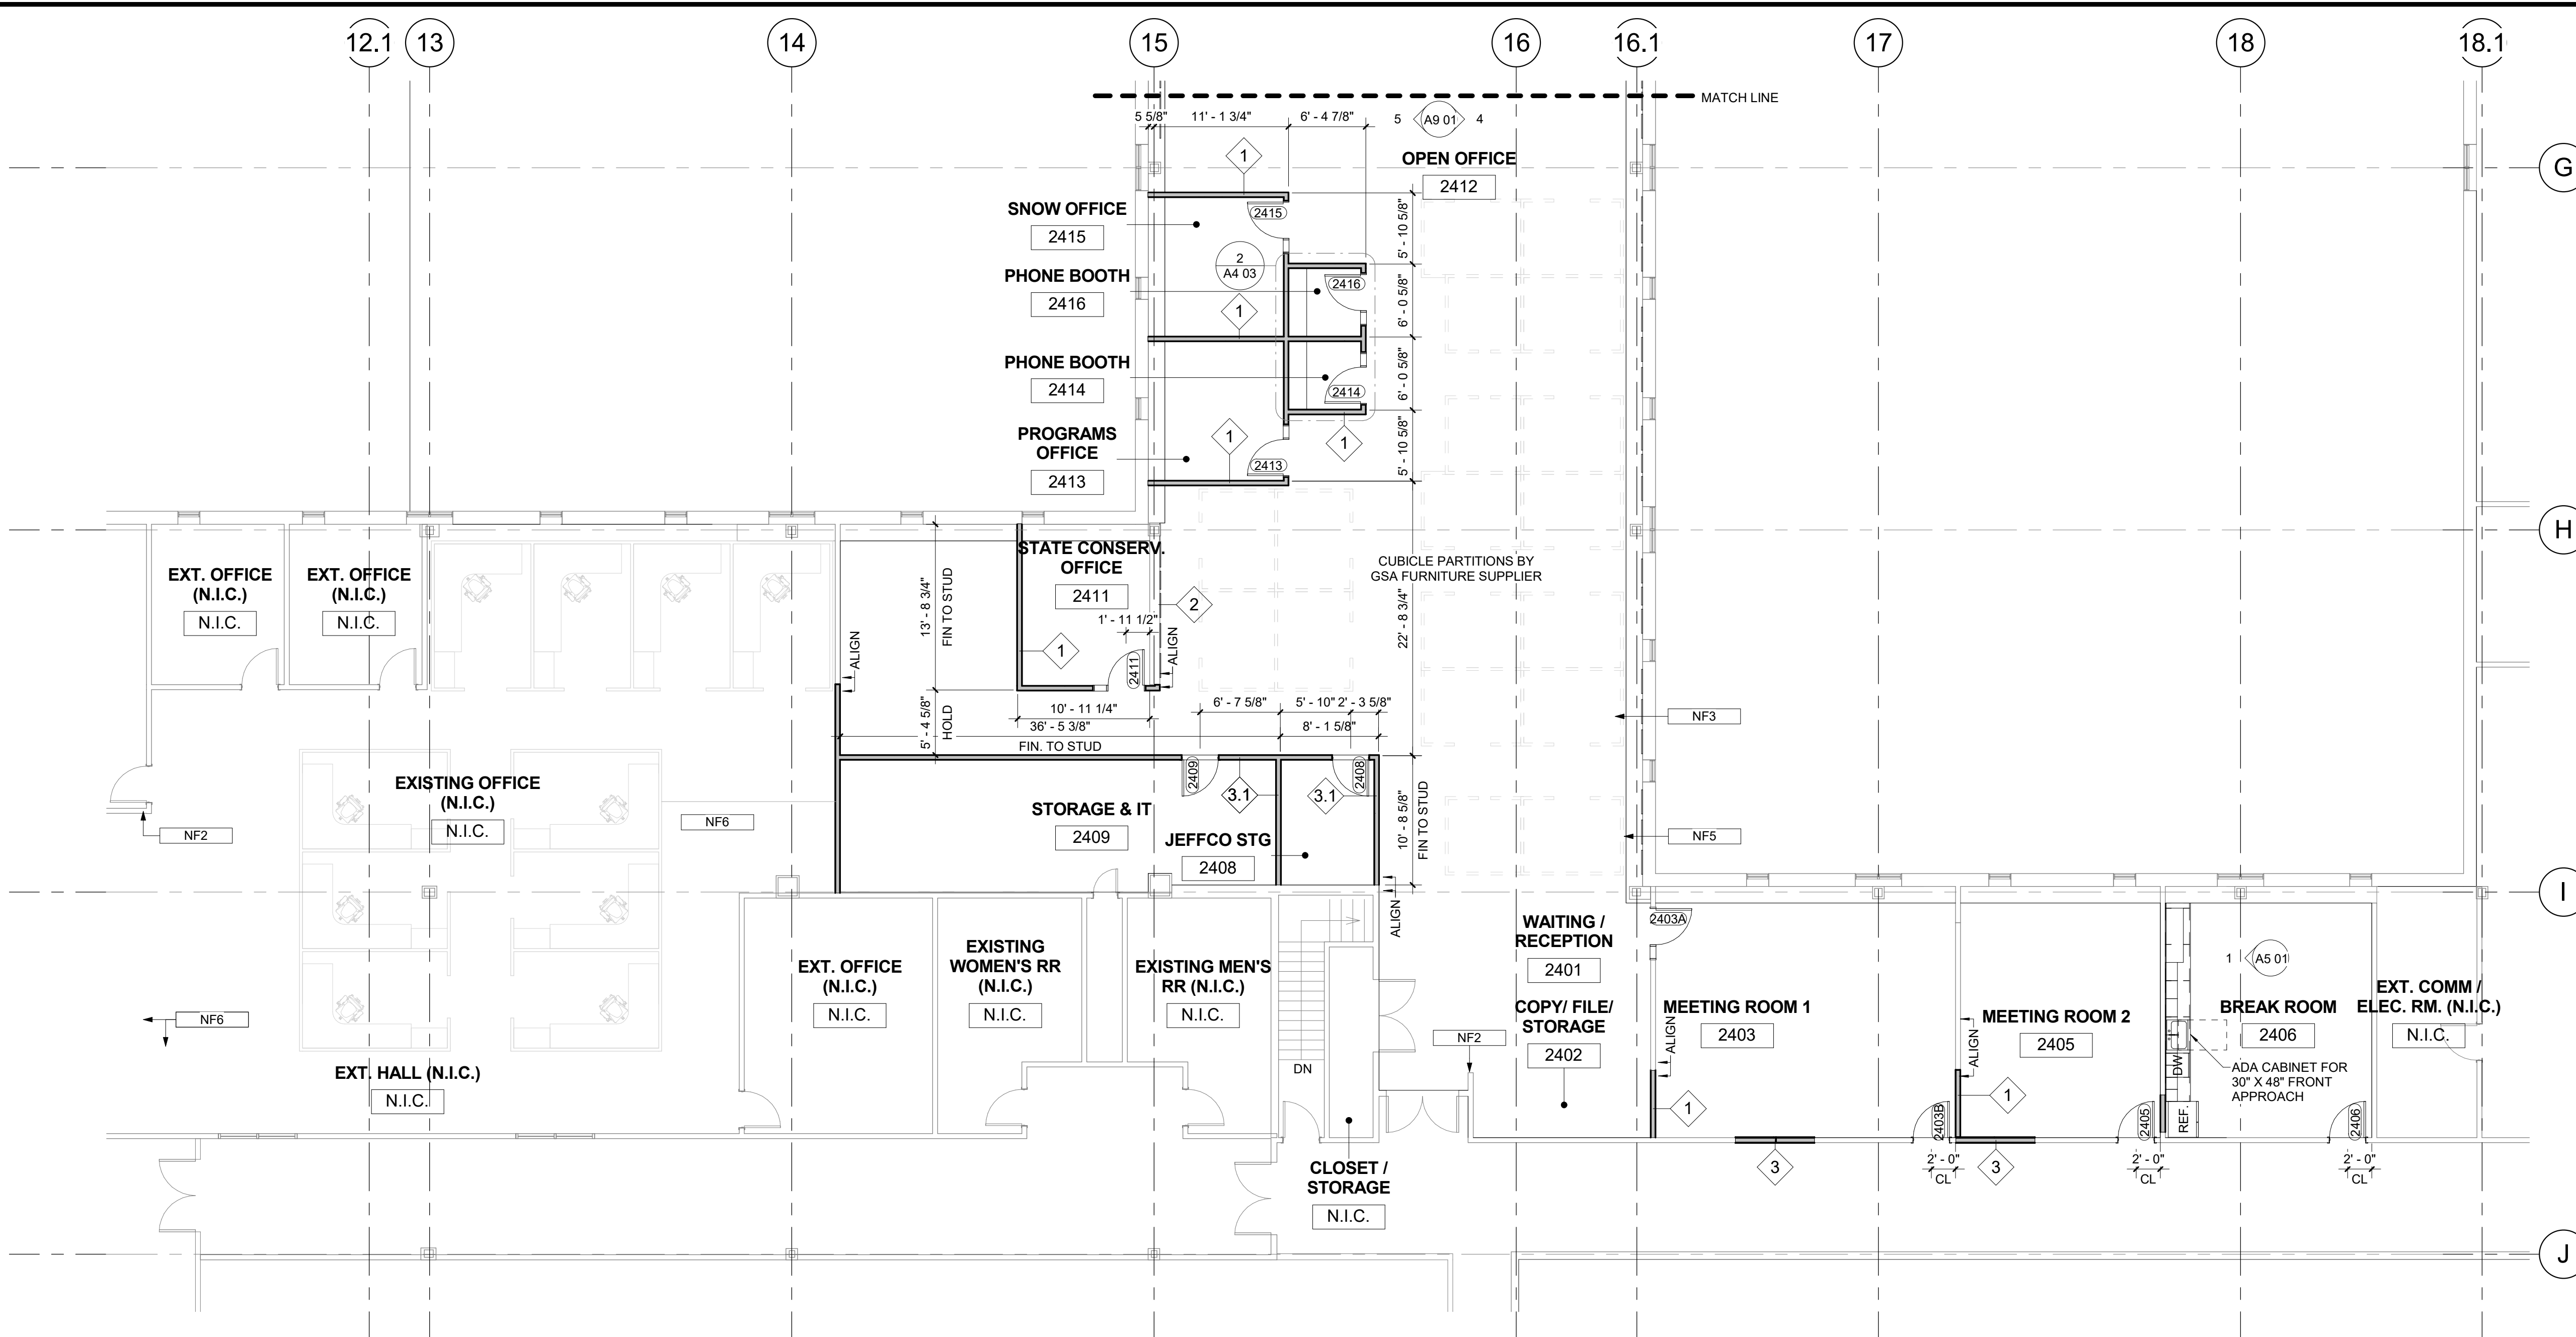

2 ENLARGED PLAN - PHONE BOOTHS
1/4" = 1'-0" ROOMS 2425 & 2427 SIMILAR

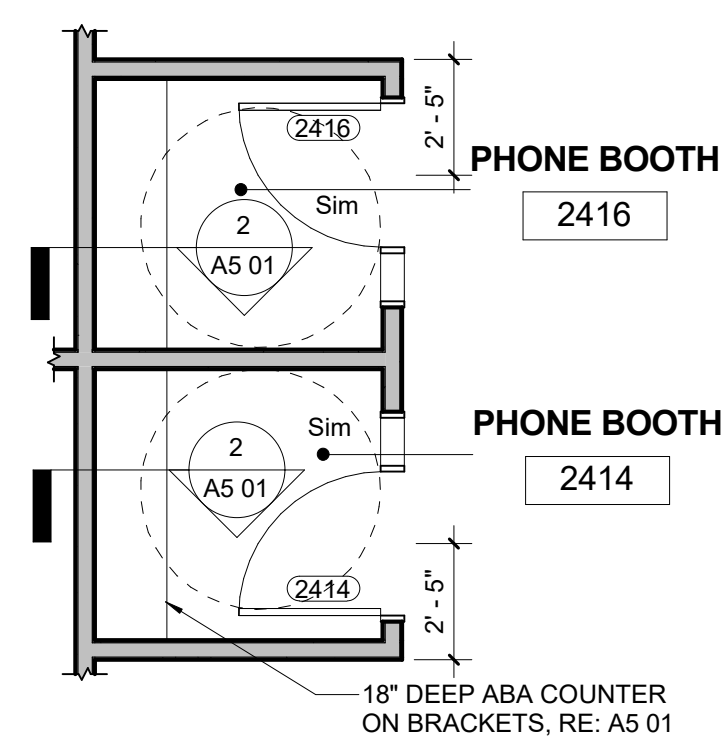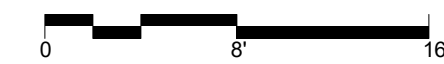PLAN LEGEND

- (N) WALL, RE: TAG FOR TYPE
- WALL TYPE TAG
- KEYNOTE TAG
- DOOR TAG
- MATCH LINE


NEW KEYNOTES

Key Value	Keynote Text
NF2	PATCH END OF WALL MATCH (E) ADJACENT FINISH
NF4	INFILL (E) OPENING WHERE DOOR WAS REMOVED. MATCH (E) ADJACENT WALL ASSEMBLY; ASSUMED WALL TYPE 3.
NF6	PATCH/REPAIR EXISTING FLOORING AND CEILING TO MATCH (E) FINISH WHERE WALL IS REMOVED. USE SALVAGED CARPET FROM DEMO.

GENERAL PLAN NOTES

- REFER TO RCP, MECH, ELEC, AND PLUMBING FOR ADDITIONAL INFORMATION
- REINSTALL <E> WINDOW COVERINGS IN SAME LOCATION. PROTECT IN PLACE. TYP. ALL WINDOWS
- ALL FURNISHINGS AND SYSTEMS FURNITURE BY OWNER CONSULTANT. SHOWN FOR REFERENCE ONLY.
- COORDINATE RELOCATION OF IT EQUIPMENT W/ NRCS STAFF. REFER TO ELECTRICAL SHEETS FOR ADDITIONAL INFORMATION.
- DIMENSIONS TO CL OF DOORS IN (N) WALLS
- PREP SUB FLOOR FOR <N> FLOORING

100% CONSTRUCTION DOCUMENTS
BUILDING 56 - 2ND FLOOR
NRCS CONSOLIDATION
-- FOR CONSTRUCTION --

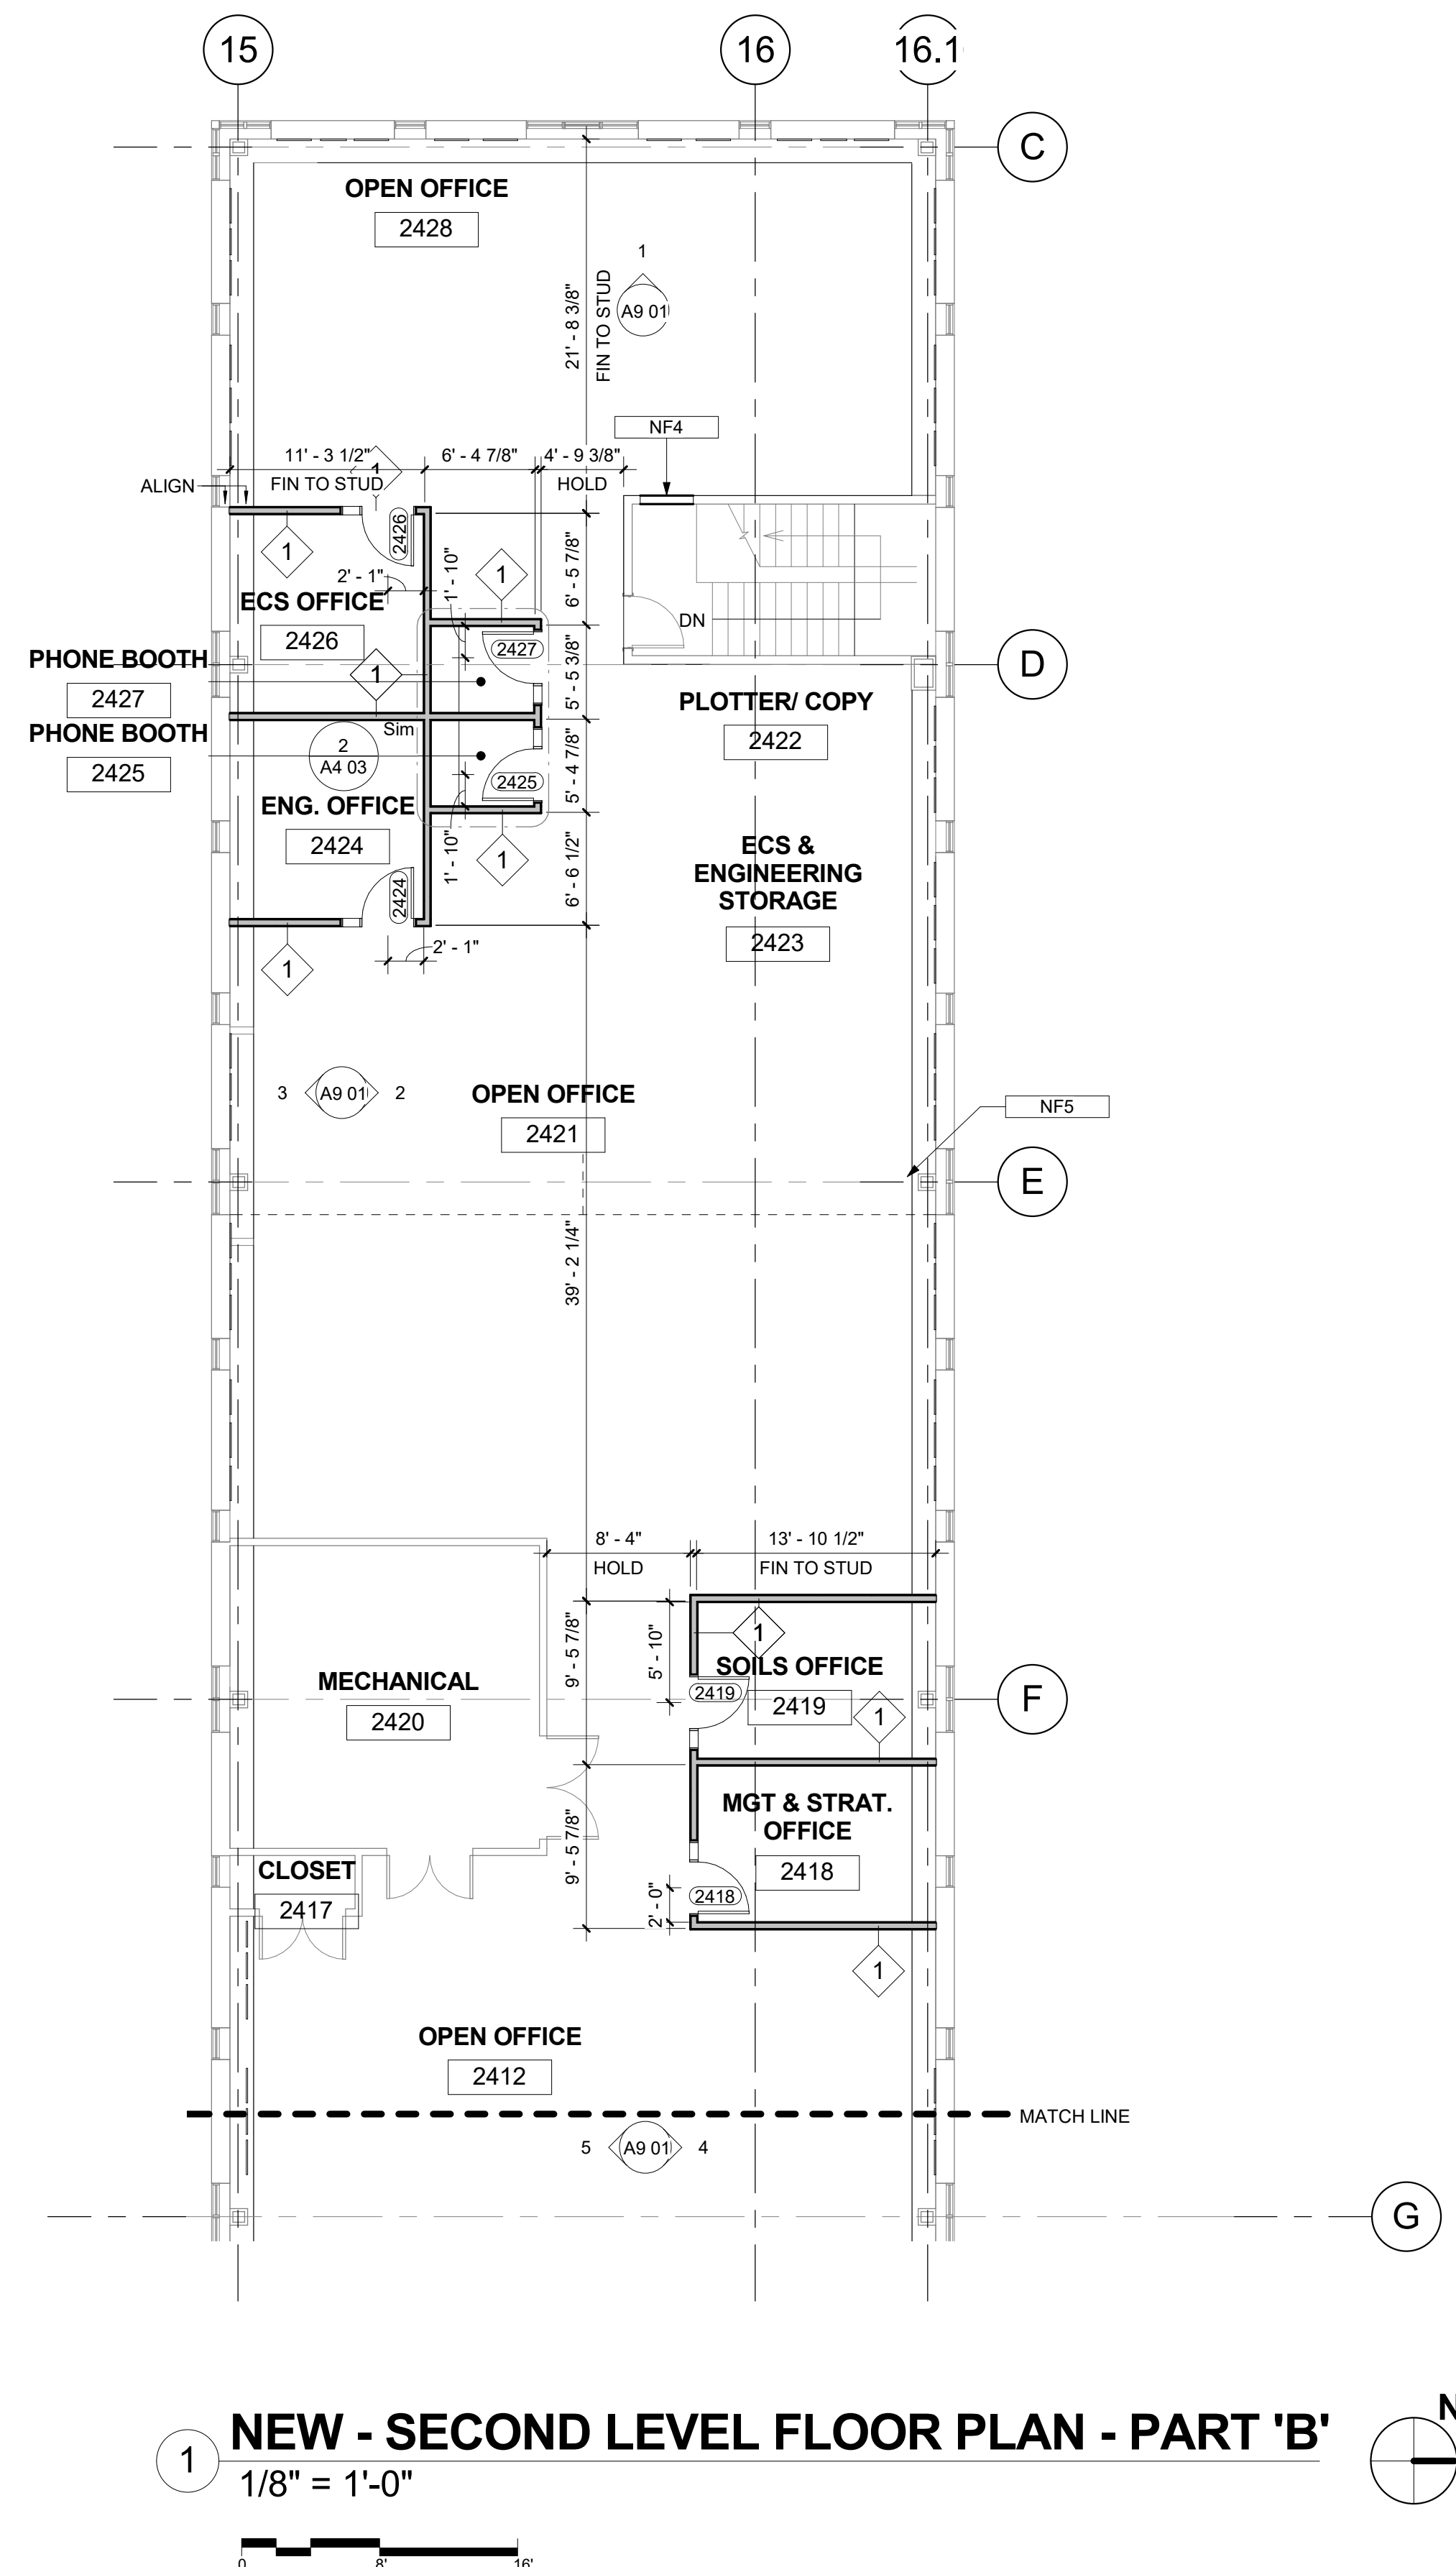

1 NEW - SECOND LEVEL FLOOR PLAN - PART 'B'
 1/8" = 1'-0"

GENERAL PLAN NOTES

1. REFER TO RCP, MECH, ELEC, AND PLUMBING FOR ADDITIONAL INFORMATION
2. REINSTALL <E> WINDOW COVERINGS IN SAME LOCATION. PROTECT IN PLACE. TYP. ALL WINDOWS
3. ALL FURNISHINGS AND SYSTEMS FURNITURE BY OWNER CONSULTANT. SHOWN FOR REFERENCE ONLY.
4. COORDINATE RELOCATION OF IT EQUIPMENT W/ NRCS STAFF. REFER TO ELECTRICAL SHEETS FOR ADDITIONAL INFORMATION.
5. DIMENSIONS TO CL OF DOORS IN (N) WALLS
6. PREP SUB FLOOR FOR <N> FLOORING



NEW KEYNOTES	
Key Value	Keynote Text
NF2	PATCH END OF WALL MATCH (E) ADJACENT FINISH
NF4	INFILL (E) OPENING WHERE DOOR WAS REMOVED. MATCH (E) ADJACENT WALL ASSEMBLY; ASSUMED WALL TYPE 3.
NF6	PATCH/REPAIR EXISTING FLOORING AND CEILING TO MATCH (E) FINISH WHERE WALL IS REMOVED. USE SALVAGED CARPET FROM DEMO.

PLAN LEGEND

- (N) WALL, RE: TAG FOR TYPE
- WALL TYPE TAG
- KEYNOTE TAG
- DOOR TAG
- MATCH LINE




100% CONSTRUCTION DOCUMENTS
 BUILDING 56 - 2ND FLOOR
 NRCS CONSOLIDATION
 -- FOR CONSTRUCTION --

	GENERAL SERVICES ADMINISTRATION Project Manager Ben Reko D.F.C. BUILDING 41 - SUITE 246 DENVER, COLORADO - 80255 303.236.0855 Phone / 720.412.2812 Cell benjamin.reko@gsa.gov																																	
ANDERSON HALLAS ARCHITECTS, PC 715 FOURTEENTH STREET GOLDEN, COLORADO 80401 (303) 278-4378 FAX (303) 278-0521 Principal: Dave Anderson AIA, LEED AP daveanderson@andarch.com																																		
CERTIFICATION 																																		
KEY PLAN 	AREA OF WORK - PART 'B' 																																	
REVISION NOTES <table border="1" style="width: 100%; border-collapse: collapse;"> <thead> <tr> <th>MARK</th> <th>DATE</th> <th>DESCRIPTION</th> </tr> </thead> <tbody> <tr><td> </td><td> </td><td> </td></tr> <tr><td> </td><td> </td><td> </td></tr> <tr><td> </td><td> </td><td> </td></tr> <tr><td> </td><td> </td><td> </td></tr> <tr><td> </td><td> </td><td> </td></tr> <tr><td> </td><td> </td><td> </td></tr> <tr><td> </td><td> </td><td> </td></tr> <tr><td> </td><td> </td><td> </td></tr> <tr><td> </td><td> </td><td> </td></tr> <tr><td> </td><td> </td><td> </td></tr> </tbody> </table>	MARK	DATE	DESCRIPTION																															GRAPHIC SCALE
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CONTRACTORS A/E CON. NO. GS-08P-JB-D-0017 A/E TASK NO. EP-GS-P-08-16-JB-7053 CONS. CONTR. GS-08P-13-JB-D-0032 CONS. WORK PRIM A/E ANDERSON HALLAS ARCHITECTS PC SUB A/E CONSTR. CON.	BUILDING NAME BUILDING 56 STREET 6TH STREET CITY/ST./ZIP DENVER, COLORADO 80255 BUILDING NO. BUILDING 56 OTHER BUILDING NOS FACILITY CODE																																	
PROJECT PROJECT TITLE BUILDING 56 - NRCS PROJECT DESCRIPTION BUILDING 56 - 2ND FLOOR NRCS CONSOLIDATION PROJECT NO. EP-GS-P-08-16-JB-7053 GSA PM BEN REKO SUBMISSION 100 CD ISSUE SUB. DATE 07/25/2019	DRAWING DRAWING TITLE ENLARGED NEW FLOOR PLAN - PART 'B' FILE NAME FLOOR NO. 2ND FLOOR DRAWN BY DAM / LB DATE DRAFTED: 04/15/2019 CHECKED BY DCA / RS SHEET SIZE: 22X34																																	
DRAWING NO. A 4 04 DISCIPLINE SHEET TYPE SEQUENCE SHEET 8 OF 50																																		

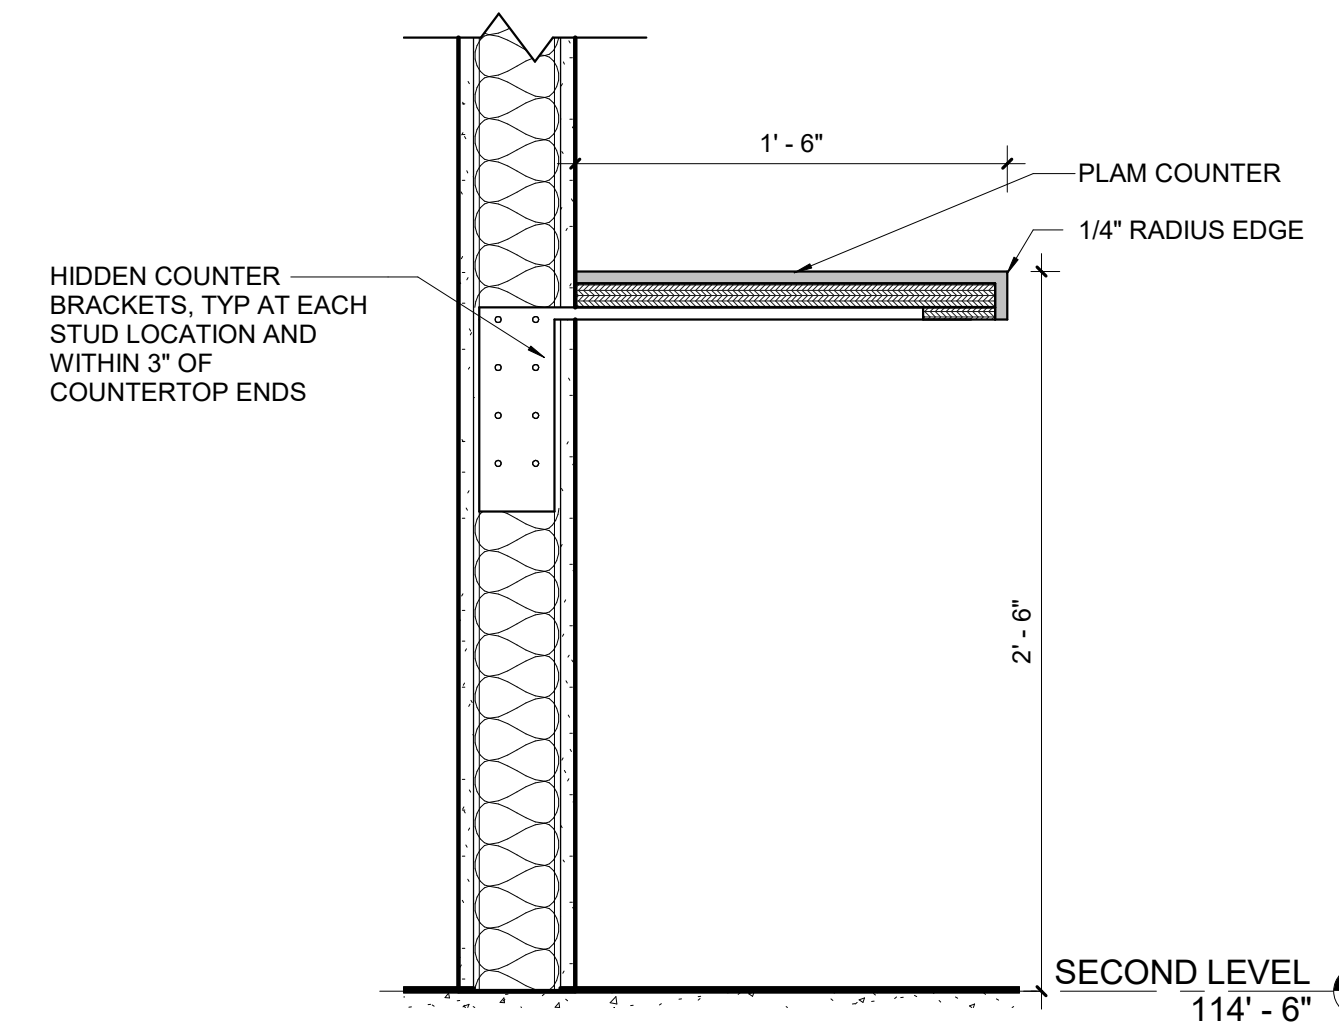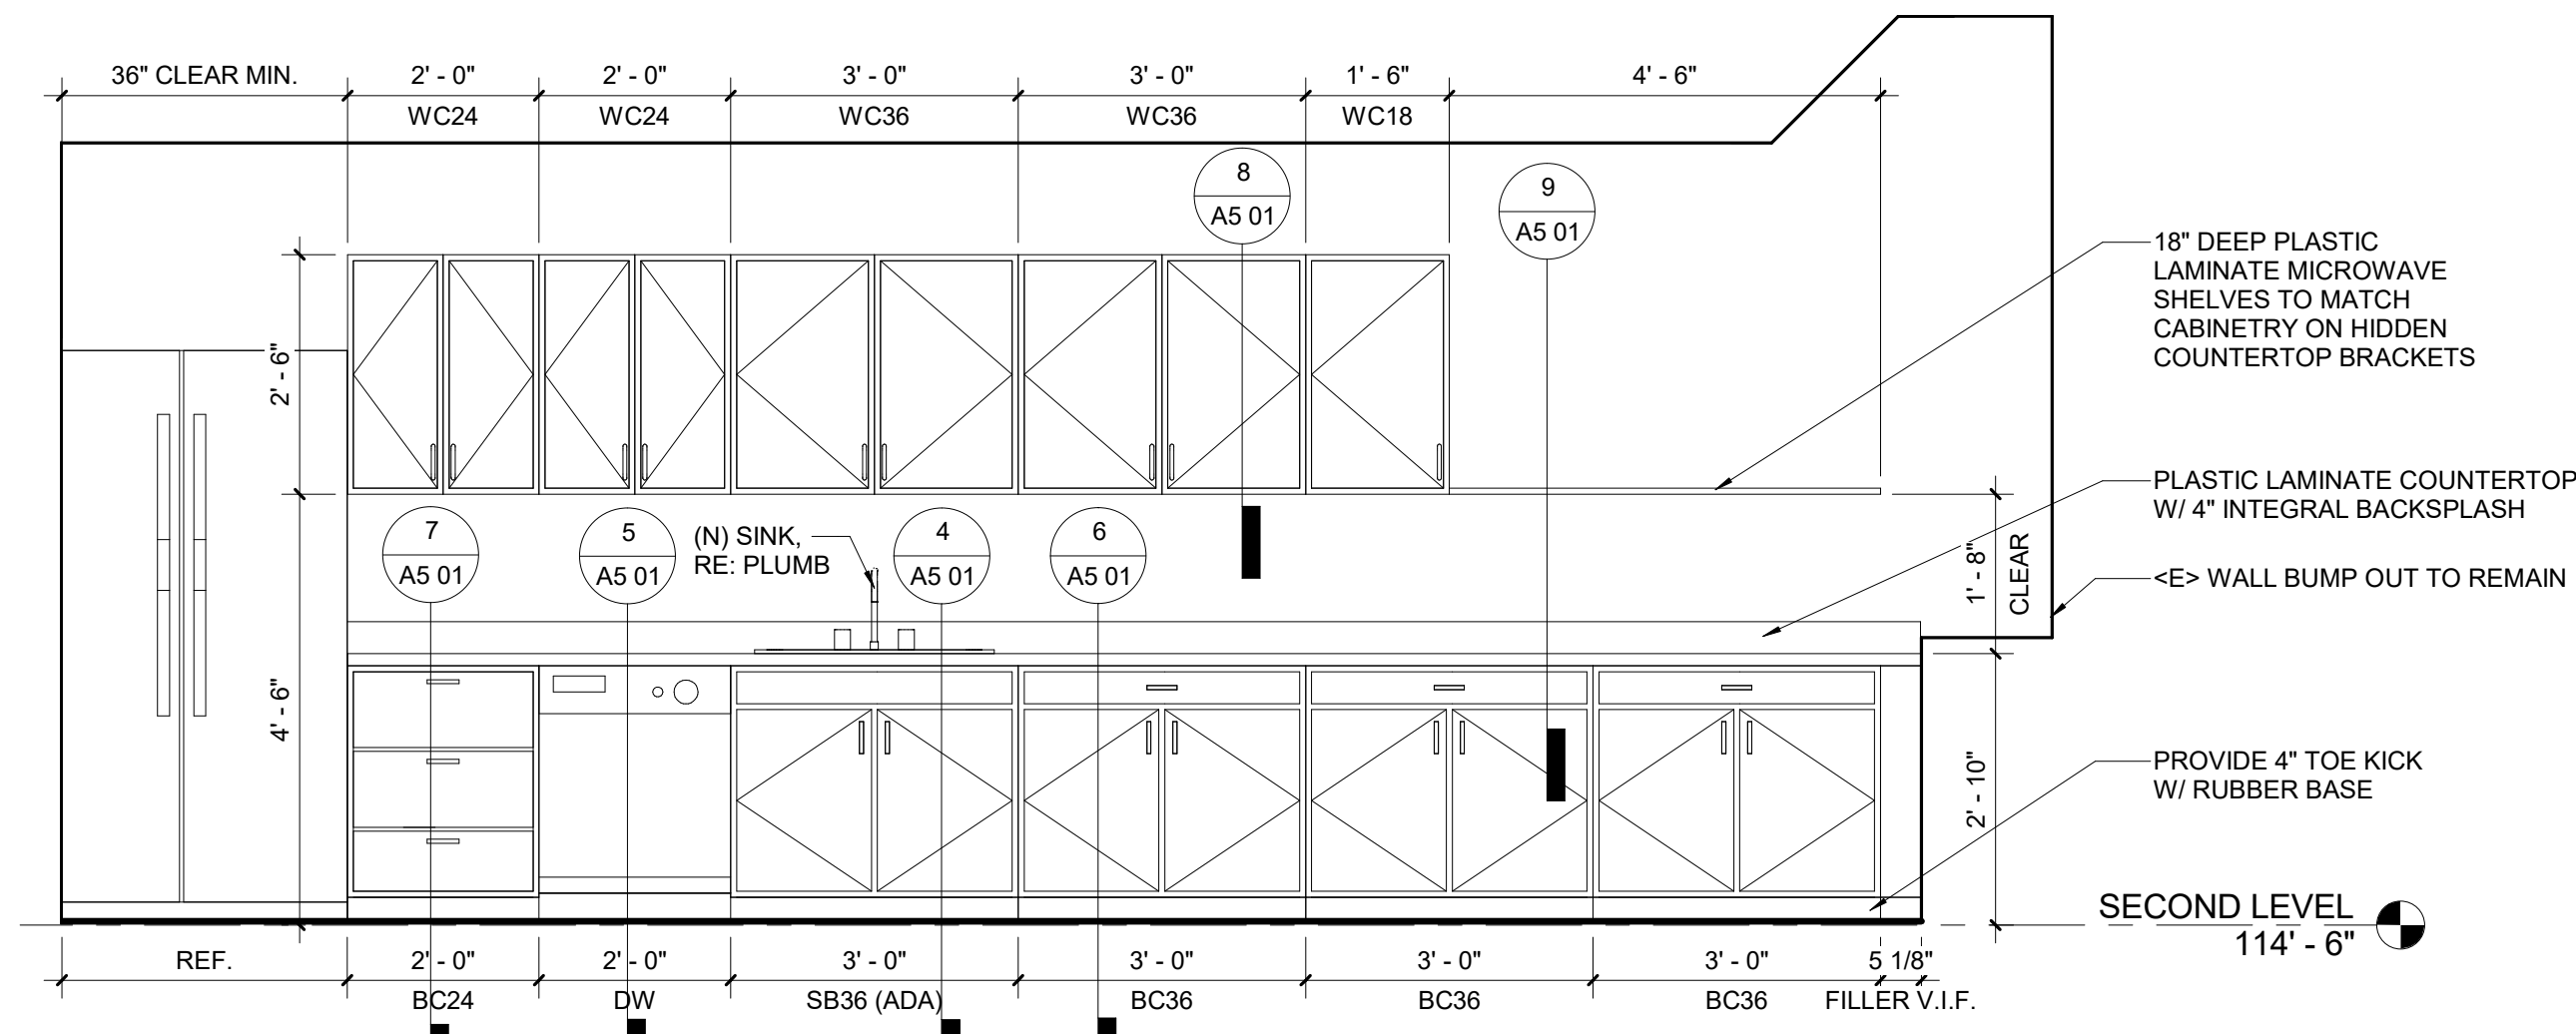

1 Break Room 2405 Elevation- South
1/2" = 1'-0"




2 SECTION @ PHONE BOOTH COUNTER
1 1/2" = 1'-0"

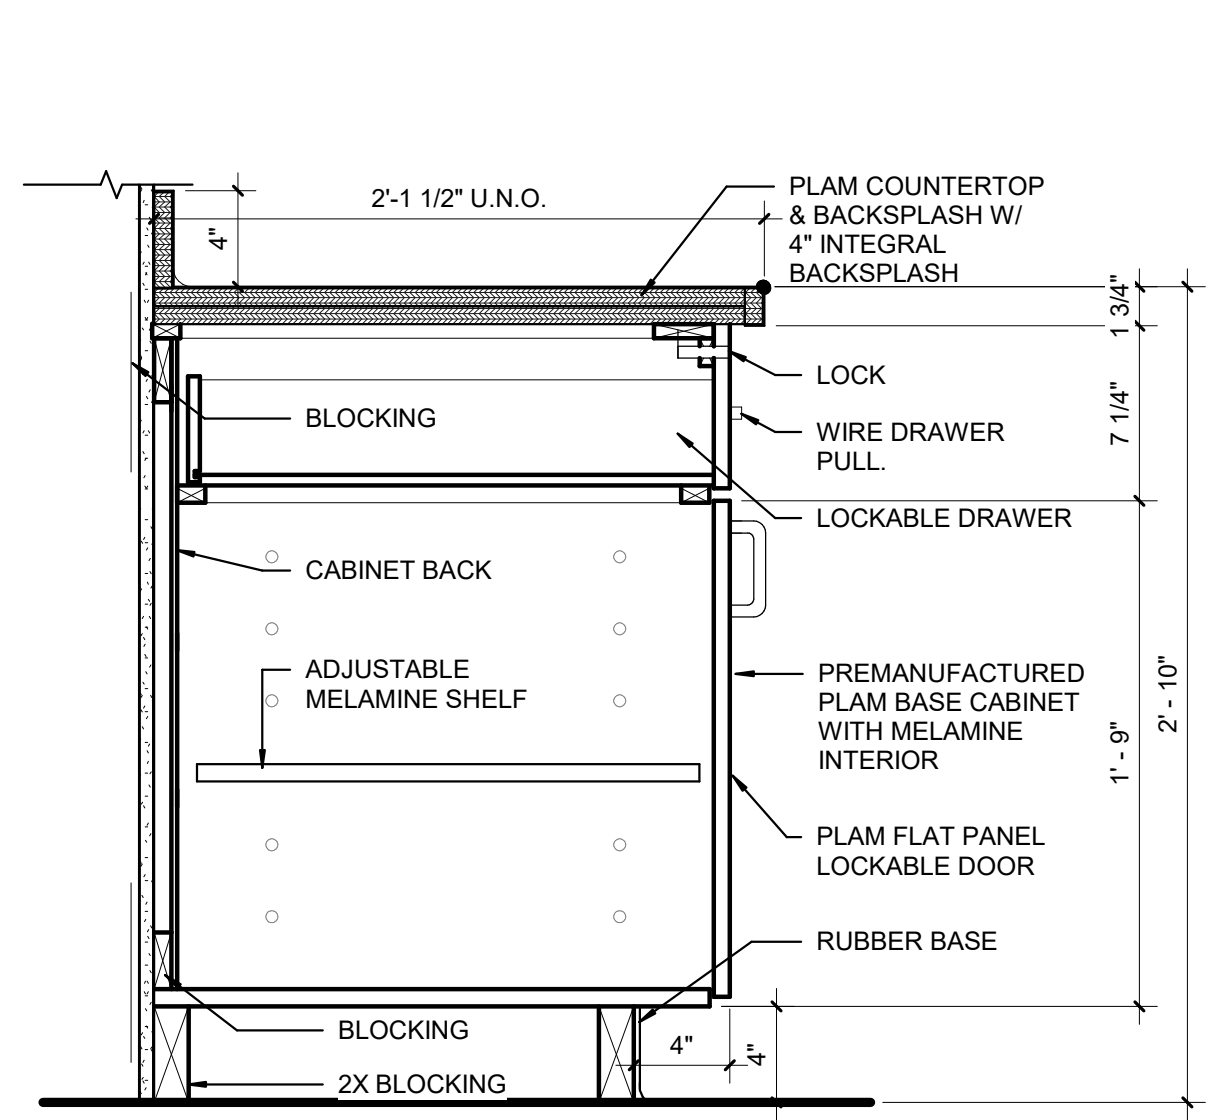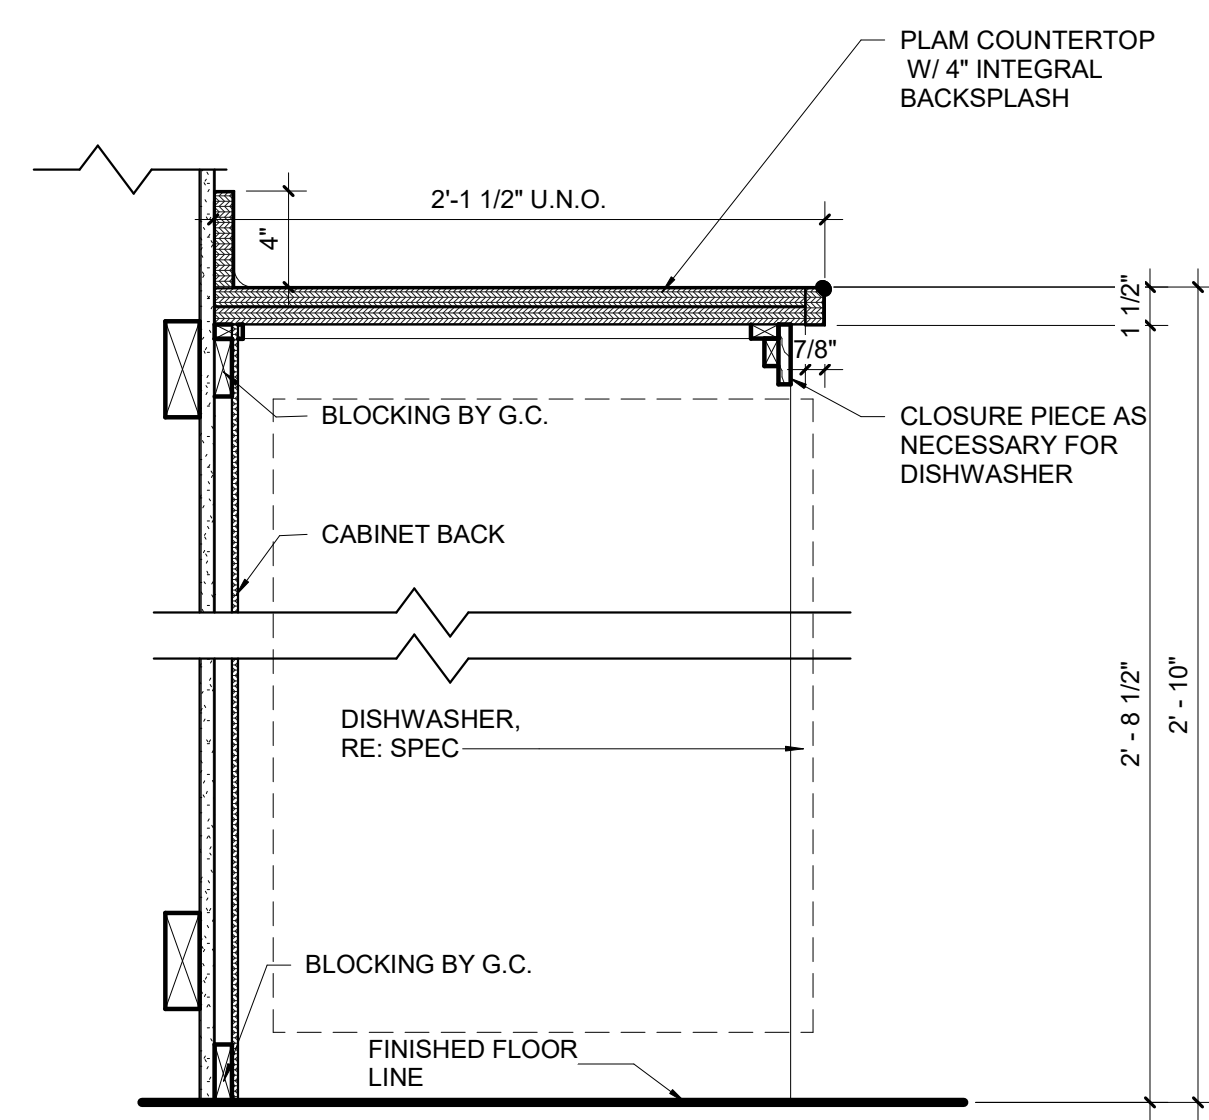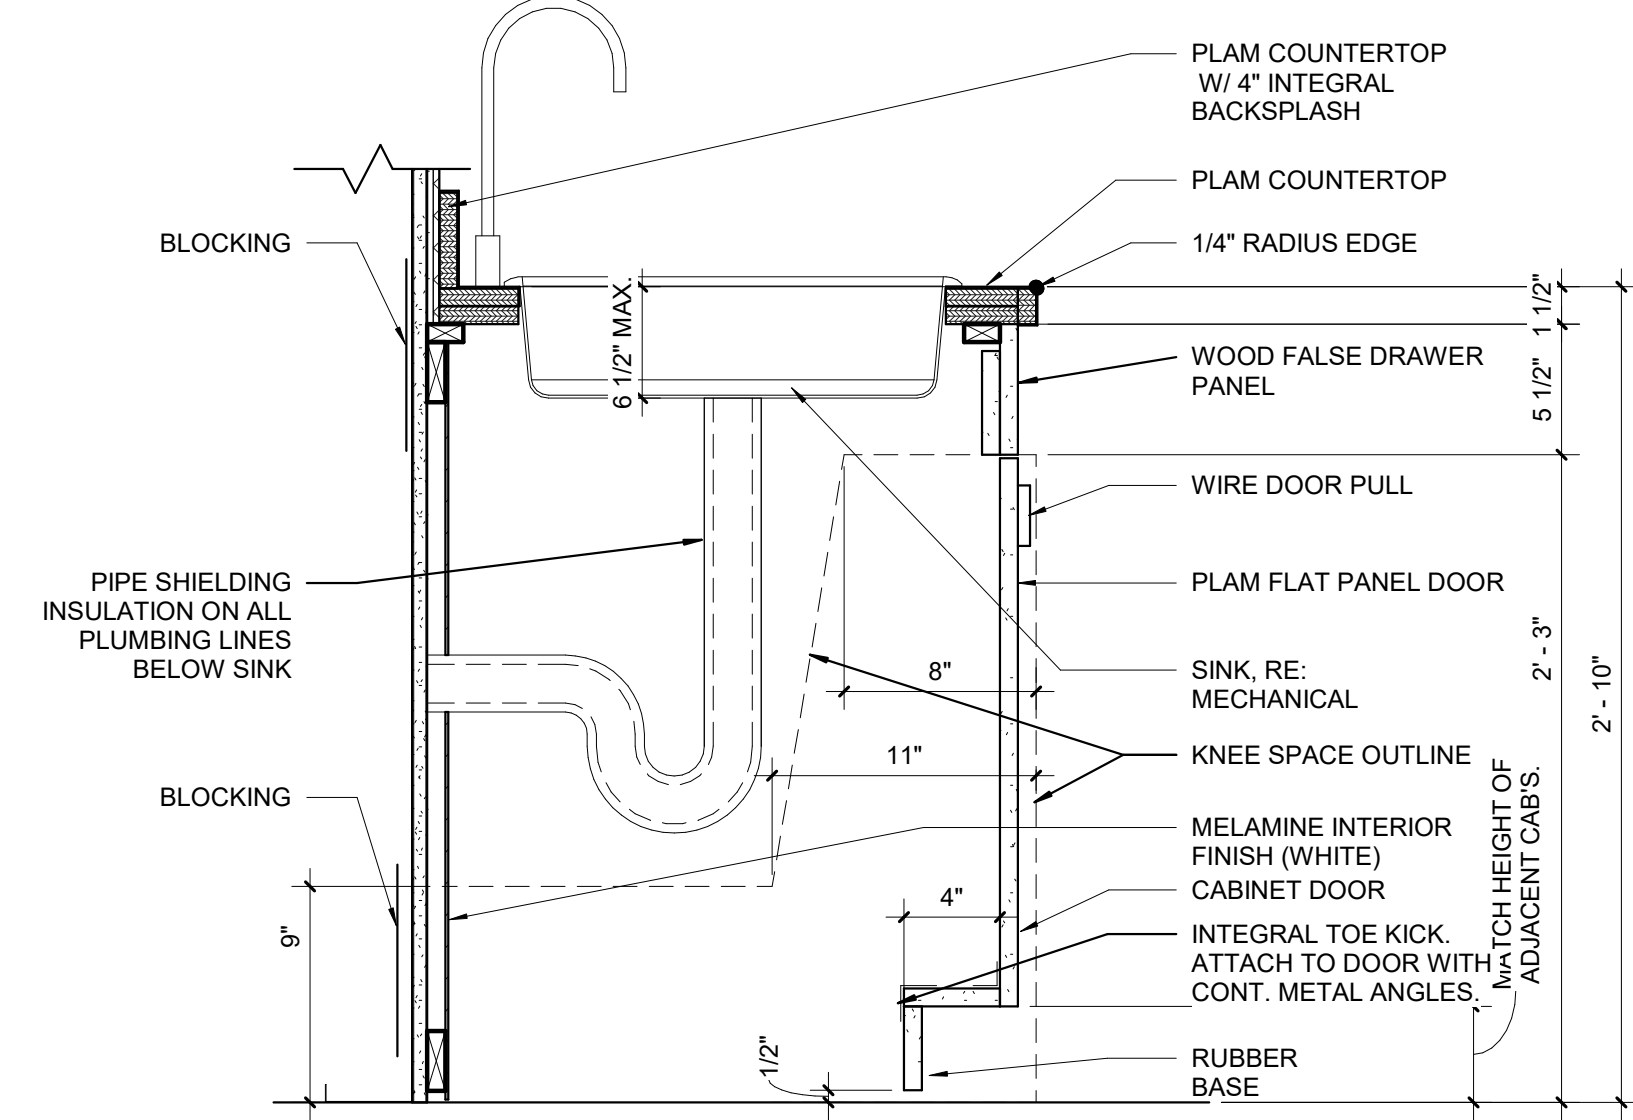

4 ADA SINK
1 1/2" = 1'-0"

5 BASE CABINET @ DISHWASHER
1 1/2" = 1'-0"

6 BASE CABINET W/ DRAWER
1 1/2" = 1'-0"

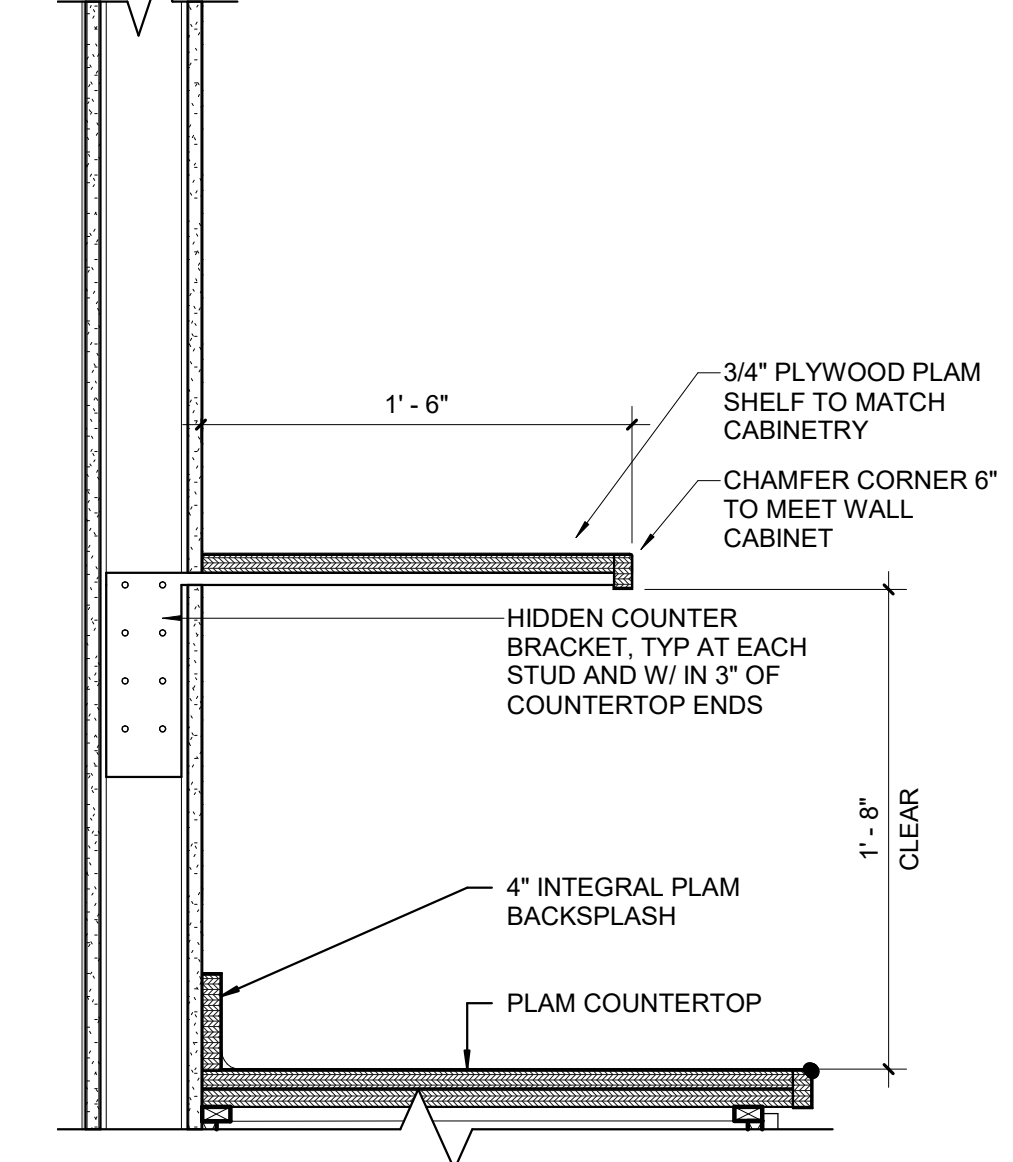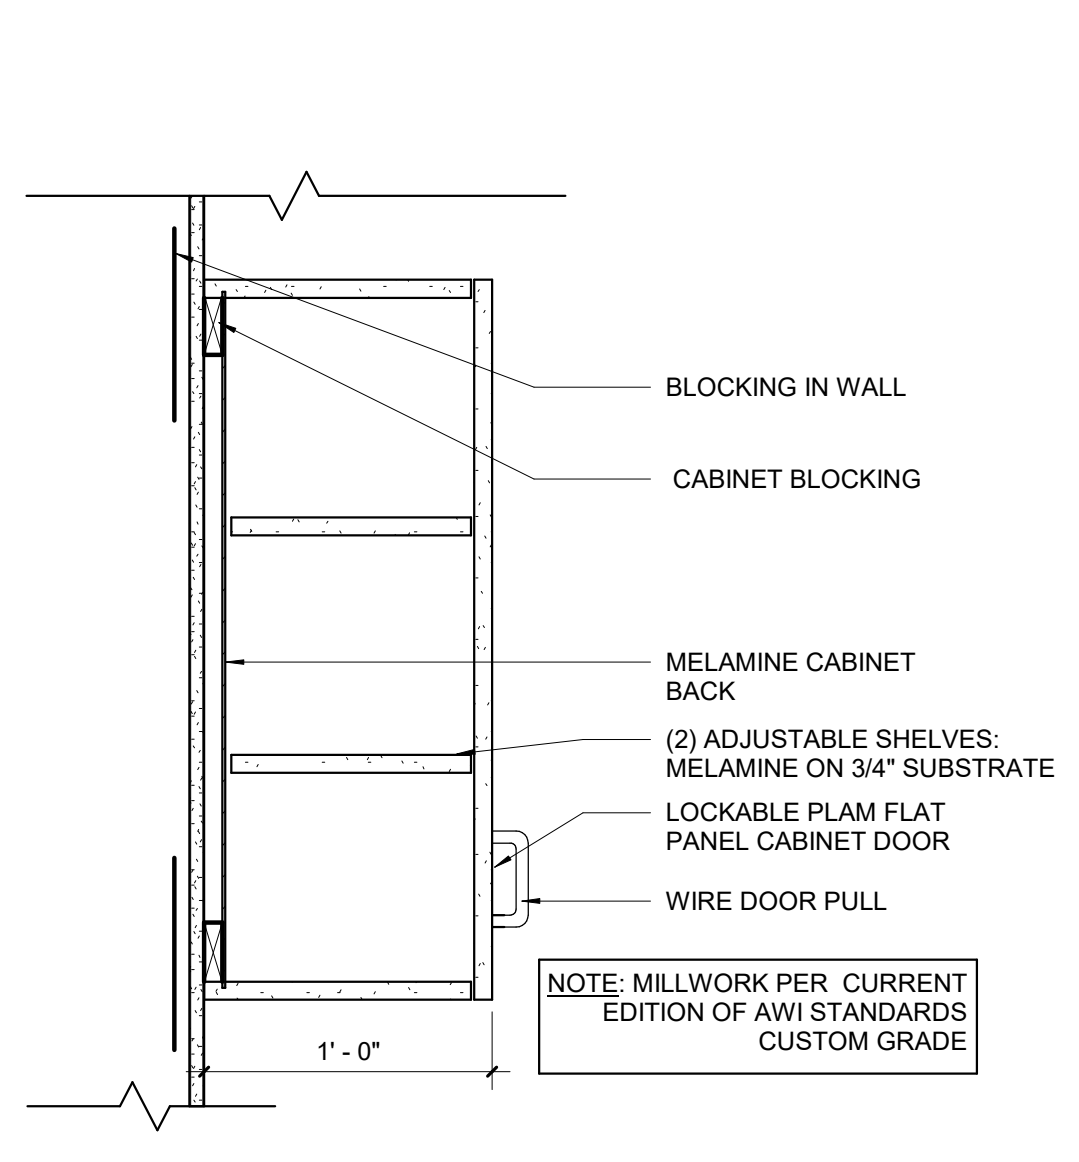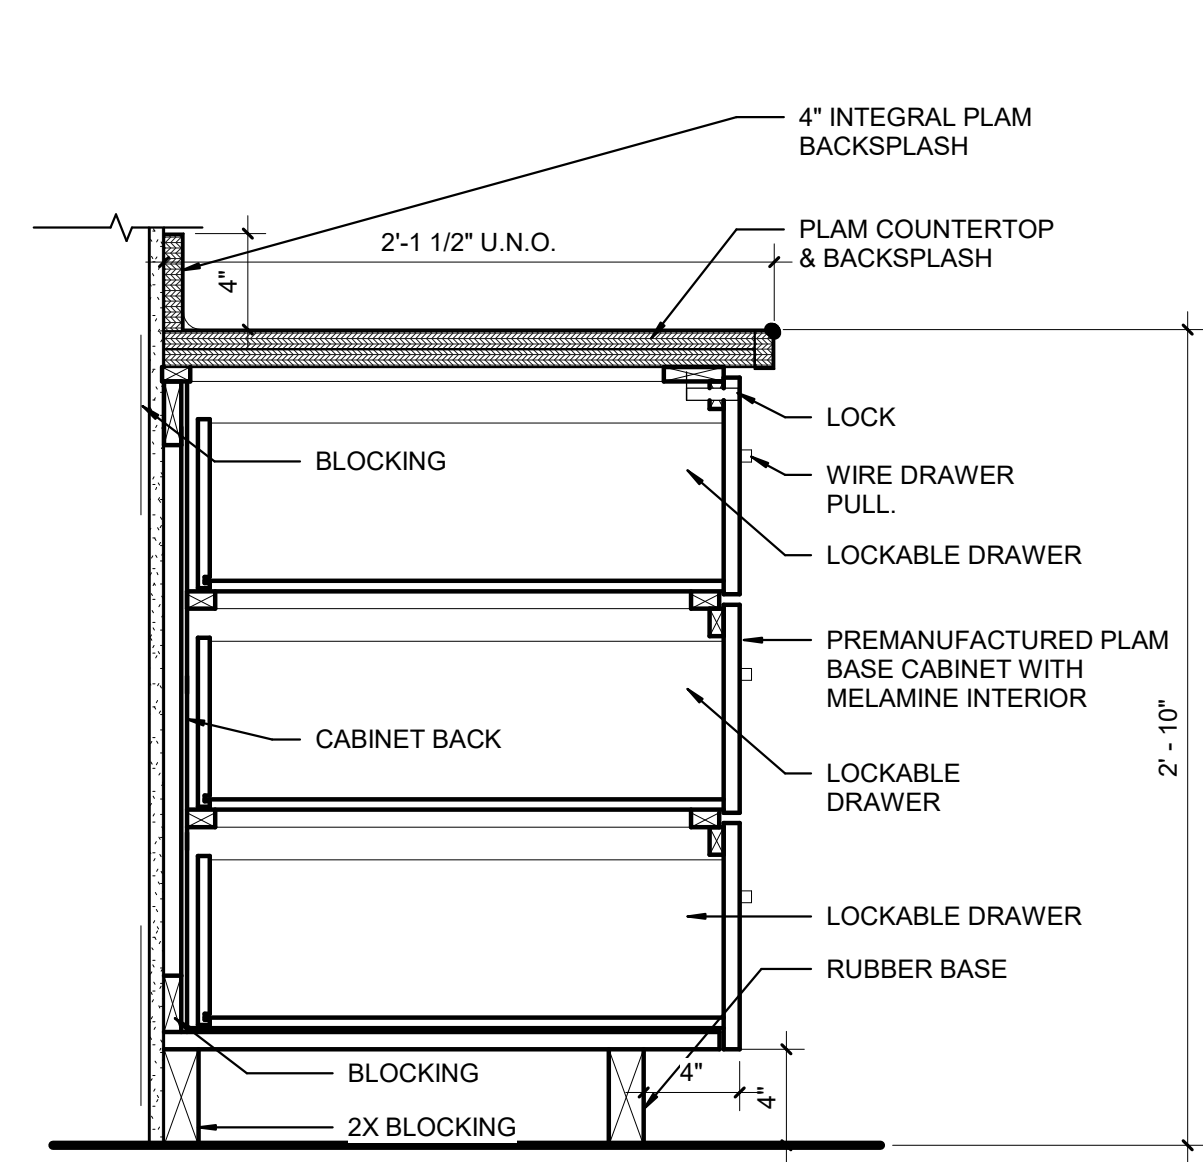

7 BASE CABINET - 3 DRAWERS
1 1/2" = 1'-0"

8 UPPER CABINET
1 1/2" = 1'-0"

9 WALL SHELVES
1 1/2" = 1'-0"



GENERAL LEGEND:

- KEYED NOTE
- CASEWORK TYPE CASEWORK INDICATOR
- CASEWORK TYPE TAG: BC = BASE CABINET, SB = SINK BASE, TC = TALL CABINET, WC = WALL CABINET, DR = DRAWER, DO = DOOR, RF = REFRIGERATOR, DW = DISH WASHER

GENERAL CASEWORK NOTES

- PROVIDE PLAM FINISHED END PANELS AT ALL EXPOSED CABINET SURFACES
- REFRIGERATOR, DW AND MICROWAVES PROVIDED BY NRCS. INSTALLED BY CONTRACTOR

100% CONSTRUCTION DOCUMENTS
BUILDING 56 - 2ND FLOOR NRCS CONSOLIDATION
-- FOR CONSTRUCTION --

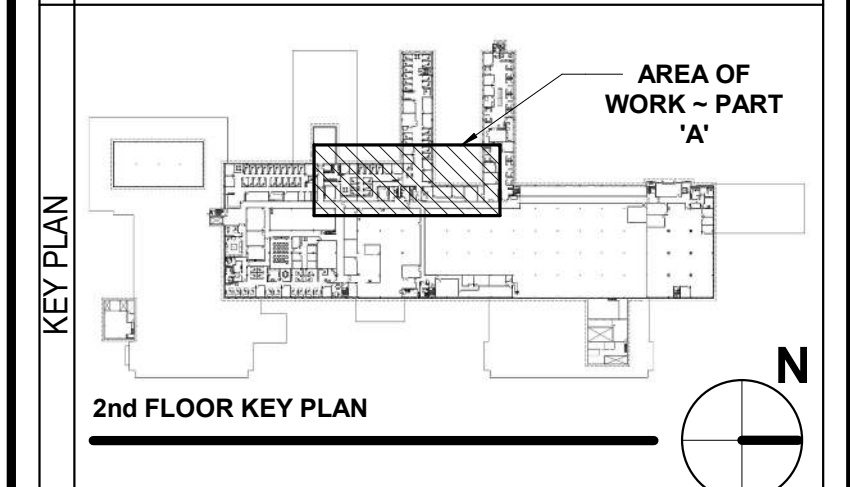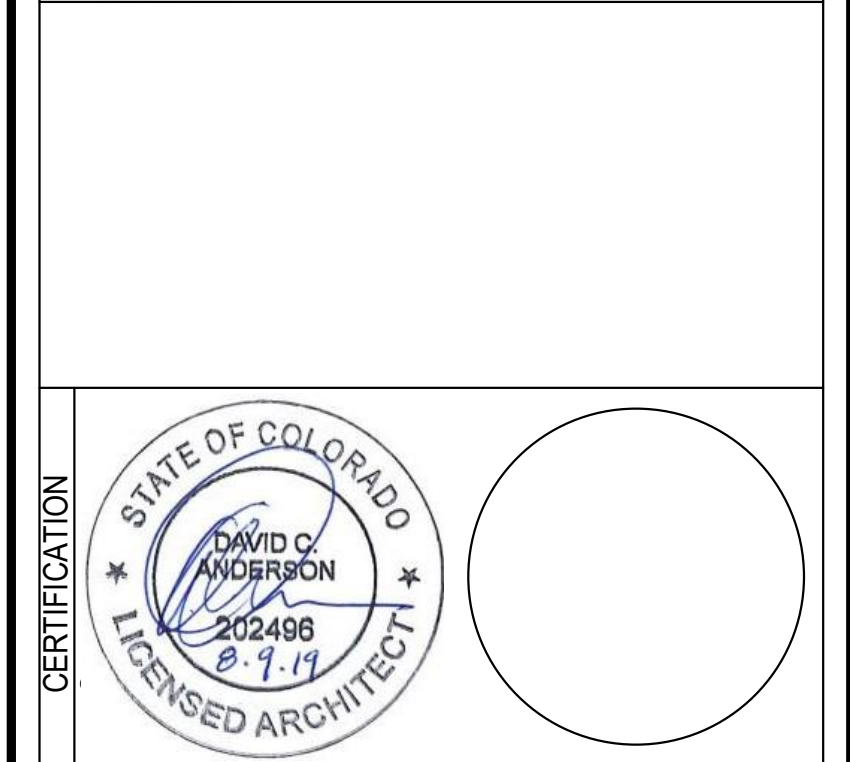

MARK	DATE	DESCRIPTION

CONTRACTORS	CONTRACT NO.
A/E CON. NO.	GS-08P-JB-D-0017
A/E TASK NO.	EP-GS-P-08-16-JB-7053
CONS. CONTR.	GS-08P-13-JB-D-0032
CONS. WORK	
PRIM A/E	ANDERSON HALLAS ARCHITECTS PC
SUB A/E	
CONSTR. CON.	

BUILDING	CONTRACT NO.
NAME	BUILDING 56
STREET	6TH STREET
CITY/ST./ZIP	DENVER, COLORADO 80255
BUILDING NO.	BUILDING 56
OTHER BUILDING NOS	
FACILITY CODE	

PROJECT	CONTRACT NO.
PROJECT TITLE	BUILDING 56 - NRCS
PROJECT DESCRIPTION	BUILDING 56 - 2ND FLOOR NRCS CONSOLIDATION
PROJECT NO.	EP-GS-P-08-16-JB-7053
GSA PM	BEN REKO
SUBMISSION	100 CD ISSUE
SUB. DATE	07/25/2019
DRAWING TITLE	CASEWORK DETAILS
FILE NAME	
FLOOR NO.	

DRAWING	DATE	BY
DRAWN BY	DAM / LB	DATE DRAFTED: 04/15/2019
CHECKED BY	DAM / RS	SHEET SIZE: 22X34
DRAWING NO.	A 5 01	
DISCIPLINE	SHEET TYPE	SEQUENCE
SHEET 9	OF	50



GENERAL SERVICES ADMINISTRATION


Ben Reko
Project Manager
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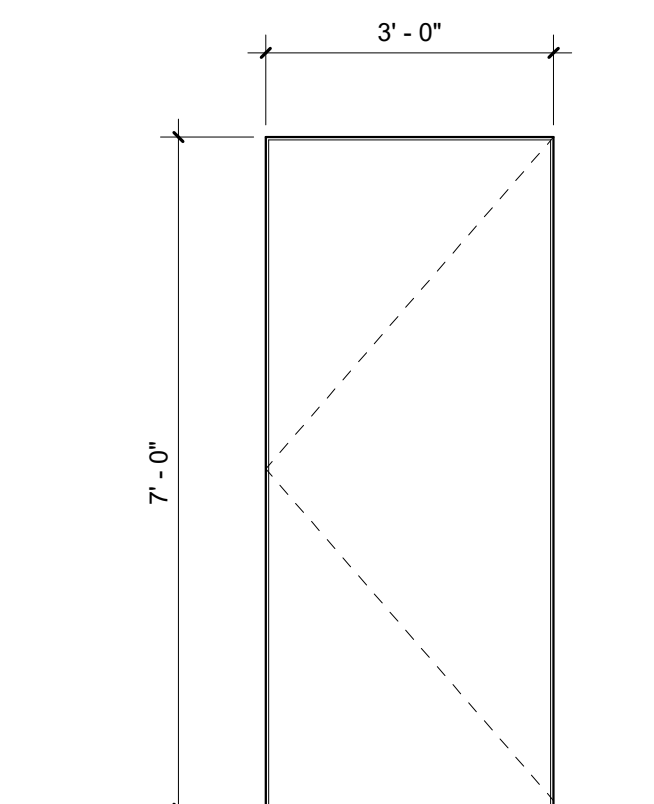
DOOR SCHEDULE														
NUMBER	ROOM NUMBER	NEW DOOR	SALVAGE / RELOCATE	SALVAGED DOOR #	DOOR TYPE	FRAME MATERIAL	FRAME TYPE	LEAF MATERIAL	THICKNESS	SIZE WIDTH	HEIGHT	FIRE RATING	HARDWARE SET	COMMENTS
2403A	2403		Yes	1148	EXIST.	Hollow Metal	B	(E)	1 3/4"	3' - 0"	7' - 0"		4	
2403B	2403	Yes	No		A	Hollow Metal	A	Steel	1 3/4"	3' - 0"	7' - 0"	1.5 hr	1	CLOSER- adjust door opener so door shall open with a force not to exceed 5 ft lbs
2405	2405	Yes	No		A	Hollow Metal	A	Steel	1 3/4"	3' - 0"	7' - 0"	1.5 hr	1	CLOSER- adjust door opener so door shall open with a force not to exceed 5 ft lbs
2406	2406	Yes	No		A	Hollow Metal	A	Steel	1 3/4"	3' - 0"	7' - 0"	1.5 hr	1	CLOSER- adjust door opener so door shall open with a force not to exceed 5 ft lbs
2408	2408		Yes	1140	EXIST.	Hollow Metal	A	(E)	1 3/4"	3' - 0"	7' - 0"		3	
2409	2409	Yes	No		A	Hollow Metal	A	Solid Core Wood	1 3/4"	3' - 0"	7' - 0"		3	
2411	2411		Yes	1139	EXIST.	Hollow Metal	B	(E)	1 3/4"	3' - 0"	7' - 0"		4	
2413	2413		Yes	1151	EXIST.	Hollow Metal	B	(E)	1 3/4"	3' - 0"	7' - 0"		4	
2414	2414		Yes	1141	EXIST.	Hollow Metal	B	(E)	1 3/4"	3' - 0"	7' - 0"		2	
2415	2415		Yes	1150	EXIST.	Hollow Metal	B	(E)	1 3/4"	3' - 0"	7' - 0"		4	
2416	2416		Yes	1149	EXIST.	Hollow Metal	B	(E)	1 3/4"	3' - 0"	7' - 0"		2	
2418	2418	No	Yes	1128	EXIST.	Hollow Metal	B	(E)	1 3/4"	3' - 0"	7' - 0"		4	
2419	2419		Yes	2410	EXIST.	Hollow Metal	B	(E)	1 3/4"	3' - 0"	7' - 0"		4	
2424	2424		Yes	1198	EXIST.	Hollow Metal	B	(E)	1 3/4"	3' - 0"	7' - 0"		4	
2425	2425		Yes	1197	EXIST.	Hollow Metal	B	(E)	1 3/4"	3' - 0"	7' - 0"		2	
2426	2426		Yes	2419	EXIST.	Hollow Metal	B	(E)	1 3/4"	3' - 0"	7' - 0"		4	
2427	2427		Yes	2418	EXIST.	Hollow Metal	B	(E)	1 3/4"	3' - 0"	7' - 0"		2	

NOTE: CONTRACTOR TO VERIFY DIMENSIONS OF EXISTING DOORS TO BE REUSED. PROMPTLY NOTIFY GOVERNMENT & ARCHITECT IF DIMENSIONS VARY FROM SHOWN ABOVE.




DOOR CLEARANCES

1/4" = 1'-0"

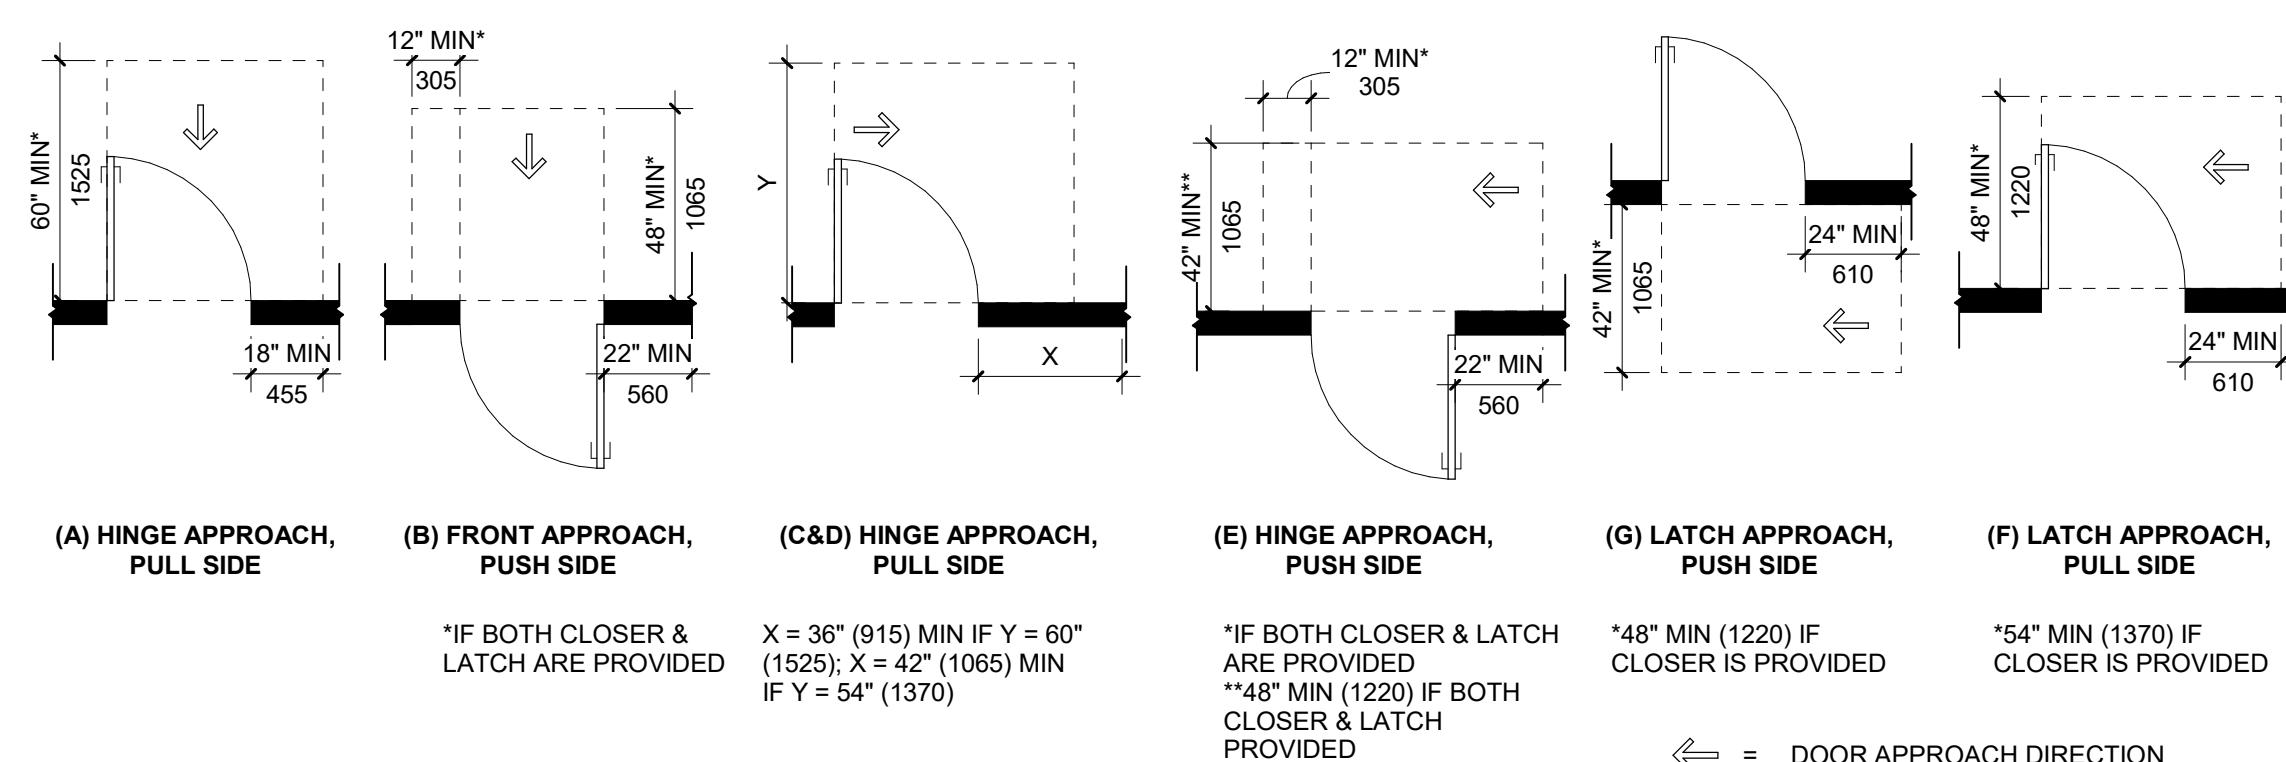


DOOR LEAF TYPE A

1/2" = 1'-0"

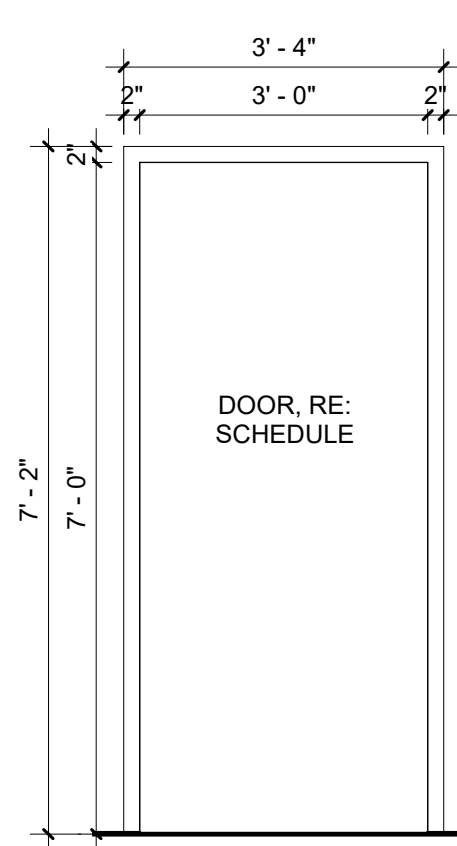


DOOR FRAME TYPE A

1/2" = 1'-0"

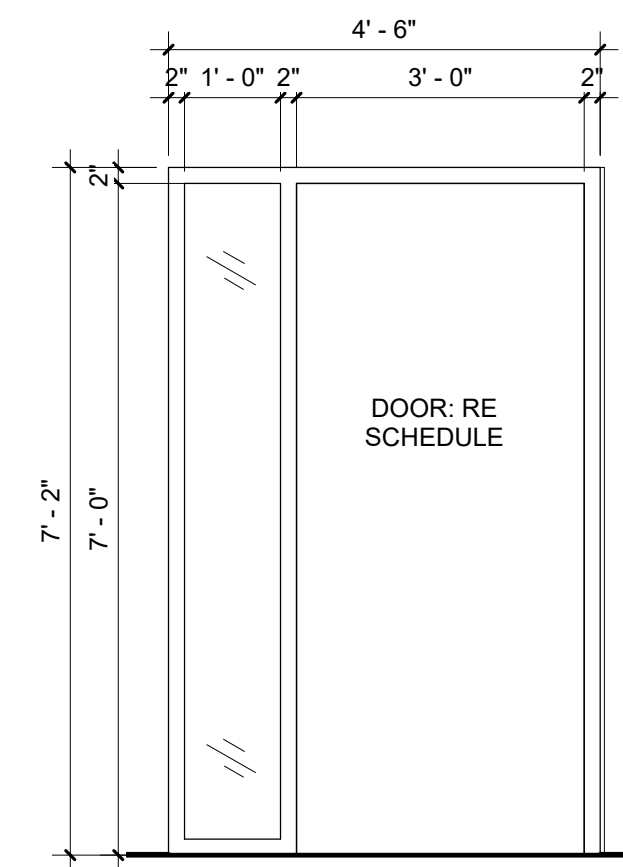


DOOR FRAME TYPE B

1/2" = 1'-0"

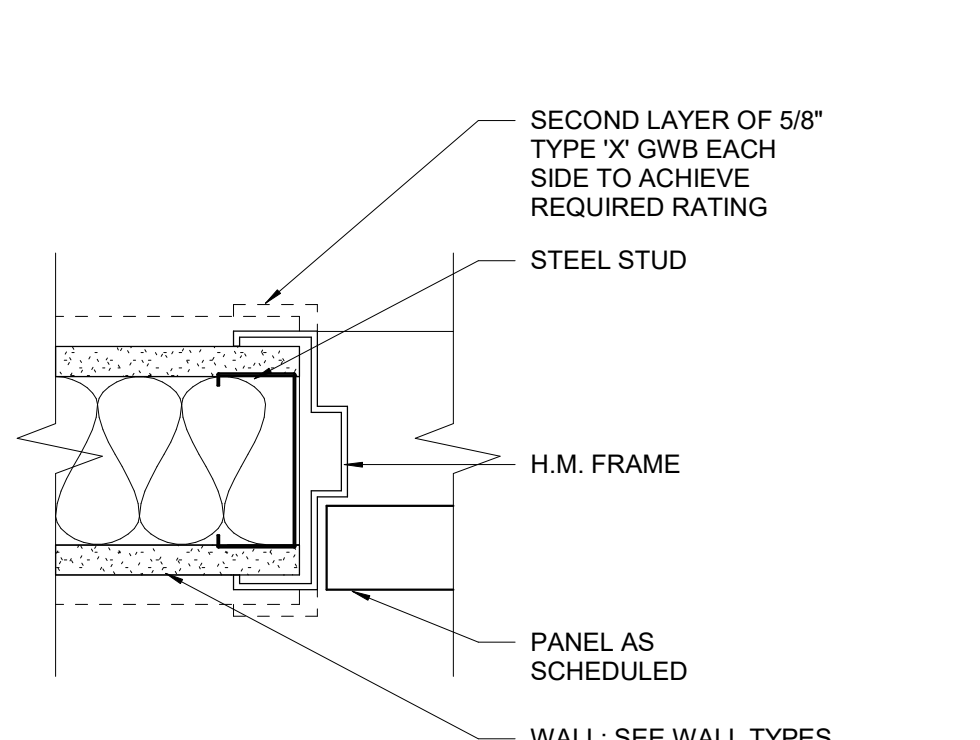

TYP. PARTITION DOOR JAMB

3" = 1'-0"

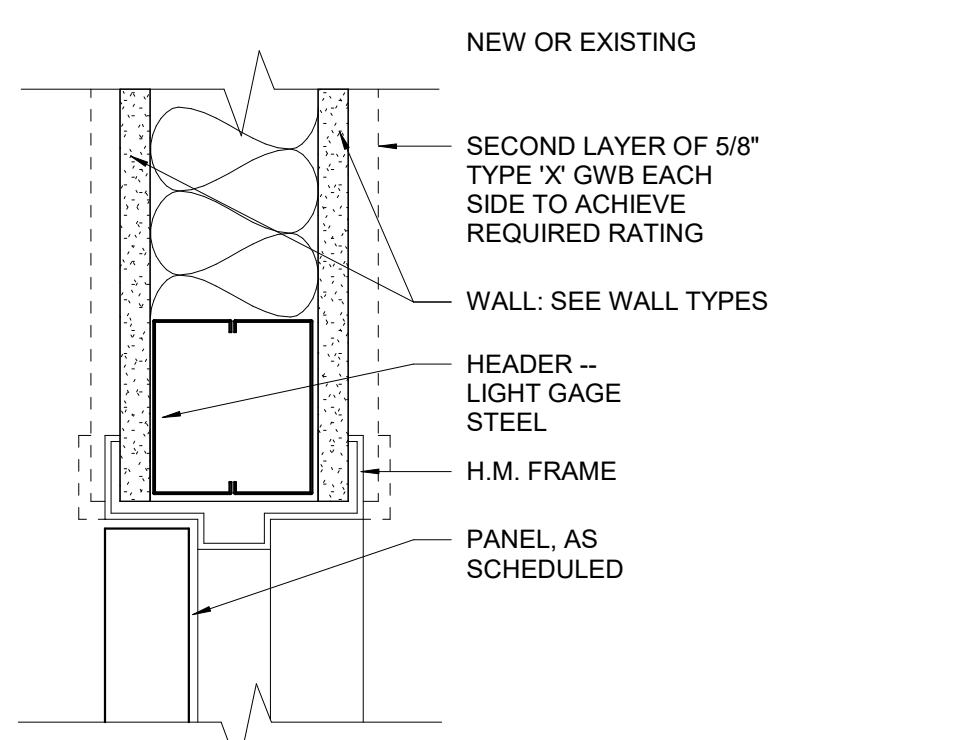


TYP. PARTITION DOOR HEAD

3" = 1'-0"

100% CONSTRUCTION DOCUMENTS

BUILDING 56 - 2ND FLOOR
NRCS CONSOLIDATION
-- FOR CONSTRUCTION --

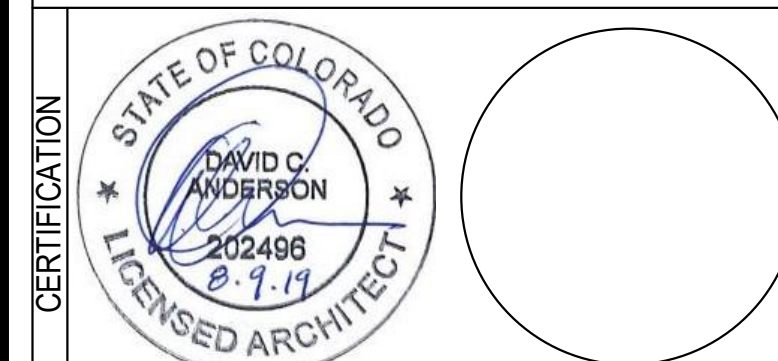

MARK	DATE	DESCRIPTION

CONTRACTORS	CONTRACT NO.	CONTRACT DESCRIPTION
A/E CON. NO.	GS-08P-JB-D-0017	
A/E TASK NO.	EP-GS-P-08-16-JB-7053	
CONS. CONTR.	GS-08P-13-JB-D-0032	
CONS. WORK		
PRIM A/E	ANDERSON HALLAS ARCHITECTS PC	
SUB A/E		
CONSTR. CON.		

BUILDING	PROJECT
NAME	BUILDING 56
STREET	6TH STREET
CITY/ST./ZIP	DENVER, COLORADO 80255
BUILDING NO.	BUILDING 56
OTHER BUILDING NOS	
FACILITY CODE	
PROJECT TITLE	BUILDING 56 - NRCS
PROJECT DESCRIPTION	BUILDING 56 - 2ND FLOOR NRCS CONSOLIDATION
PROJECT NO.	EP-GS-P-08-16-JB-7053
GSA PM	BEN REKO
SUBMISSION	100 CD ISSUE
SUB. DATE	07/25/2019
DRAWING TITLE	DOOR AND WINDOW SCHEDULES
FILE NAME	
FLOOR NO.	2ND FLOOR
DRAWN BY	DAM / LB DATE DRAFTED: 04/15/2019
CHECKED BY	DCA / RS SHEET SIZE: 22X34
DRAWING NO.	A 6 01
DISCIPLINE	SHEET TYPE SEQUENCE
SHEET	10 OF 50

GENERAL FINISH PLAN NOTES

- REMOVE (E) FINISHES IN ALL LOCATIONS NOTED TO RECIEVE NEW FINISH.
- IF HAZARDOUS MATERIALS ARE DISCOVERED DURING DEMOLITION, STOP WORK AND NOTIFY GOVERNMENT.
- ALLOW FOR TWO ACCENT PAINT COLORS (APPOX. 20% OF WALLS). COLOR TO BE SELECTED BY OWNER.
- PROVIDE STAINLESS STEEL ABA TRANSITION STRIPS AT ALL ADJACENT DISSIMILAR FLOORING.
- PROVIDE CORNER GUARDS AT ALL OUTSIDE CORNERS OF GYP BOARD WALLS.
- PATCH AND REPAIR ALL FINISHES DAMAGED BY DEMOLITION OR INSTALLATION OF EQUIPMENT. MATCH (E) ADJACENT FINISH.
- PROVIDE SMOOTH AND FLUSH TRANSITION BETWEEN (N) AND (E) GWB.

ROOM FINISH SCHEDULE							
ROOM NUMBER	Area	NAME	FLOOR FINISH	BASE	CEILING FINISH	WALL FINISH	COMMENTS
2401	327 SF	WAITING / RECEPTION	CPT	RB	ACT	PT	
2402	79 SF	COPY/ FILE/ STORAGE	CPT	RB	ACT	PT	
2403	483 SF	MEETING ROOM 1	CPT	RB	ACT	PT	
2405	321 SF	MEETING ROOM 2	CPT	RB	ACT	PT	
2406	332 SF	BREAK ROOM	SL	RB	<E> ACT	PT	
2408	80 SF	JEFFCO STG	SL	RB	OPEN	PT	
2409	389 SF	STORAGE & IT	SL	RB	OPEN	PT	
2411	127 SF	STATE CONSERV. OFFICE	CPT	RB	ACT	PT	
2412	2891 SF	OPEN OFFICE	CPT	RB	ACT	PT	
2413	113 SF	PROGRAMS OFFICE	CPT	RB	ACT	PT	
2414	34 SF	PHONE BOOTH	CPT	RB	ACT	PT	
2415	113 SF	SNOW OFFICE	CPT	RB	ACT	PT	
2416	34 SF	PHONE BOOTH	CPT	RB	ACT	PT	
2417	18 SF	CLOSET	<E>	<E>	<E> ACT	PT	
2418	113 SF	MGT & STRAT. OFFICE	CPT	RB	ACT	PT	
2419	113 SF	SOILS OFFICE	CPT	RB	ACT	PT	
2420	291 SF	MECHANICAL	<E>	<E>	<E>	PT	
2421	1514 SF	OPEN OFFICE	CPT	RB	ACT	PT	
2422	106 SF	PLOTTER/ COPY	CPT	RB	ACT	PT	
2423	250 SF	ECS & ENGINEERING STORAGE	CPT	RB	ACT	PT	
2424	114 SF	ENG. OFFICE	CPT	RB	ACT	PT	
2425	30 SF	PHONE BOOTH	CPT	RB	ACT	PT	
2426	114 SF	ECS OFFICE	CPT	RB	ACT	PT	
2427	30 SF	PHONE BOOTH	CPT	RB	ACT	PT	
2428	824 SF	OPEN OFFICE	CPT	RB	ACT	PT	

FINISH SCHEDULE LEGEND


- CPT = CARPET TILE
- SL = SHEET LINOLEUM
- <E> = EXISTING
- RB = RUBBER BASE - ALL WALLS
- ACT = ACOUSTIC CEILING TILE
- PT = PAINT
- EGGSHELL COLOR SELECTED BY OWNER
- 20% OF ALL WALLS ARE ACCENT.

NEW KEYNOTES

Key Value	Keynote Text
NF2	PATCH END OF WALL MATCH (E) ADJACENT FINISH
NF4	INFILL (E) OPENING WHERE DOOR WAS REMOVED. MATCH (E) ADJACENT WALL ASSEMBLY; ASSUMED WALL TYPE 3.
NF6	PATCH/REPAIR EXISTING FLOORING AND CEILING TO MATCH (E) FINISH WHERE WALL IS REMOVED. USE SALVAGED CARPET FROM DEMO.

LEGEND:

- CARPET
- SHEET LINOLEUM

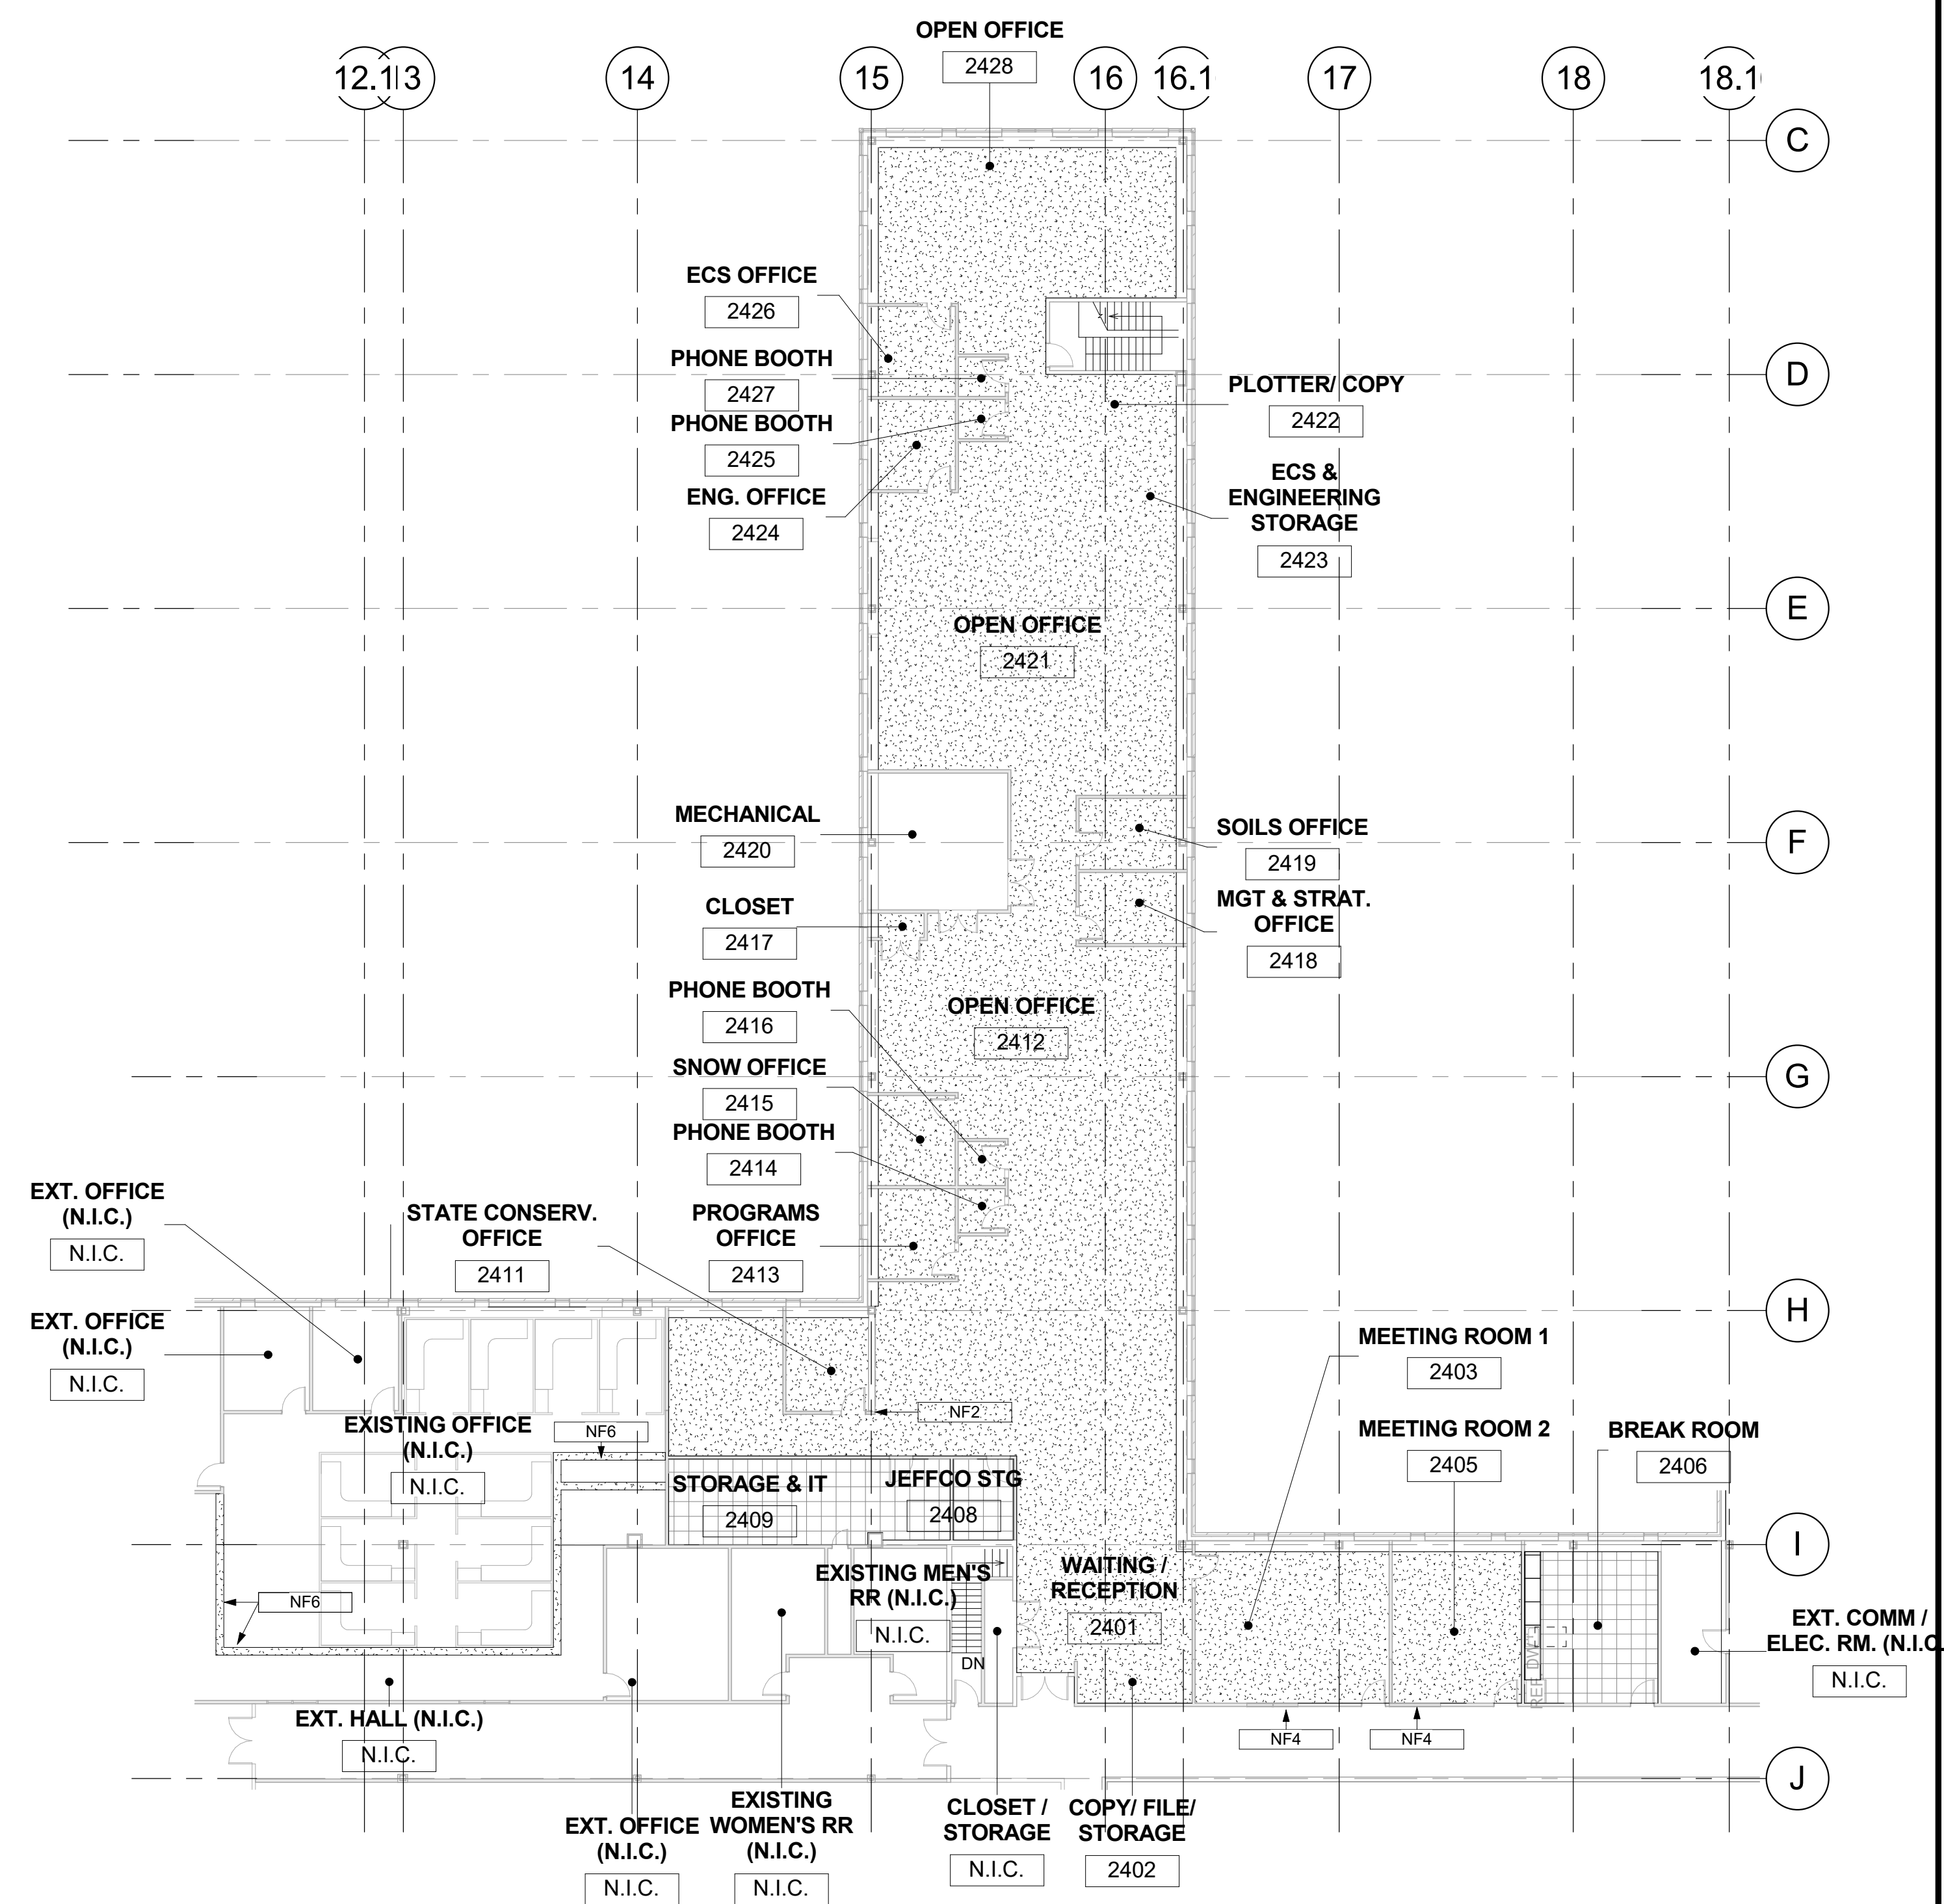


1 **NEW - SECOND LEVEL FINISH PLAN - OVERALL**
 1/16" = 1'-0"

100% CONSTRUCTION DOCUMENTS
BUILDING 56 - 2ND FLOOR
NRCS CONSOLIDATION
-- FOR CONSTRUCTION --

	GENERAL SERVICES ADMINISTRATION Project Manager Ben Reko D.F.C. BUILDING 41 - SUITE 246 DENVER, COLORADO - 80255 303.226.0855 Phone / 720.412.2812 Cell benjamin.reko@gsa.gov																								
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DRAWING																									
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FILE NAME																									
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CHECKED BY	DCA / RS SHEET SIZE: 22X34																								
DRAWING NO. A 6 02																									
DISCIPLINE	SHEET TYPE SEQUENCE																								
	SHEET 11 OF 50																								

12.1 13 14 15 16 16.1 17 18

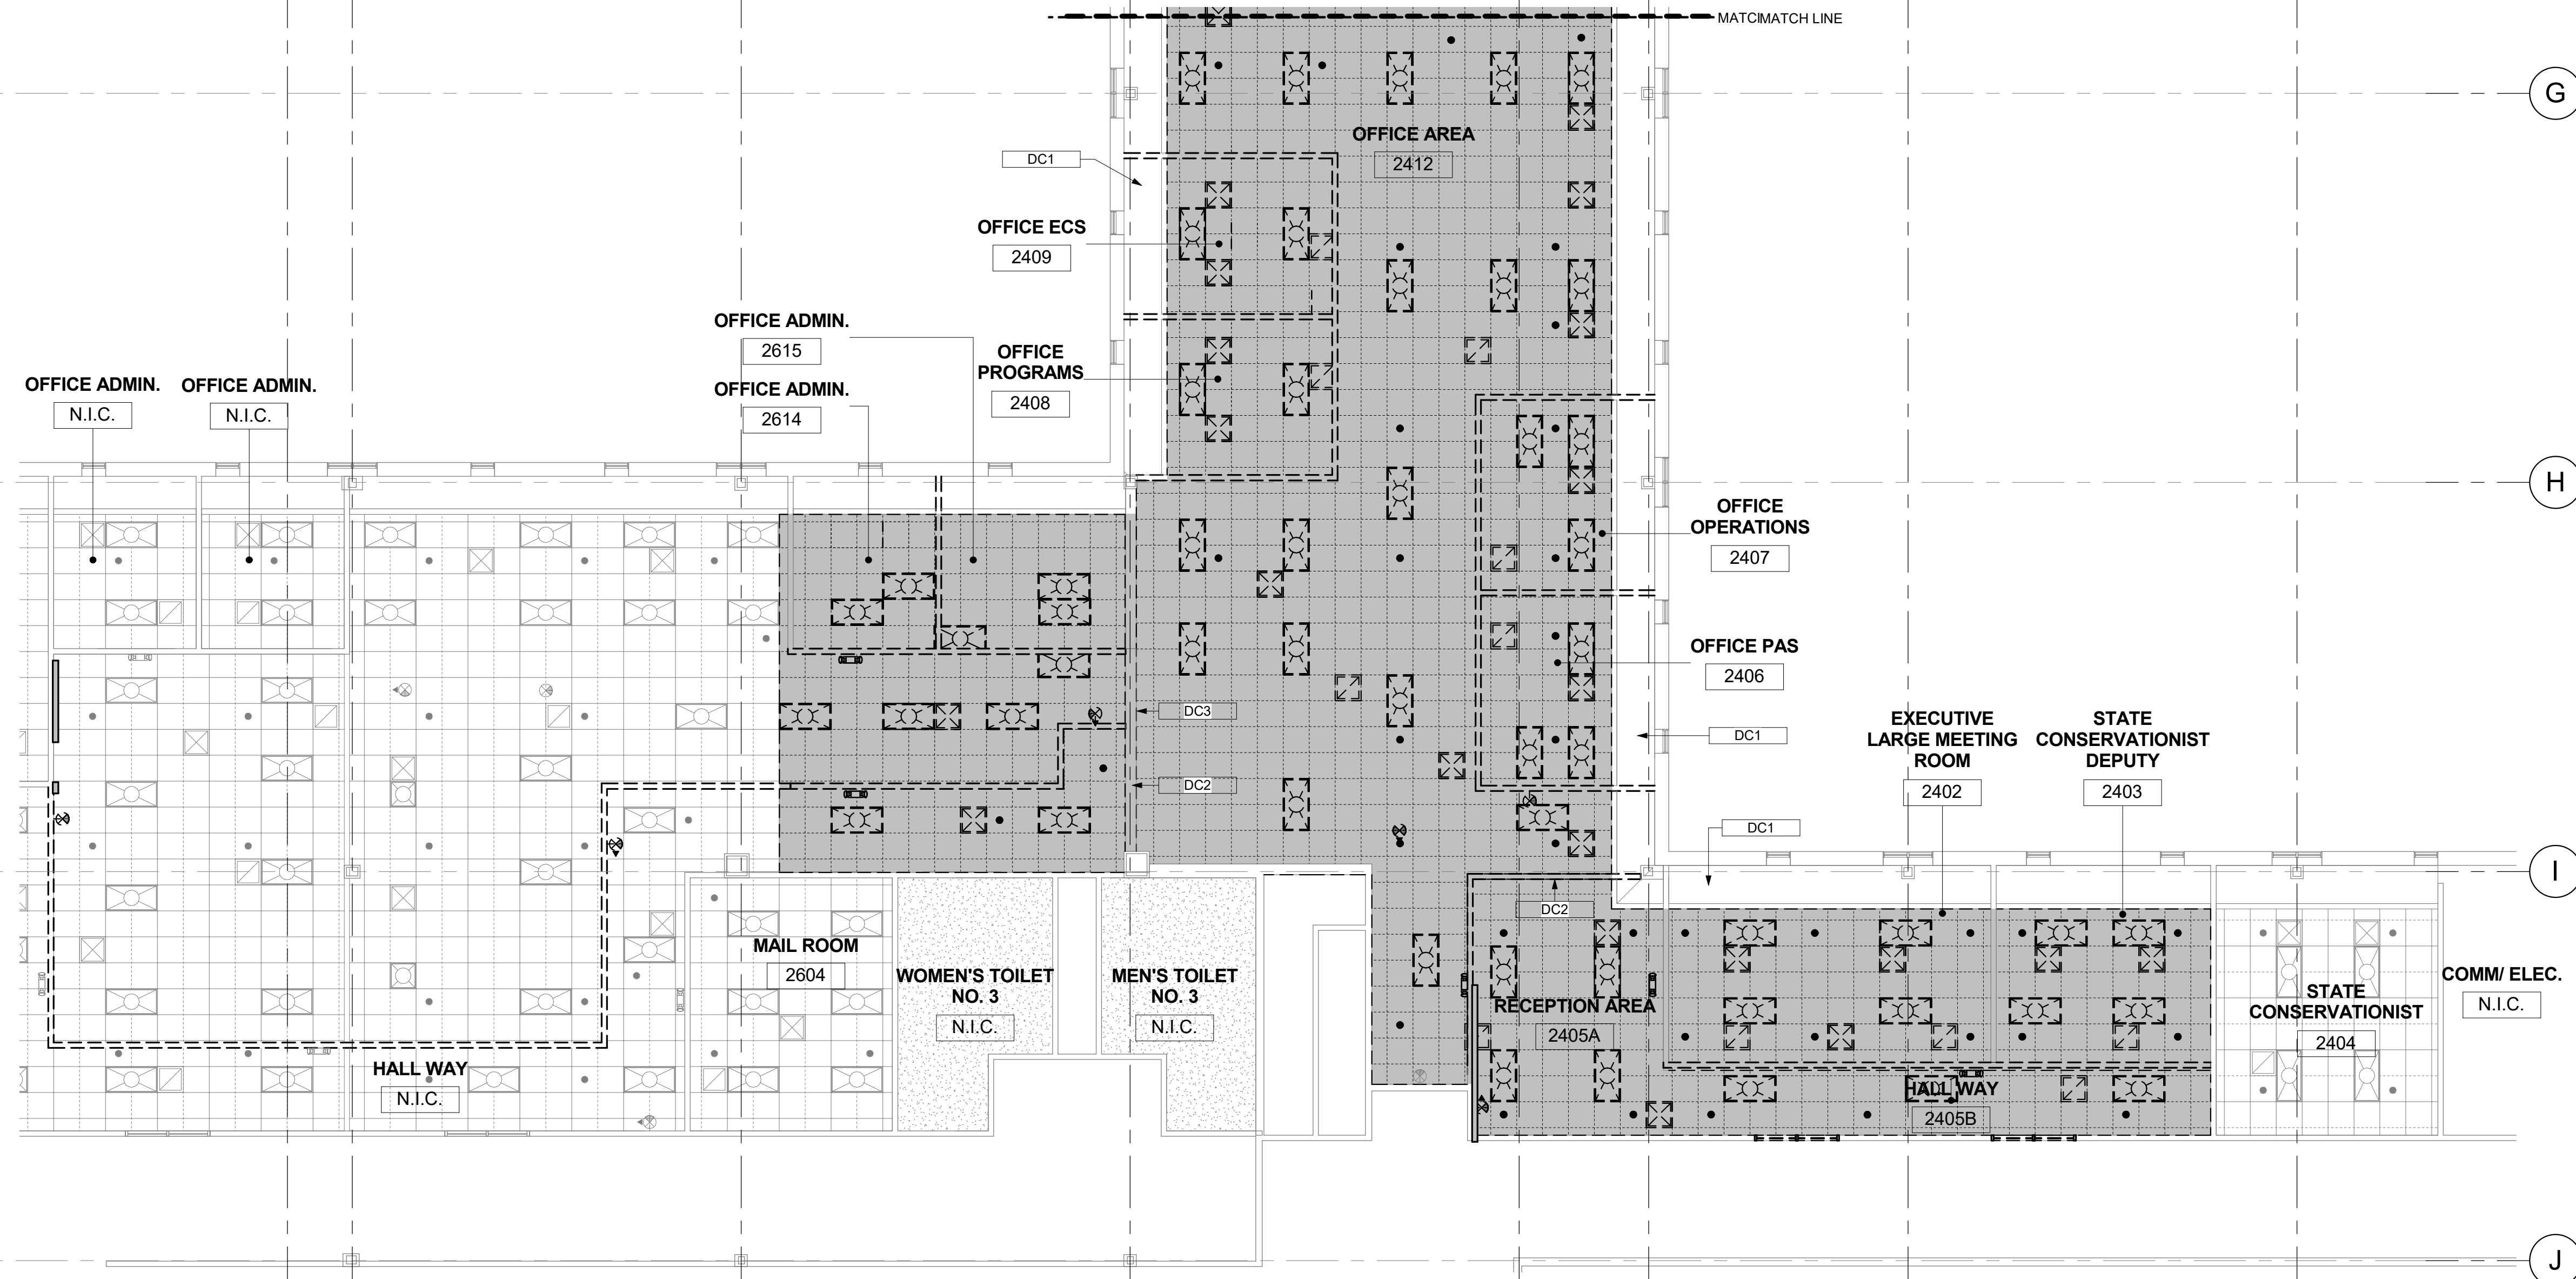

1 DEMO - SECOND LEVEL RCP - PART 'A'

1/8" = 1'-0"

CEILING LEGEND:

- = GYPSUM BOARD CEILING TO REMAIN
- = SHADED AREA INDICATED AREA OF CEILING DEMOLITION
- = 2x2 - ACOUSTIC CEILING TILE (ACT) & TRACK TO REMAIN
- = 2x4 - ACOUSTIC CEILING TILE (ACT) SCORED TO LOOK LIKE 2X2 & TRACK TO BE REMOVED
- = 2x4 LIGHT FIXTURE TO BE REMOVED OR RELOCATED, RE: ELECTRICAL DRAWINGS FOR ADDITIONAL INFORMATION
- = RESCED CANLIGHT FIXTURE TO BE REMOVED OR RELOCATED RE: ELECTRICAL DRAWINGS FOR ADDITIONAL INFORMATION
- = MECHANICAL 2x2 RETURN AIR FIXTURE TO BE REMOVED OR RELOCATED, RE: MECHANICAL DRAWINGS FOR ADDITIONAL INFORMATION
- = MECHANICAL 2x2 AIR SUPPLY FIXTURE TO BE REMOVED OR RELOCATED, RE: MECHANICAL DRAWINGS FOR ADDITIONAL INFORMATION
- = CEILING MOUNTED EXIT SIGN WITH ALUMINATED DIRECTIONAL ARROWS TO BE REMOVED OR RELOCATED, RE: ELECTRICAL DRAWINGS FOR ADDITIONAL INFORMATION
- = WALL MOUNTED EMERGENCY SIGN WITH LUMINATED DIRECTIONAL ARROWS TO BE REMOVED OR RELOCATED, RE: ELECTRICAL DRAWINGS FOR ADDITIONAL INFORMATION
- = SEMI RESCED FIRE SPRINKLER (DOWN) TO BE REMOVED OR RELOCATED, RE: FIRE PROTECTION DRAWINGS FOR ADDITIONAL INFORMATION
- = CEILING MOUNTED FIRE STROBE AND SPEAKER TO BE REMOVED OR RELOCATED, RE: FIRE PROTECTION DRAWINGS FOR ADDITIONAL INFORMATION
- = CEILING MOUNTED SMOKE DETECTOR TO BE REMOVED OR RELOCATED, RE: FIRE PROTECTION DRAWINGS FOR ADDITIONAL INFORMATION

GENERAL DEMO CEILING NOTES

1. REFER TO MECH., ELEC., FIRE PROTECTION SHEETS FOR DEMO OR RELOCATION OF FIXTURES.
2. <E> ANGLED GYP. SOFFIT TO REMAIN.
3. PATCH AND REPAIR ALL CEILING SURFACES THROUGHOUT AREA OF WORK



DEMO RCP KEYNOTES

Key Value	Keynote Text
DC1	(E) ANGLED GYP. SOFFIT TO REMAIN
DC2	(E) SOFFIT TO REMAIN
DC3	REMOVE PORTION OF (E) MASONRY WALL, (E) BEAM TO REMAIN

100% CONSTRUCTION DOCUMENTS
*BUILDING 56 - 2ND FLOOR
 NRCS CONSOLIDATION
 -- FOR CONSTRUCTION --*

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MARK	DATE	DESCRIPTION

CONTRACTORS	
A/E CON. NO.	GS-08P-JB-D-0017
A/E TASK NO.	EP-GS-P-08-16-JB-7053
CONS. CONTR.	GS-08P-13-JB-D-0032
CONS. WORK	
PRIM A/E	ANDERSON HALLAS ARCHITECTS PC
SUB A/E	
CONSTR. CON.	
BUILDING	
NAME	BUILDING 56
STREET	6TH STREET
CITY/ST./ZIP	DENVER, COLORADO 80255
BUILDING NO.	BUILDING 56
OTHER BUILDING NOS	
FACILITY CODE	
PROJECT	
PROJECT TITLE	BUILDING 56 - NRCS
PROJECT DESCRIPTION	BUILDING 56 - 2ND FLOOR NRCS CONSOLIDATION
PROJECT NO.	EP-GS-P-08-16-JB-7053
GSA PM	BEN REKO
SUBMISSION	100 CD ISSUE
SUB. DATE	07/25/2019
DRAWING TITLE	ENLARGED DEMO REFLECTED CEILING PLAN - PART 'A'
FILE NAME	
FLOOR NO.	2ND FLOOR
DRAWN BY	DAM / LB DATE DRAFTED: 04/15/2019
CHECKED BY	DCA / RS SHEET SIZE: 22X34
DRAWING	
DRAWING NO.	A 7 01
DISCIPLINE	
SHEET TYPE	
SEQUENCE	
SHEET	12
OF	50

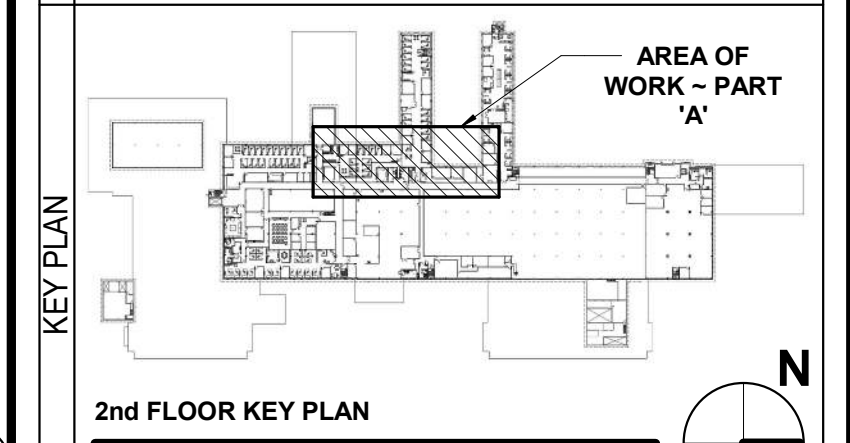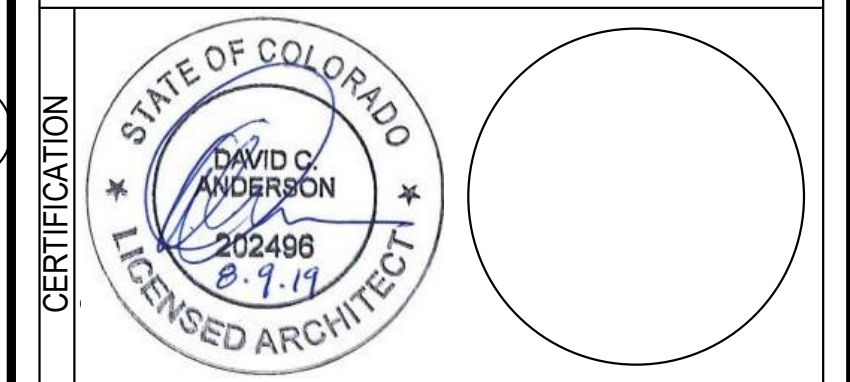
DEMO RCP KEYNOTES	
Key Value	Keynote Text
DC1	(E) ANGLED GYP. SOFFIT TO REMAIN
DC2	(E) SOFFIT TO REMAIN
DC3	REMOVE PORTION OF (E) MASONRY WALL, (E) BEAM TO REMAIN

GENERAL DEMO CEILING NOTES

1. REFER TO MECH., ELEC., FIRE PROTECTION SHEETS FOR DEMO OR RELOCATION OF FIXTURES.
2. <E> ANGLED GYP. SOFFIT TO REMAIN.
3. PATCH AND REPAIR ALL CEILING SURFACES THROUGHOUT AREA OF WORK

CEILING LEGEND:

= GYPSUM BOARD CEILING TO REMAIN	= 2x4 LIGHT FIXTURE TO BE REMOVED OR RELOCATED, RE: ELECTRICAL DRAWINGS FOR ADDITIONAL INFORMATION	= CEILING MOUNTED EXIT SIGN WITH ALUMINATED DIRECTIONAL ARROWS TO BE REMOVED OR RELOCATED, RE: ELECTRICAL DRAWINGS FOR ADDITIONAL INFORMATION
= SHADED AREA INDICATED AREA OF CEILING DEMOLITION	= RECESSED CANLIGHT FIXTURE TO BE REMOVED OR RELOCATED, RE: ELECTRICAL DRAWINGS FOR ADDITIONAL INFORMATION	= WALL MOUNTED EMERGENCY SIGN WITH LUMINATED DIRECTIONAL ARROWS TO BE REMOVED OR RELOCATED, RE: ELECTRICAL DRAWINGS FOR ADDITIONAL INFORMATION
= 2x2 - ACOUSTIC CEILING TILE (ACT) & TRACK TO REMAIN	= MECHANICAL 2x2 RETURN AIR FIXTURE TO BE REMOVED OR RELOCATED, RE: MECHANICAL DRAWINGS FOR ADDITIONAL INFORMATION	= SEMI RECESSED FIRE SPRINKLER (DOWN) TO BE REMOVED OR RELOCATED, RE: FIRE PROTECTION DRAWINGS FOR ADDITIONAL INFORMATION
= 2x4 - ACOUSTIC CEILING TILE (ACT) SCORED TO LOOK LIKE 2x2 & TRACK TO BE REMOVED	= MECHANICAL 2x2 AIR SUPPLY FIXTURE TO BE REMOVED OR RELOCATED, RE: MECHANICAL DRAWINGS FOR ADDITIONAL INFORMATION	= CEILING MOUNTED FIRE STROBE AND SPEAKER TO BE REMOVED OR RELOCATED, RE: FIRE PROTECTION DRAWINGS FOR ADDITIONAL INFORMATION
		= CEILING MOUNTED SMOKE DETECTOR TO BE REMOVED OR RELOCATED, RE: FIRE PROTECTION DRAWINGS FOR ADDITIONAL INFORMATION

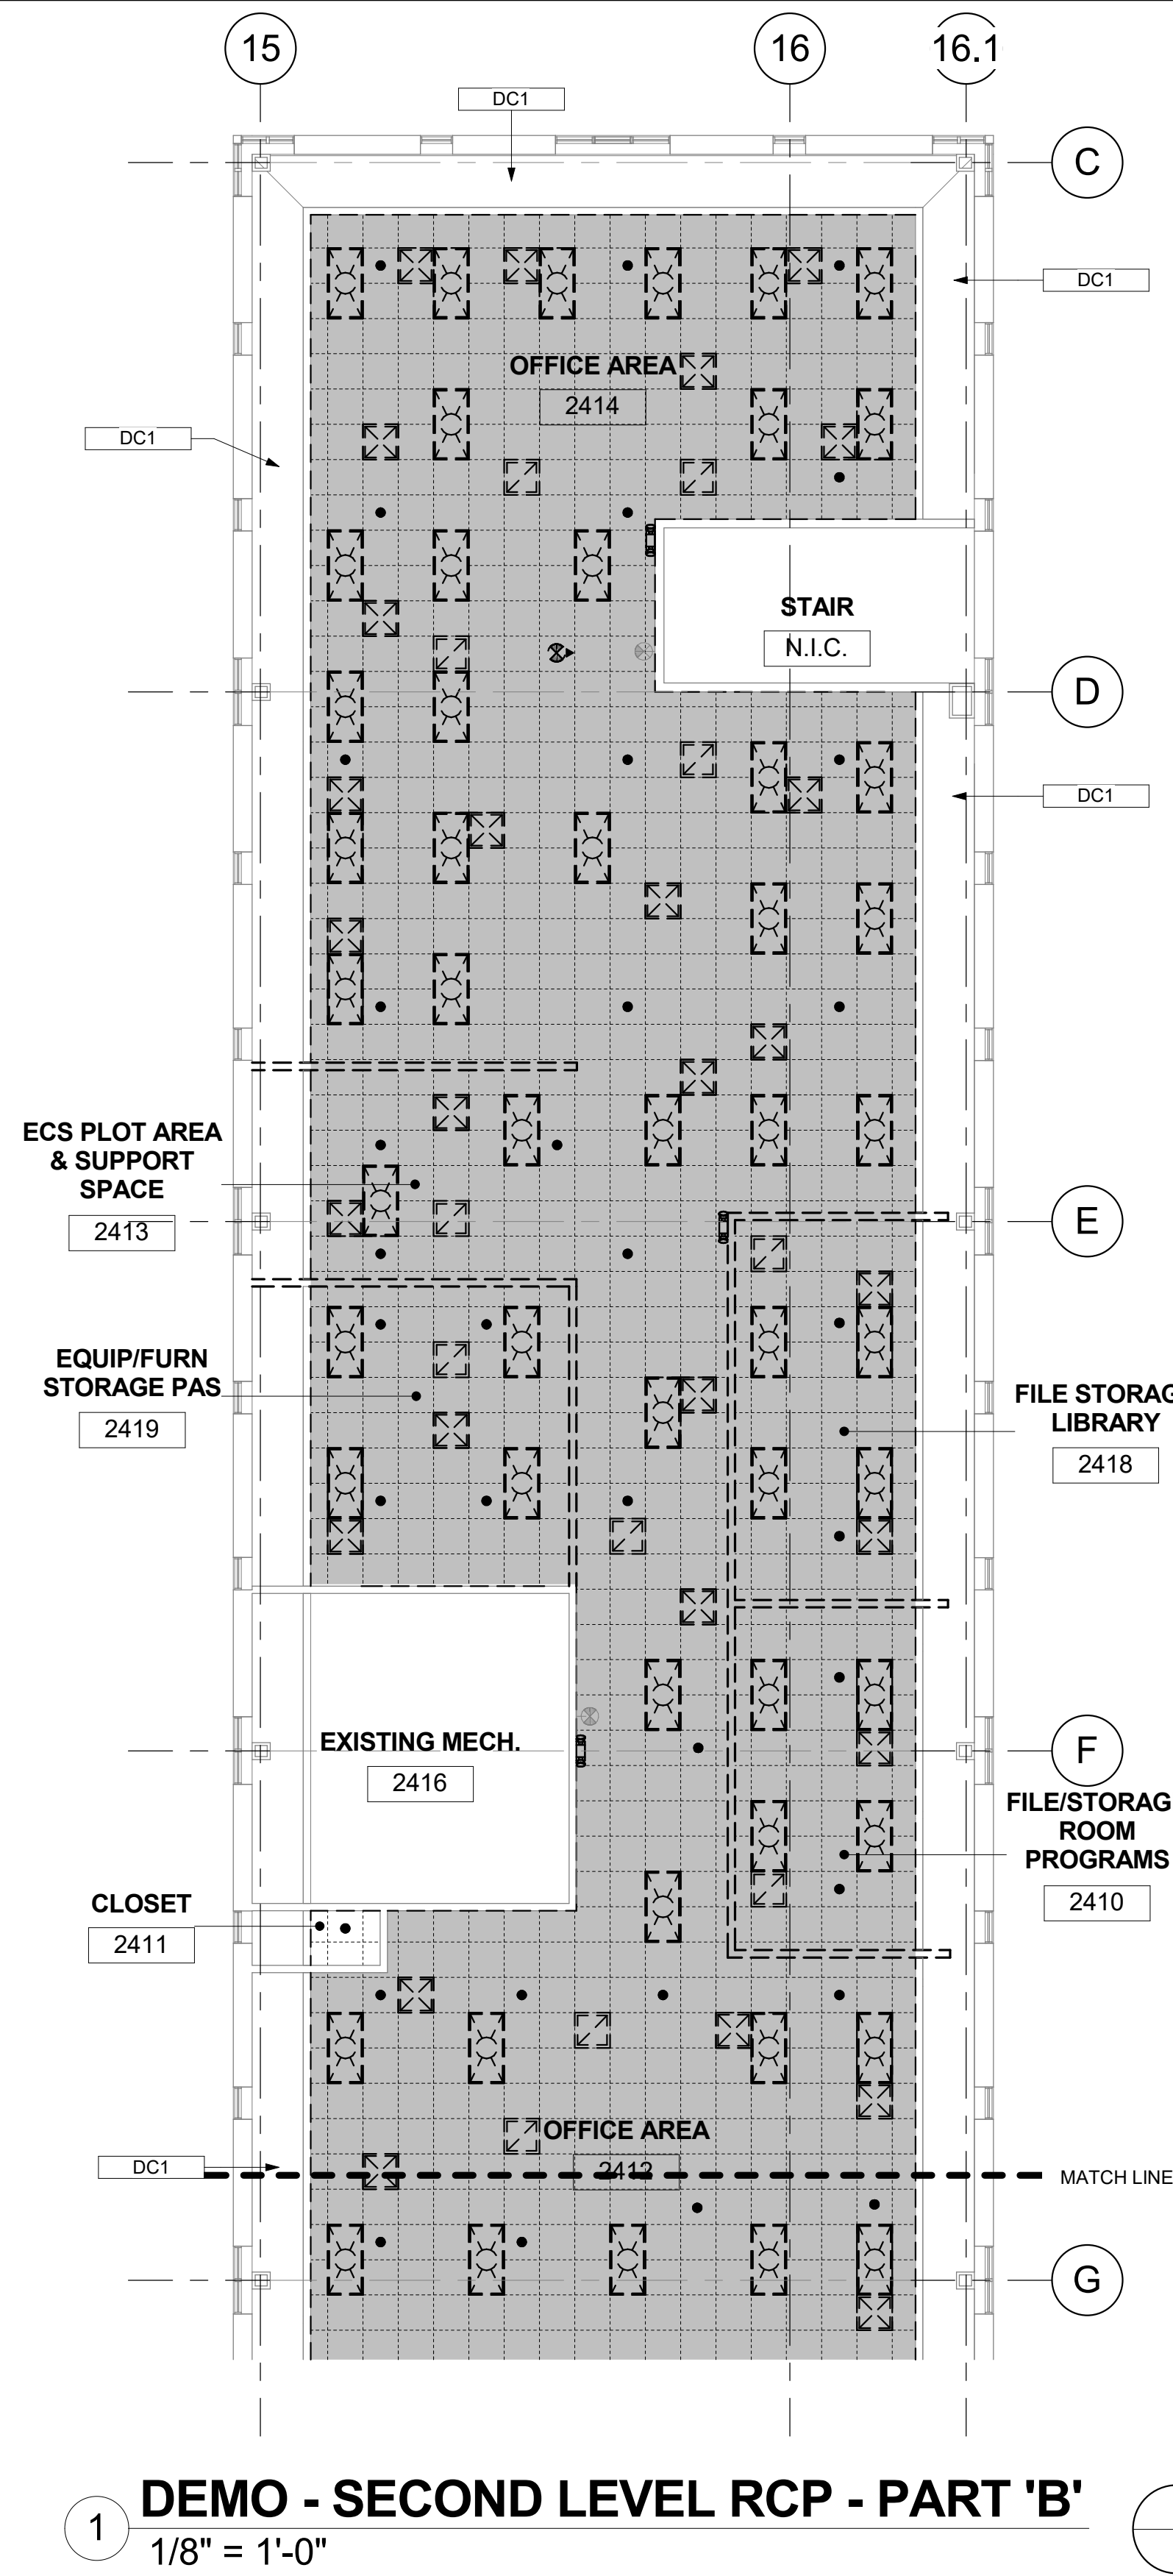

1 DEMO - SECOND LEVEL RCP - PART 'B'
1/8" = 1'-0"

100% CONSTRUCTION DOCUMENTS

BUILDING 56 - 2ND FLOOR NRCS CONSOLIDATION

-- FOR CONSTRUCTION --

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CERTIFICATION


KEY PLAN

2nd FLOOR KEY PLAN

MARK	DATE	DESCRIPTION



CONTRACTORS	
A/E CON. NO.	GS-08P-JB-D-0017
A/E TASK NO.	EP-GS-P-08-16-JB-7053
CONS. CONTR.	GS-08P-13-JB-D-0032
CONS. WORK	
PRIM A/E	ANDERSON HALLAS ARCHITECTS PC
SUB A/E	
CONSTR. CON.	
BUILDING	
NAME	BUILDING 56
STREET	6TH STREET
CITY/ST./ZIP	DENVER, COLORADO 80255
BUILDING NO.	BUILDING 56
OTHER BUILDING NOS	
FACILITY CODE	
PROJECT	
PROJECT TITLE	BUILDING 56 - NRCS
PROJECT DESCRIPTION	BUILDING 56 - 2ND FLOOR NRCS CONSOLIDATION
PROJECT NO.	EP-GS-P-08-16-JB-7053
GSA PM	BEN REKO
SUBMISSION	100 CD ISSUE
SUB. DATE	07/25/2019
DRAWING	
DRAWING TITLE	ENLARGED DEMO REFLECTED CEILING PLANS - PART 'B'
FILE NAME	
FLOOR NO.	2ND FLOOR
DRAWN BY	DAM / LB DATE DRAFTED: 04/15/2019
CHECKED BY	DCA / RS SHEET SIZE: 22X34
DRAWING NO.	A 7 02
DISCIPLINE	SHEET TYPE SEQUENCE
SHEET	13 OF 50

8/8/2019 12:01:02 PM

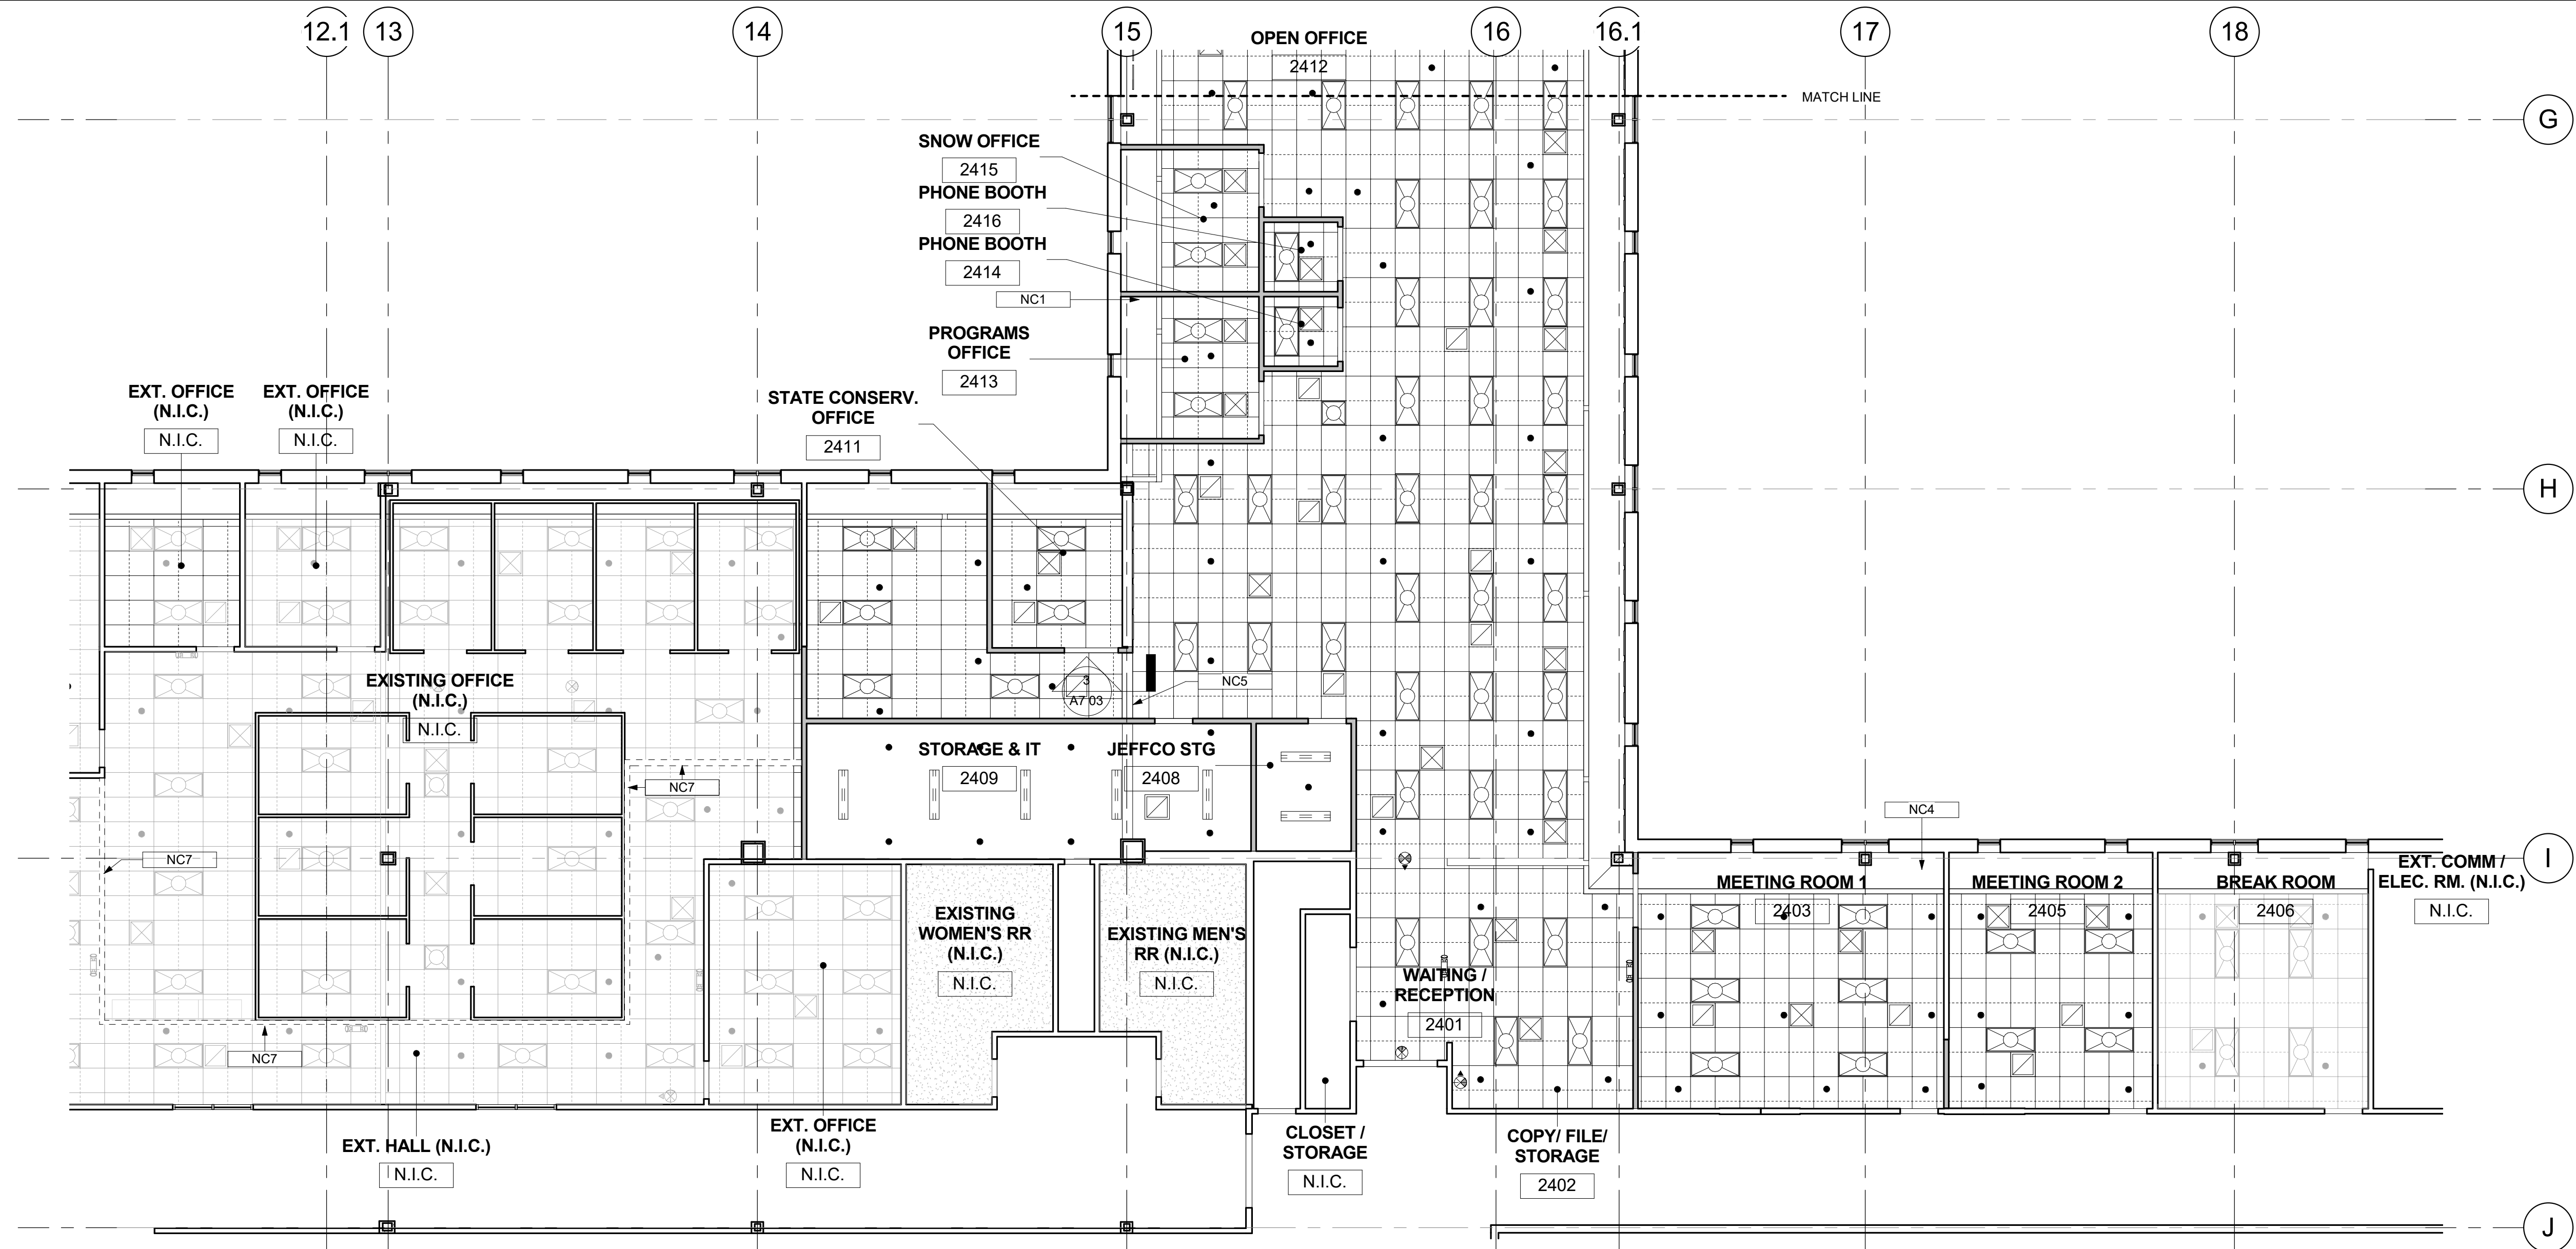

1 NEW - SECOND LEVEL RCP - PART 'A'
1/8" = 1'-0"

CEILING LEGEND:

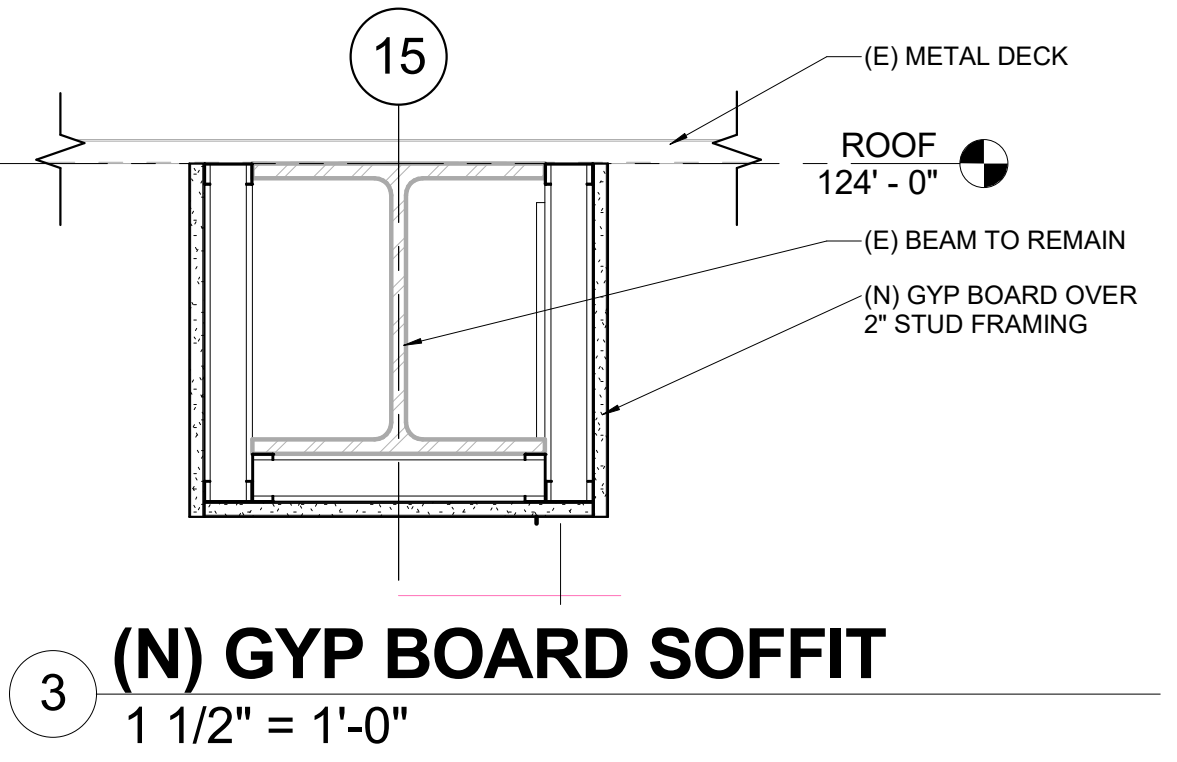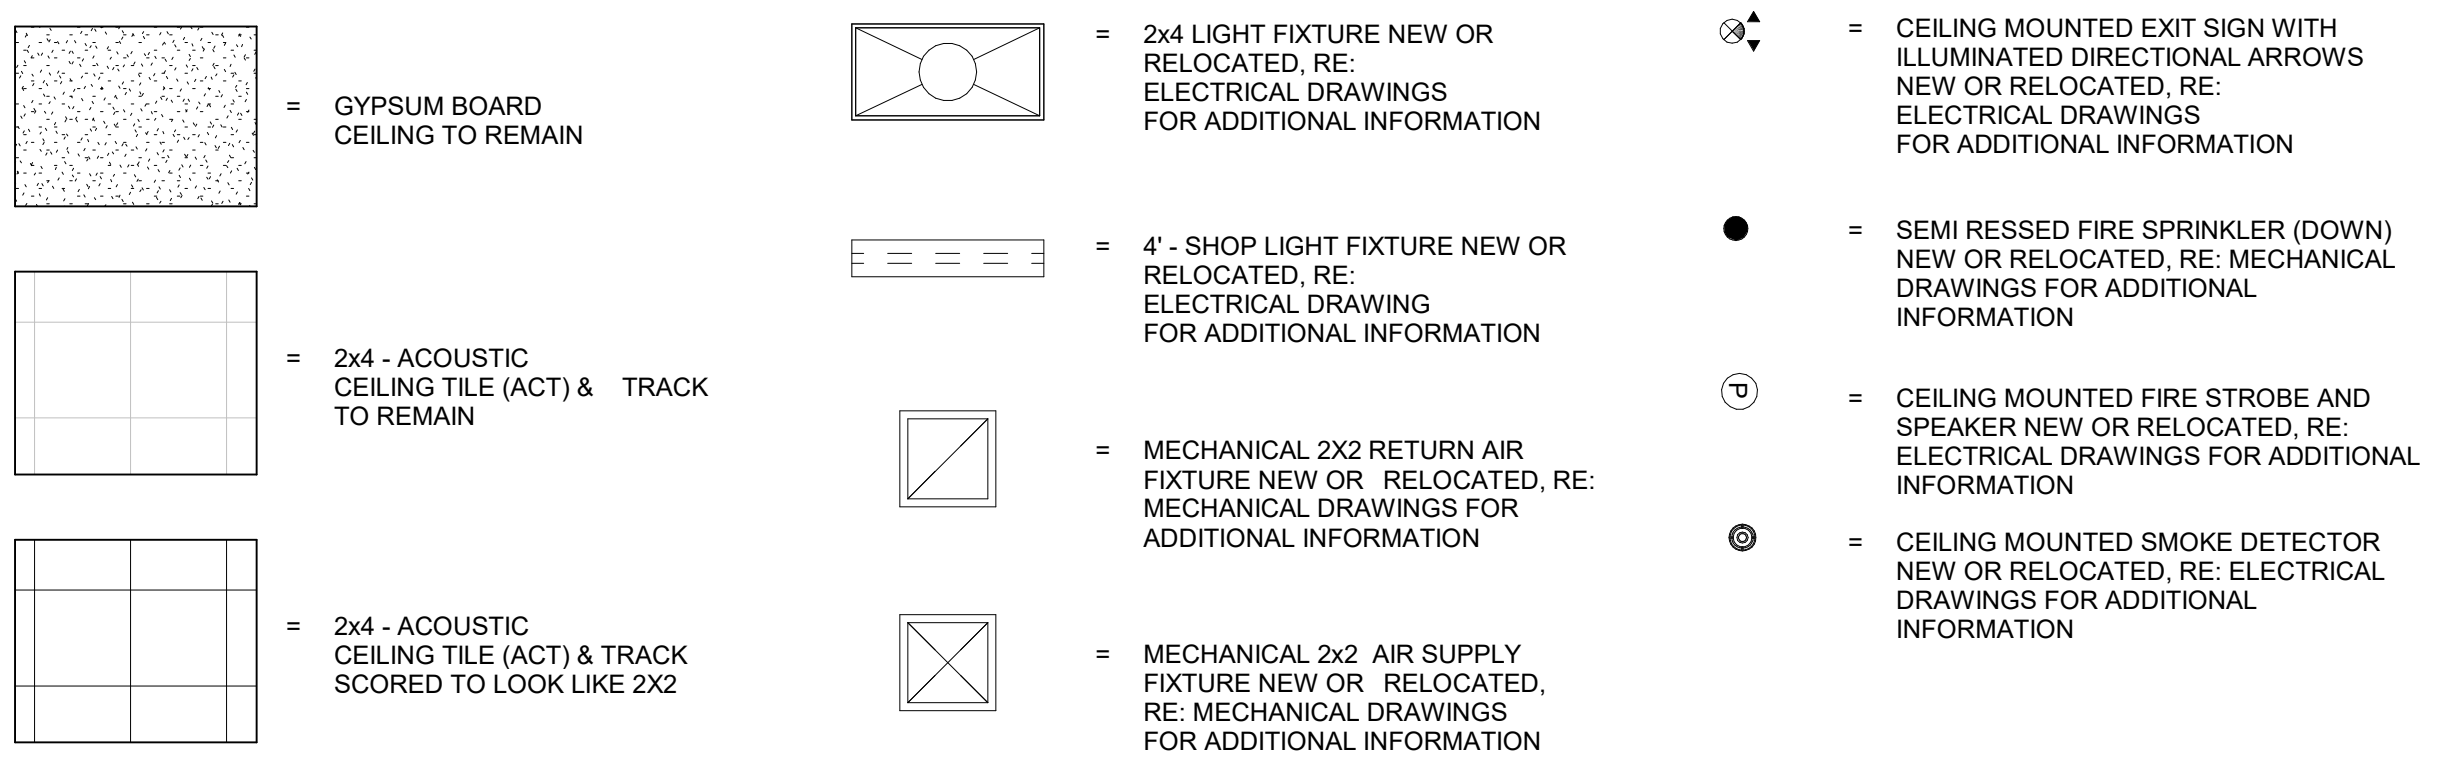

GENERAL CEILING NOTES

- REFER TO MECH., ELEC., FIRE PROTECTION SHEETS FOR CEILING FIXTURE LOCATIONS AND ADDITIONAL INFORMATION
- REINSTALL <E> WINDOW COVERINGS IN SAME LOCATION. PROTECT IN PLACE. TYP. ALL WINDOWS



NEW RCP KEYNOTES

Keynote Text	
NC1	PATCH/REPAIR GWB SOFFIT WHERE WALL REMOVED
NC3	(E) GWB SOFFIT TO REMAIN
NC4	(E) ANGLED GYP. SOFFIT TO REMAIN
NC5	WRAP (E) BEAM W/ GWB
NC6	(E) CEILING AND FIXTURES TO REMAIN
NC7	PATCH/REPAIR (E) ACT CEILING WHERE WALL REMOVED

100% CONSTRUCTION DOCUMENTS
BUILDING 56 - 2ND FLOOR NRCS CONSOLIDATION -- FOR CONSTRUCTION --

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MARK	DATE	DESCRIPTION

CONTRACTORS	BUILDING	PROJECT	DRAWING
A/E CON. NO.	GS-08P-JB-D-0017	PROJECT TITLE	BUILDING 56 - NRCS
A/E TASK NO.	EP-GS-P-08-16-JB-7053	PROJECT DESCRIPTION	BUILDING 56 - 2ND FLOOR NRCS CONSOLIDATION
CONS. CONTR.	GS-08P-13-JB-D-0032	PROJECT NO.	EP-GS-P-08-16-JB-7053
CONS. WORK		GSA PM	BEN REKO
PRIM A/E	ANDERSON HALLAS ARCHITECTS PC	SUBMISSION	100 CD ISSUE
SUB A/E		SUB. DATE	07/25/2019
CONSTR. CON.		DRAWING TITLE	ENLARGED NEW REFLECTED CEILING PLAN - PART 'A'
NAME	BUILDING 56	FILE NAME	
STREET	6TH STREET	FLOOR NO.	2ND FLOOR
CITY/ST./ZIP	DENVER, COLORADO 80255	DRAWN BY	DAM / LB DATE DRAFTED: 04/15/2019
BUILDING NO.	BUILDING 56	CHECKED BY	DCA / RS SHEET SIZE: 22X34
OTHER BUILDING NOS		DRAWING NO.	A 7 03
FACILITY CODE		DISCIPLINE	SHEET TYPE SEQUENCE
PROJECT	BUILDING 56 - NRCS	SHEET	14 OF 50

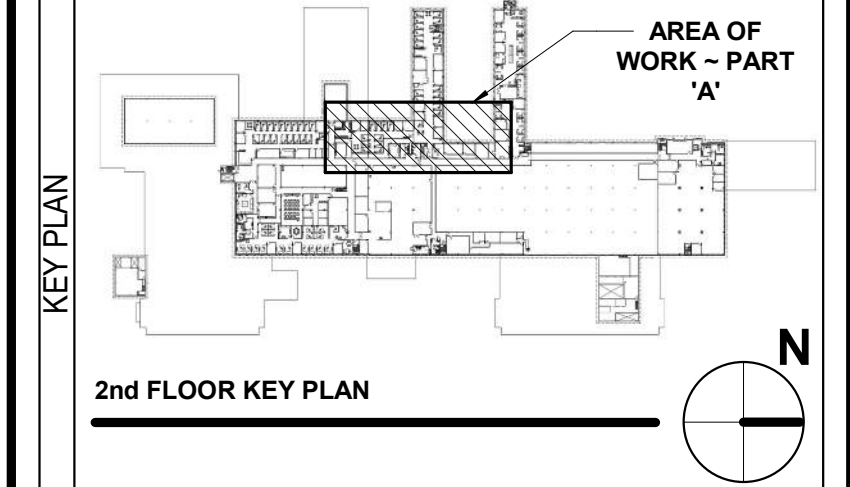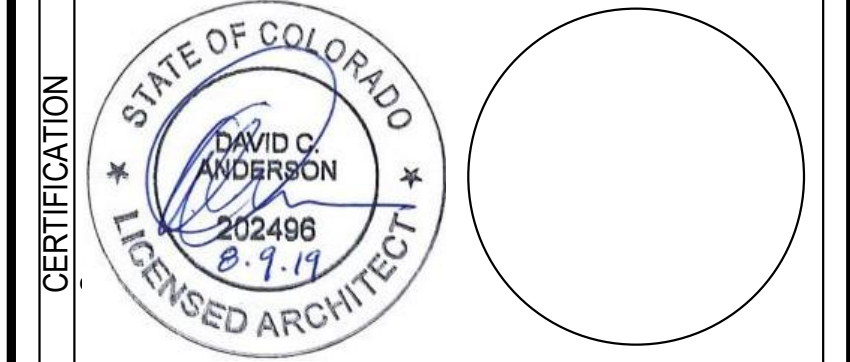GENERAL CEILING NOTES


- REFER TO MECH., ELEC., FIRE PROTECTION SHEETS FOR CEILING FIXTURE LOCATIONS AND ADDITIONAL INFORMATION
- REINSTALL <E> WINDOW COVERINGS IN SAME LOCATION. PROTECT IN PLACE. TYP. ALL WINDOWS

NEW RCP KEYNOTES

	Keynote Text
NC1	PATCH/REPAIR GWB SOFFIT WHERE WALL REMOVED
NC3	(E) GWB SOFFIT TO REMAIN
NC4	(E) ANGLED GYP. SOFFIT TO REMAIN
NC5	WRAP (E) BEAM W/ GWB
NC6	(E) CEILING AND FIXTURES TO REMAIN
NC7	PATCH/REPAIR (E) ACT CEILING WHERE WALL REMOVED

CEILING LEGEND:

	= GYPSUM BOARD CEILING TO REMAIN		= 2x4 LIGHT FIXTURE NEW OR RELOCATED, RE: ELECTRICAL DRAWINGS FOR ADDITIONAL INFORMATION		= CEILING MOUNTED EXIT SIGN WITH ILLUMINATED DIRECTIONAL ARROWS NEW OR RELOCATED, RE: ELECTRICAL DRAWINGS FOR ADDITIONAL INFORMATION
	= 2x4 - ACOUSTIC CEILING TILE (ACT) & TRACK TO REMAIN		= 4' - SHOP LIGHT FIXTURE NEW OR RELOCATED, RE: ELECTRICAL DRAWING FOR ADDITIONAL INFORMATION		= SEMI RESSSED FIRE SPRINKLER (DOWN) NEW OR RELOCATED, RE: MECHANICAL DRAWINGS FOR ADDITIONAL INFORMATION
	= 2x4 - ACOUSTIC CEILING TILE (ACT) & TRACK SCORED TO LOOK LIKE 2X2		= MECHANICAL 2x2 RETURN AIR FIXTURE NEW OR RELOCATED, RE: MECHANICAL DRAWINGS FOR ADDITIONAL INFORMATION		= CEILING MOUNTED FIRE STROBE AND SPEAKER NEW OR RELOCATED, RE: ELECTRICAL DRAWINGS FOR ADDITIONAL INFORMATION
			= MECHANICAL 2x2 AIR SUPPLY FIXTURE NEW OR RELOCATED, RE: MECHANICAL DRAWINGS FOR ADDITIONAL INFORMATION		= CEILING MOUNTED SMOKE DETECTOR NEW OR RELOCATED, RE: ELECTRICAL DRAWINGS FOR ADDITIONAL INFORMATION

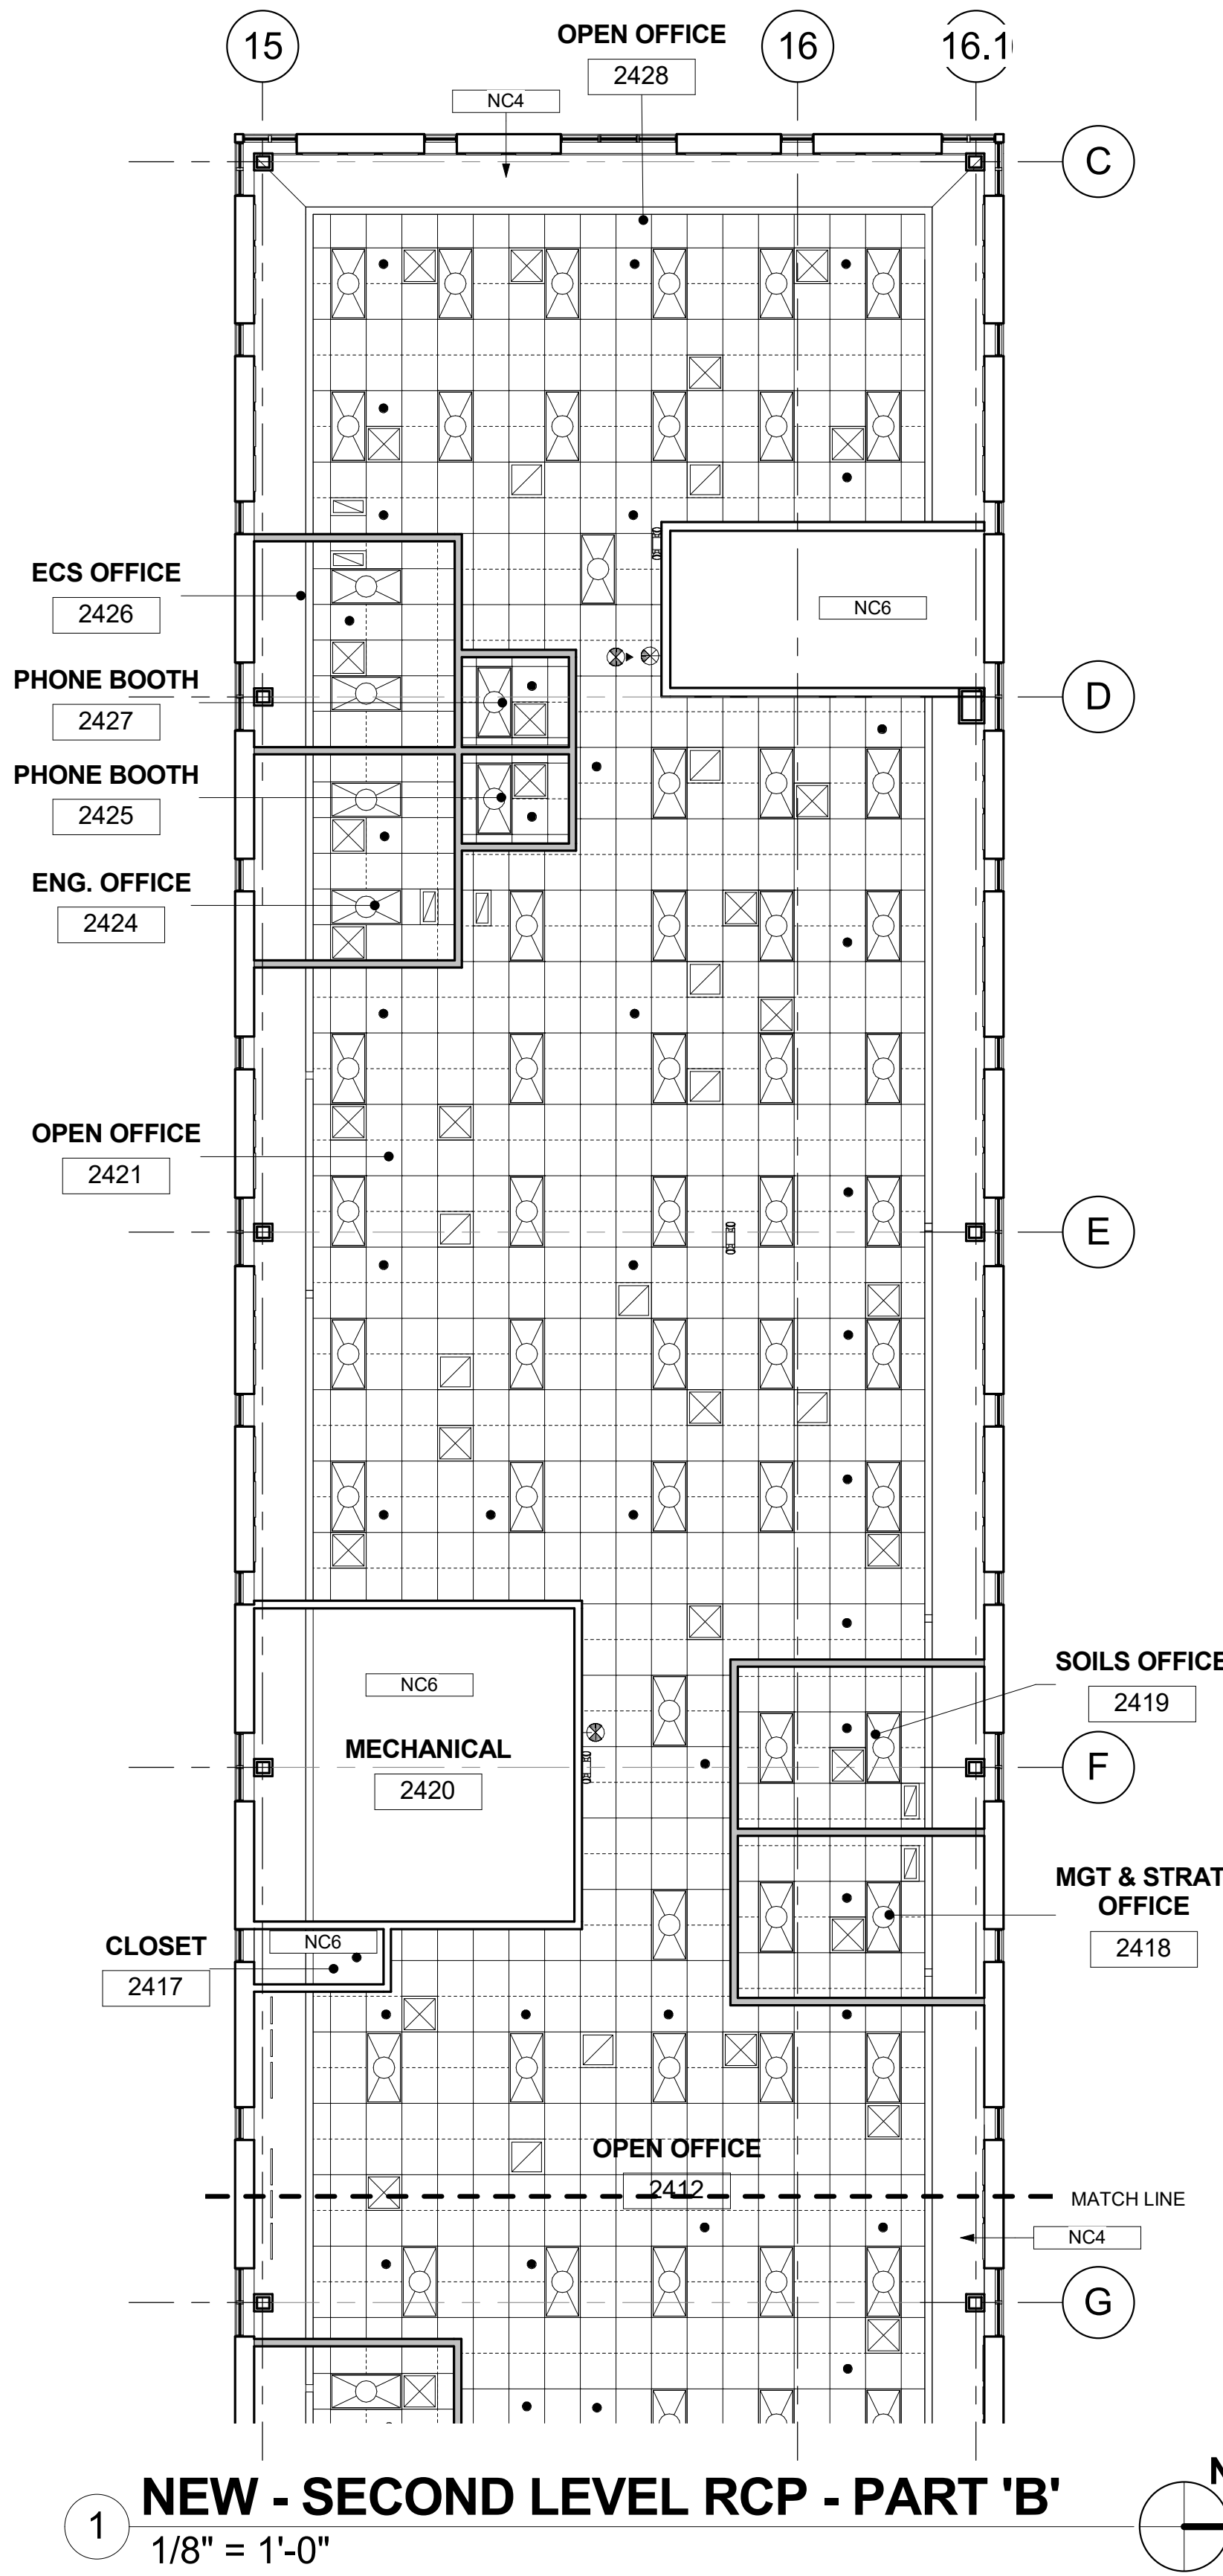

1 NEW - SECOND LEVEL RCP - PART 'B'
1/8" = 1'-0"

100% CONSTRUCTION DOCUMENTS
*BUILDING 56 - 2ND FLOOR
NRCS CONSOLIDATION
-- FOR CONSTRUCTION --*

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CERTIFICATION

KEY PLAN


2nd FLOOR KEY PLAN

MARK	DATE	DESCRIPTION


REVISION NOTES

GRAPHIC SCALE


CONTRACTORS	A/E CON. NO.	GS-08P-JB-D-0017
	A/E TASK NO.	EP-GS-P-08-16-JB-7053
	CONS. CONTR.	GS-08P-13-JB-D-0032
BUILDING	NAME	BUILDING 56
	STREET	6TH STREET
	CITY/ST./ZIP	DENVER, COLORADO 80255
PROJECT	PROJECT TITLE	BUILDING 56 - NRCS
	PROJECT DESCRIPTION	BUILDING 56 - 2ND FLOOR NRCS CONSOLIDATION
	PROJECT NO.	EP-GS-P-08-16-JB-7053
DRAWING	DRAWING TITLE	ENLARGED NEW REFLECTED CEILING PLAN - PART 'B'
	FLOOR NO.	2ND FLOOR
	DRAWN BY	DAM / LB DATE DRAFTED: 04/15/2019
	CHECKED BY	DCA / RS SHEET SIZE: 22X34
	A 7 04	
	DISCIPLINE	SHEET TYPE SEQUENCE
	SHEET	15 OF 50

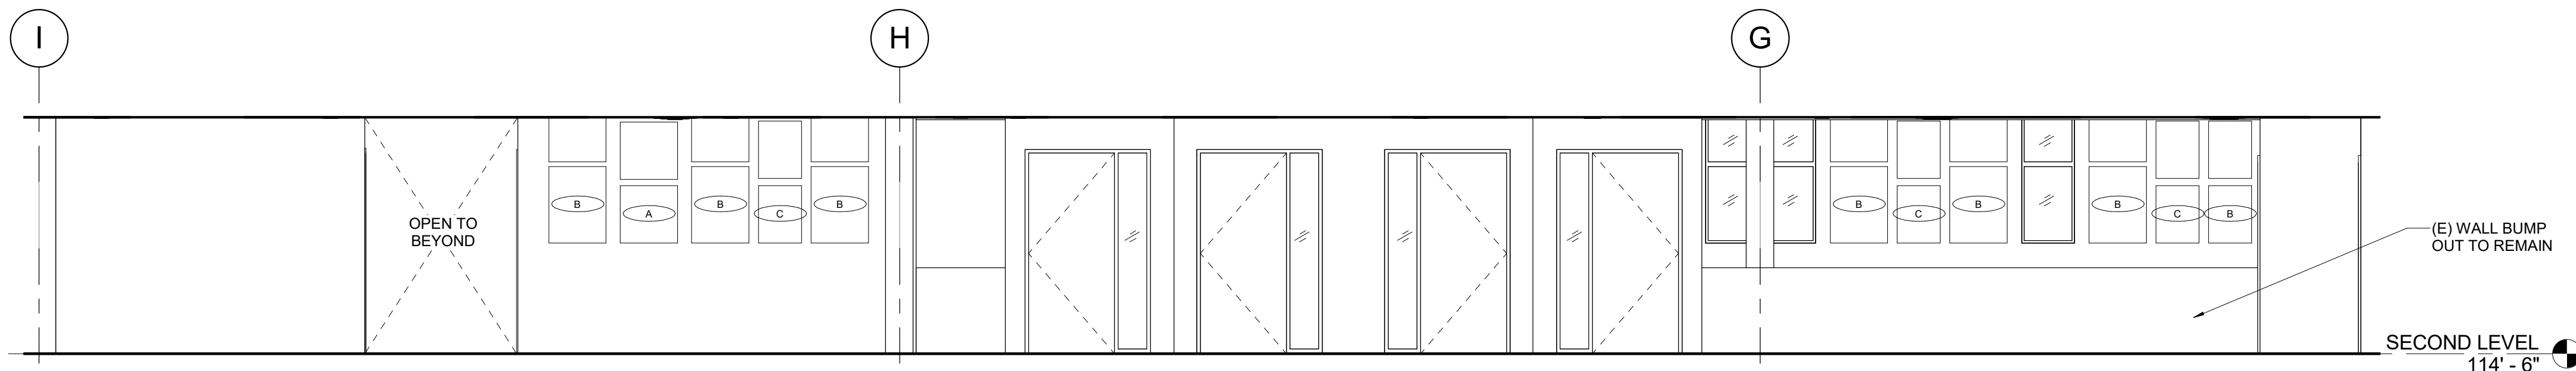


5 **OPEN OFFICE 2412 - SOUTH 1**
1/4" = 1'-0"

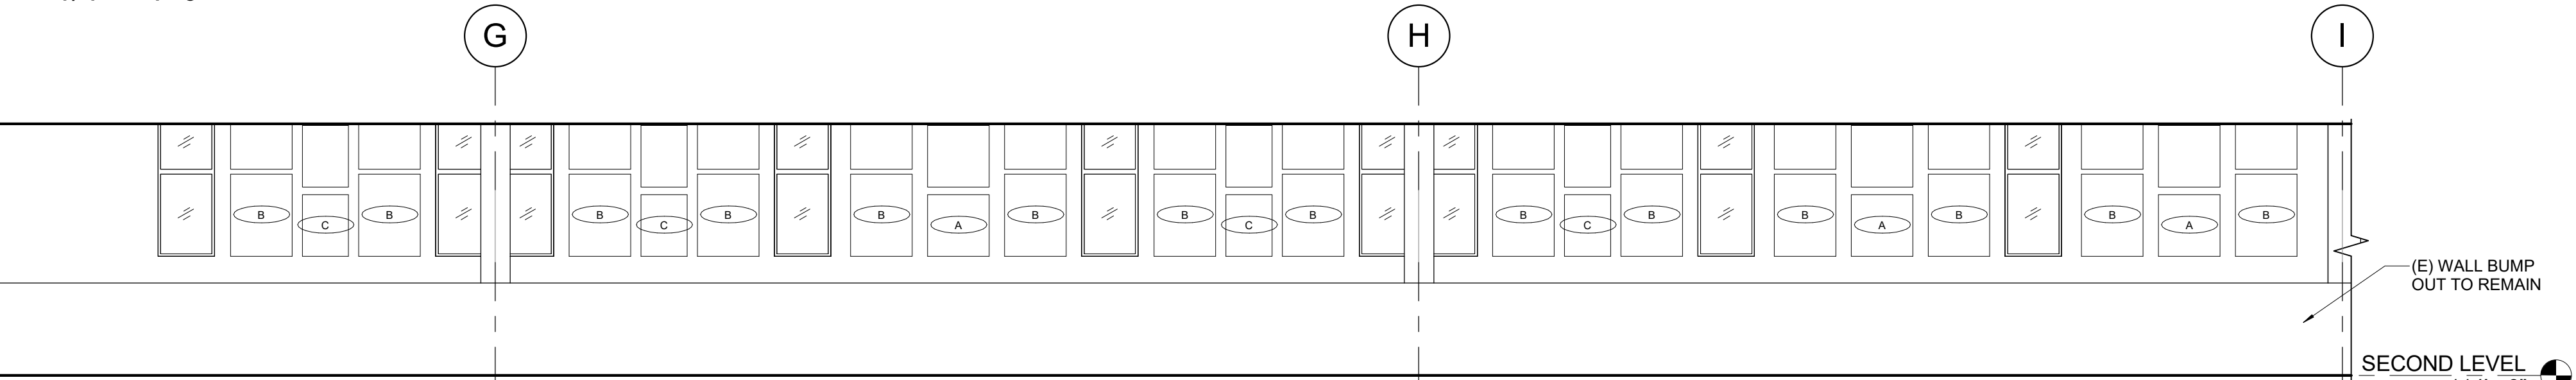


4 **OPEN OFFICE 2412 - NORTH 1**
1/4" = 1'-0"

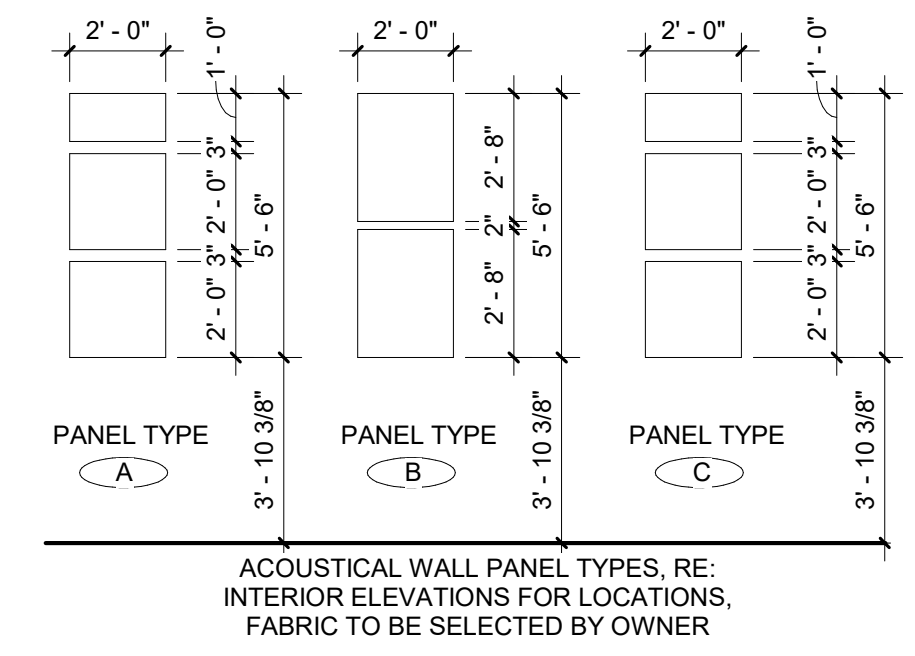


ACOUSTICAL WALL PANEL TYPES, RE: INTERIOR ELEVATIONS FOR LOCATIONS, FABRIC TO BE SELECTED BY OWNER

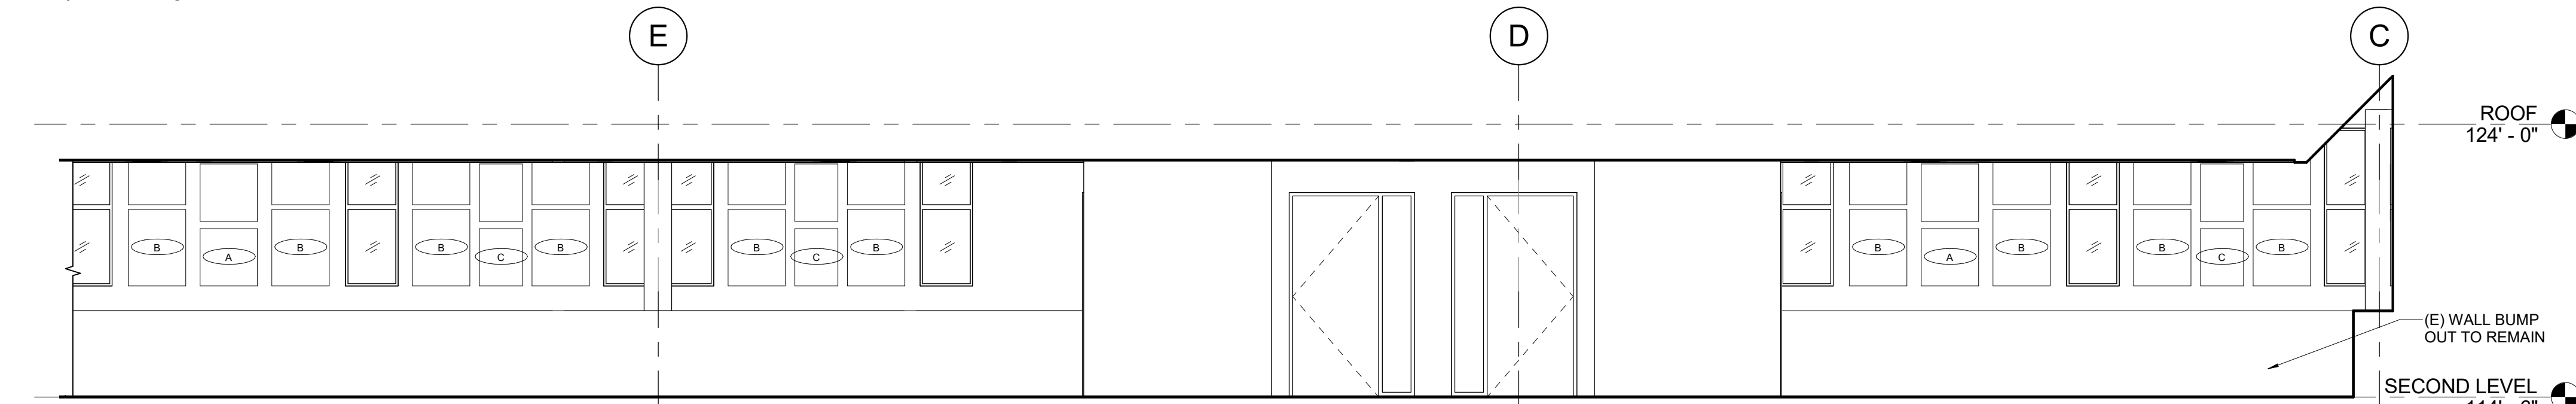

3 **OPEN OFFICE 2421 - SOUTH**
1/4" = 1'-0"

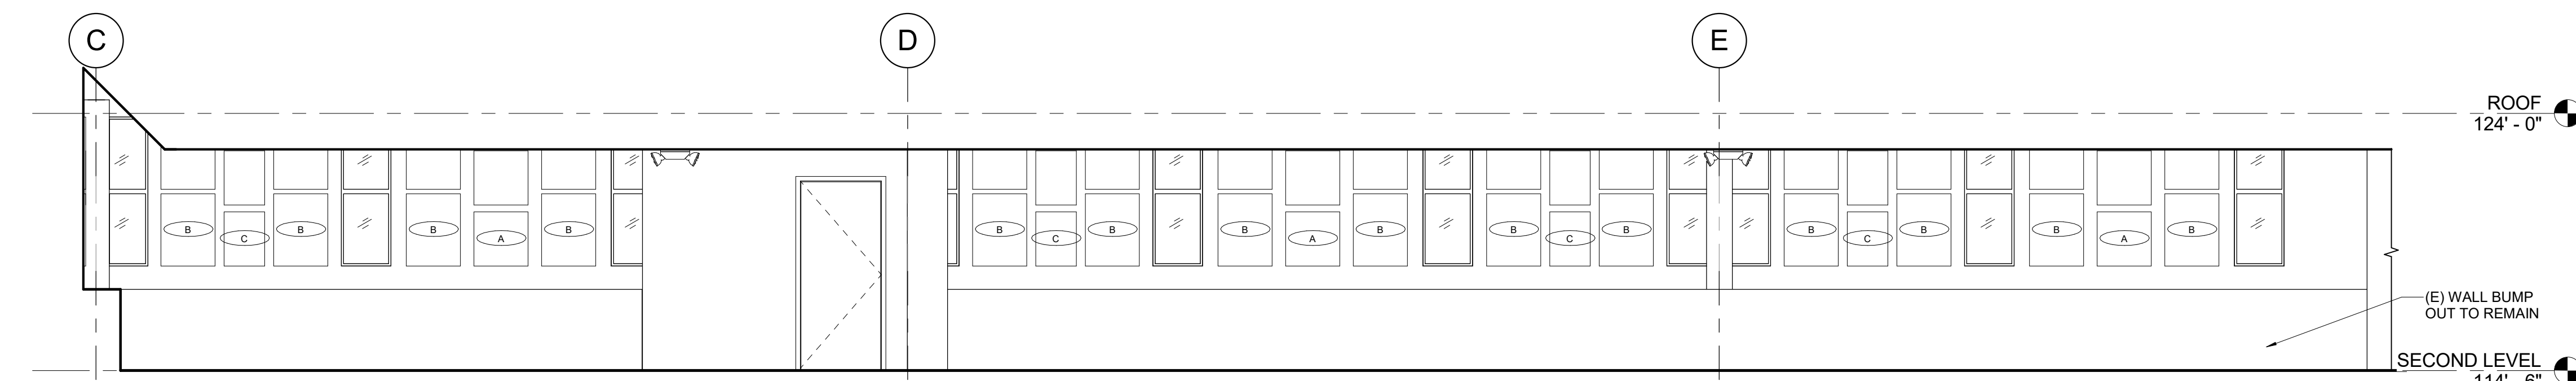


2 **OPEN OFFICE 2421 - NORTH**
1/4" = 1'-0"

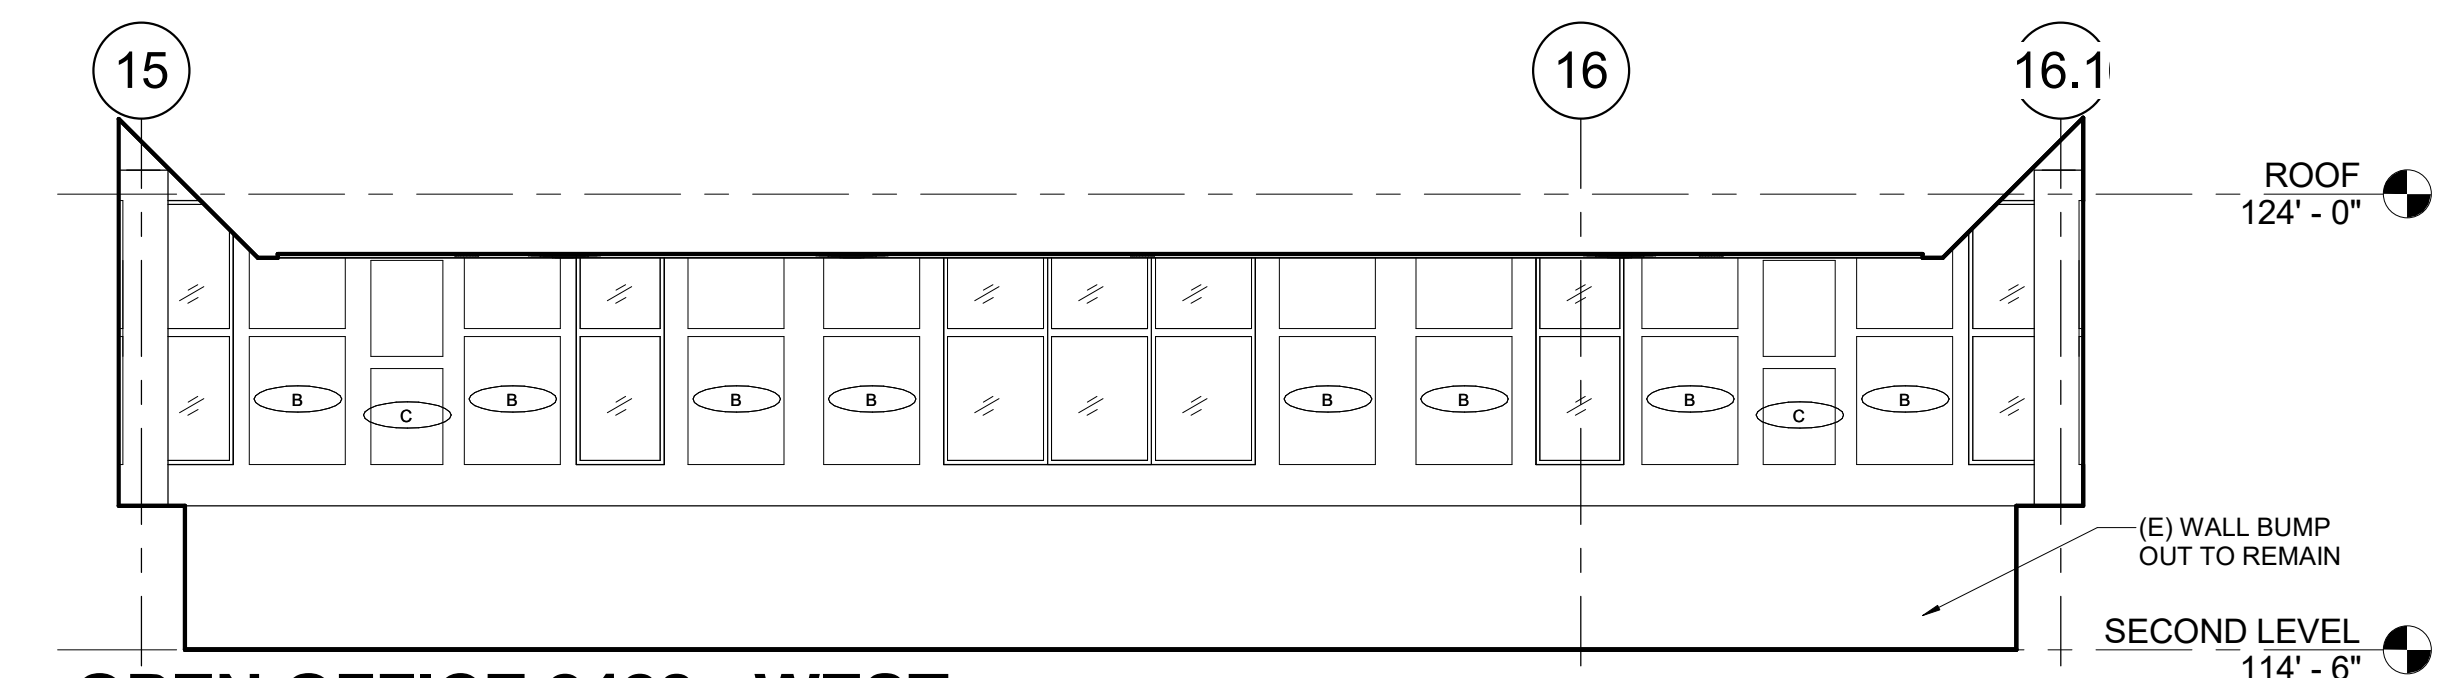

1 **OPEN OFFICE 2428 - WEST**
1/4" = 1'-0"

NOTE:
ACOUSTIC WALL PANELS TO BE ADD ALTERNATE #1.

100% CONSTRUCTION DOCUMENTS
BUILDING 56 - 2ND FLOOR NRCS CONSOLIDATION
-- FOR CONSTRUCTION --

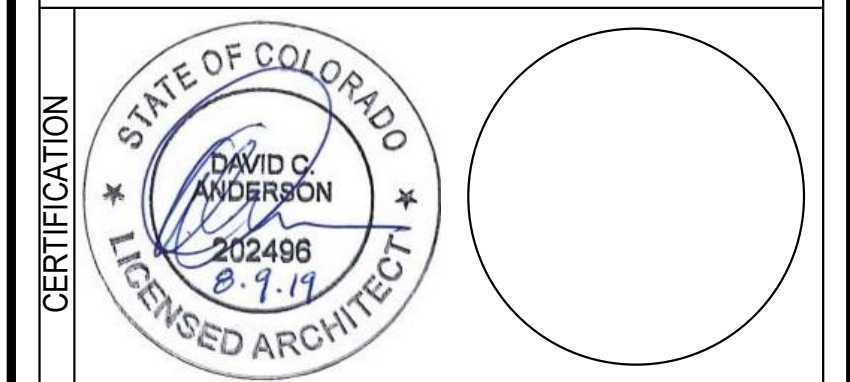

CERTIFICATION

KEY PLAN

MARK	DATE	DESCRIPTION

REVISION NOTES

GRAPHIC SCALE

A/E CON. NO.	GS-08P-JB-D-0017
A/E TASK NO.	EP-GS-P-08-16-JB-7053
CONS. CONTR.	GS-08P-13-JB-D-0032
CONS. WORK	
PRIM A/E	ANDERSON HALLAS ARCHITECTS PC
SUB A/E	
CONSTR. CON.	
NAME	BUILDING 56
STREET	6TH STREET
CITY/ST./ZIP	DENVER, COLORADO 80255
BUILDING NO.	BUILDING 56
OTHER BUILDING NOS	
FACILITY CODE	
PROJECT TITLE	BUILDING 56 - NRCS
PROJECT DESCRIPTION	BUILDING 56 - 2ND FLOOR NRCS CONSOLIDATION
PROJECT NO.	EP-GS-P-08-16-JB-7053
GSA PM	BEN REKO
SUBMISSION	100 CD ISSUE
SUB. DATE	07/25/2019
DRAWING TITLE	INTERIOR ELEVATIONS - OPEN OFFICE
FILE NAME	
FLOOR NO.	
DRAWN BY	CN DATE DRAFTED: 04/15/2019
CHECKED BY	RS SHEET SIZE: 22X34
DRAWING NO.	A 9 01
DISCIPLINE	SHEET TYPE SEQUENCE
SHEET 16	OF 50

CERTIFICATION


KEY PLAN

AREA OF WORK - PART 'A'

TO AHU-15 LOCATED IN MECH 2500

TO AHU-13 LOCATED IN MECH 2308

TO AHU-15 LOCATED IN MECH 2500

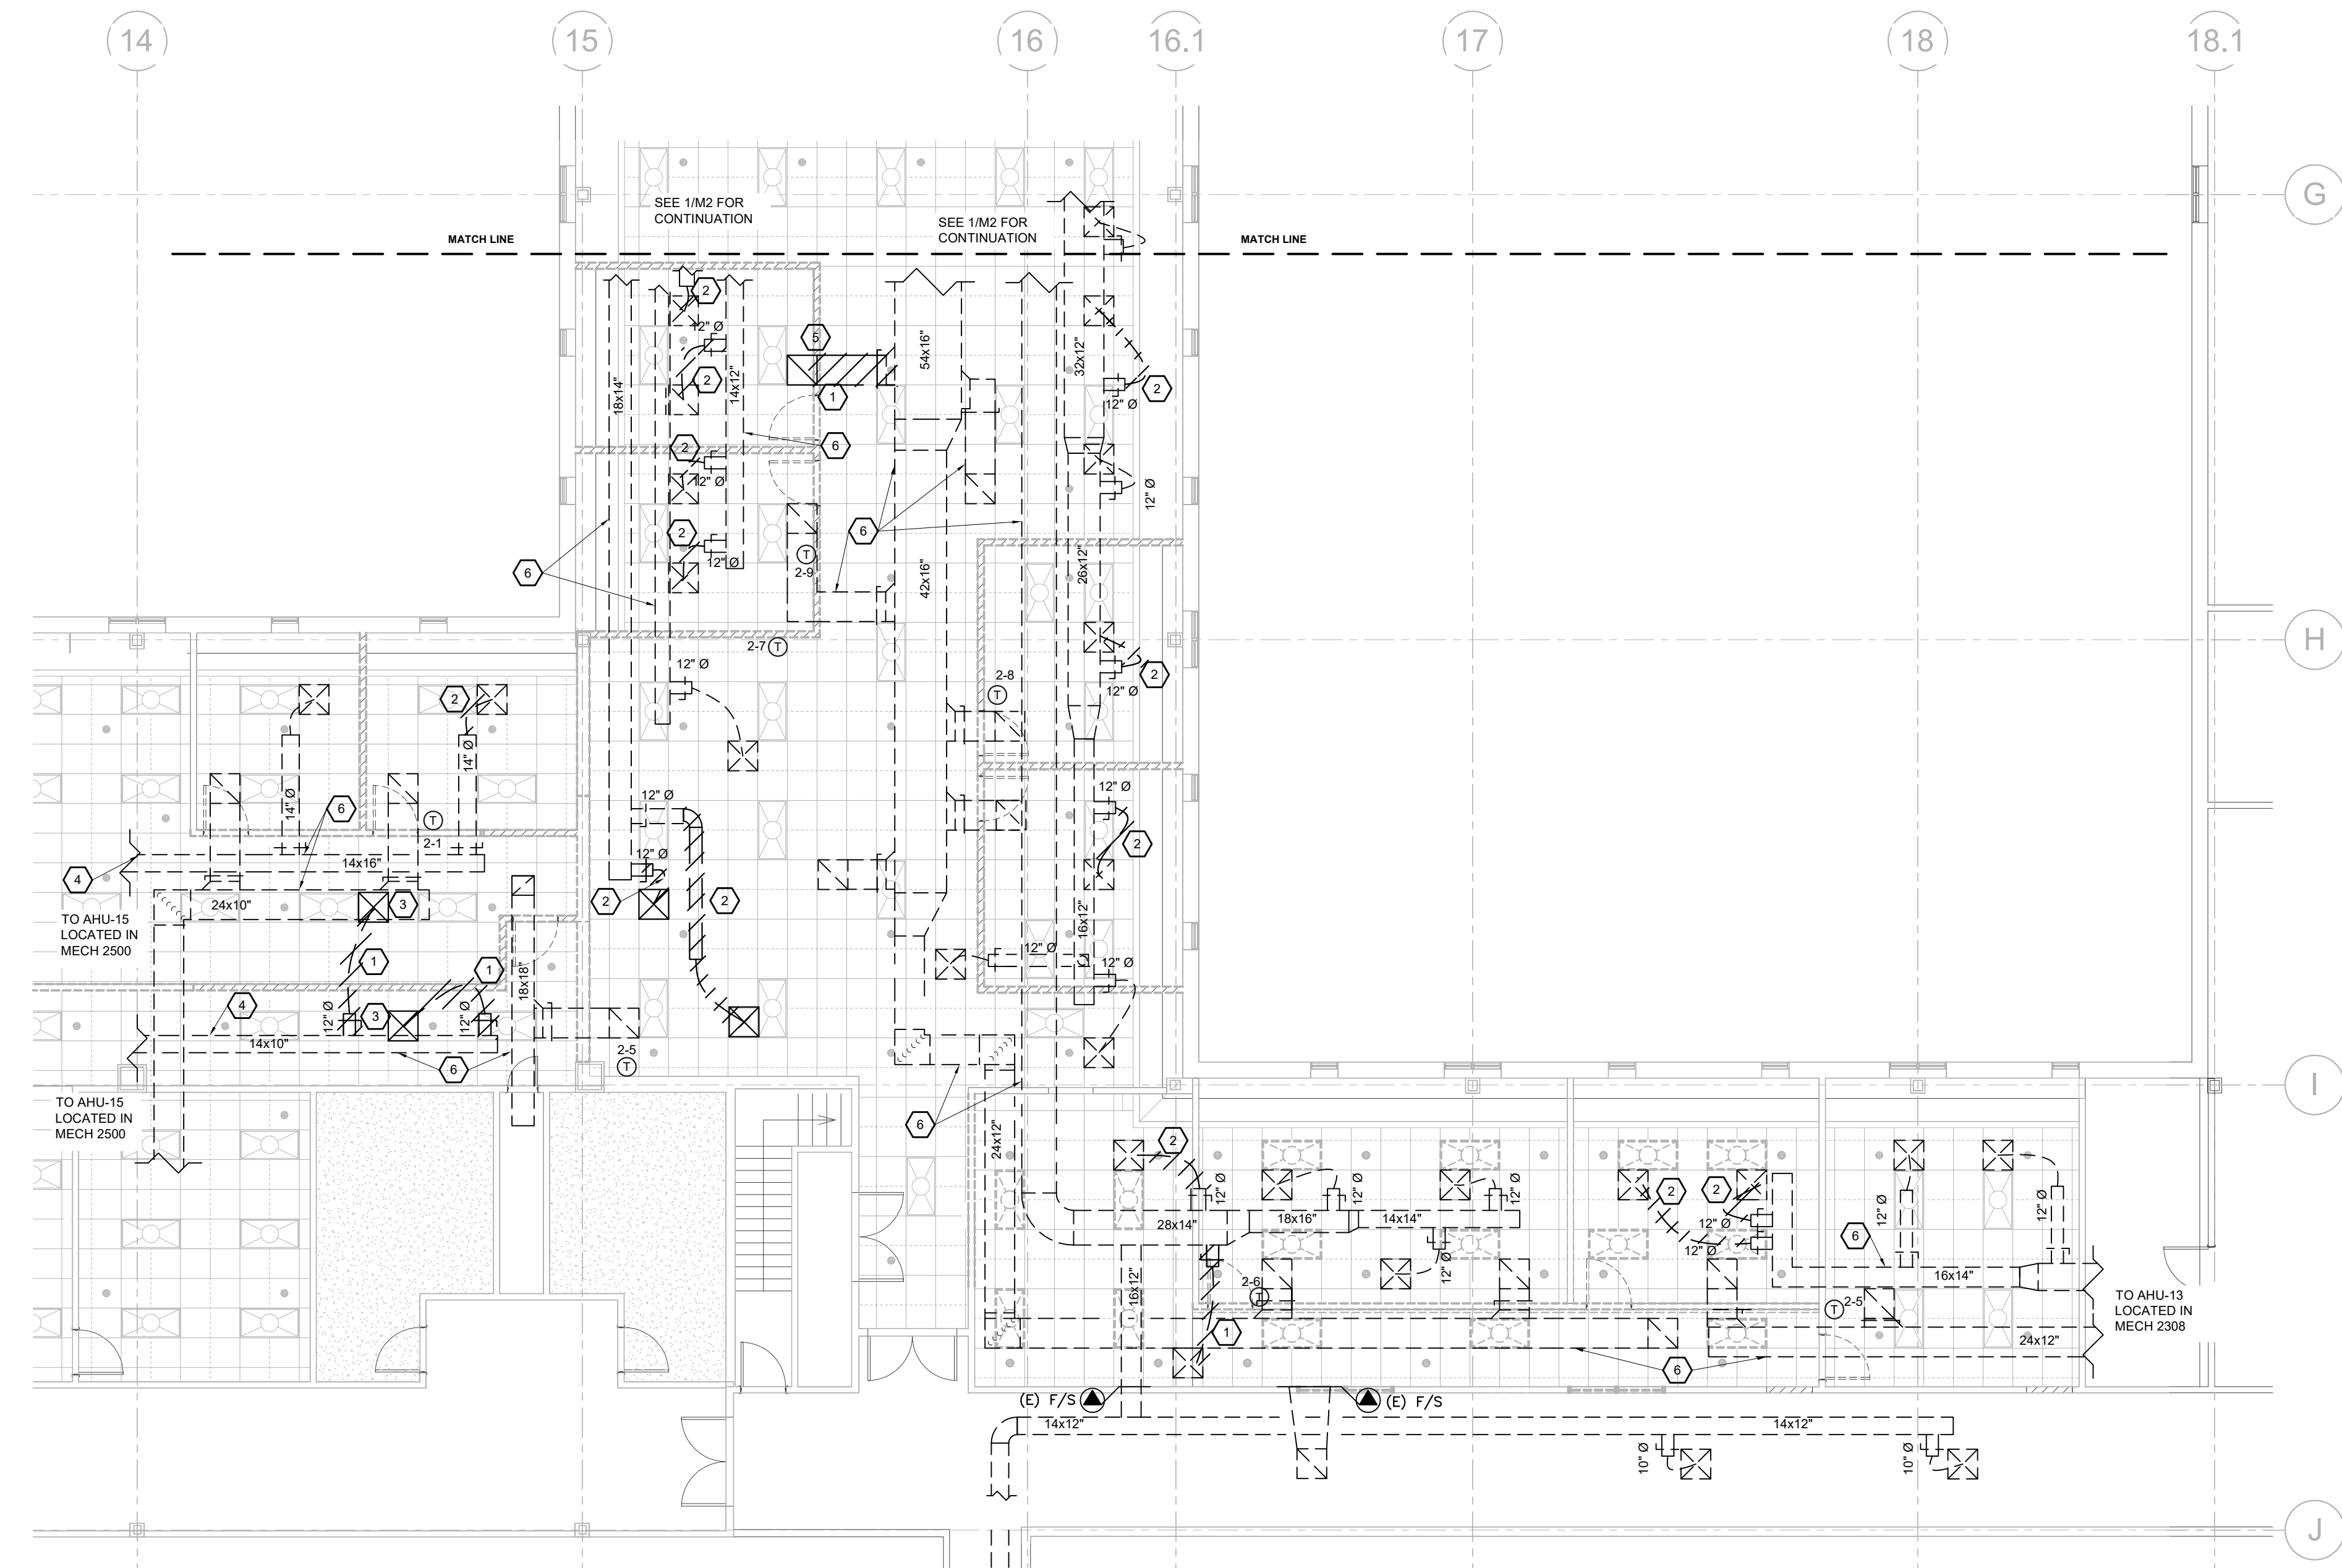

1 MD1 MECHANICAL DEMO PLAN PART A

SCALE: 1/8" = 1'-0"

NORTH

- KEY NOTES:**
- 1 DEMO DUCT BACK AND CAP AS SHOWN.
 - 2 DEMO DUCT BACK AS NEEDED FOR NEW DUCT CONNECTION PER 1/M1.
 - 3 RELOCATE DIFFUSER PER M1.
 - 4 CONTRACTOR TO CHECK BALANCE OF ZONE PRIOR TO CONSTRUCTION. CONTRACTOR TO REBALANCE DIFFUSERS OUTSIDE OF THIS SCOPE TO MEASURED BALANCE FOLLOWING CONSTRUCTION.
 - 5 RELOCATE RETURN GRILLE PER M1.
 - 6 EXISTING TO REMAIN.

REVISION NOTES

MARK	DATE	DESCRIPTION

CONTRACTOR GRAPHIC SCALE

A/E CON. NO.	GS-08P-JB-D-0017
A/E TASK NO.	EP-GS-P-08-16-JB-7053
CONS. CONTR.	GS-08P-13-JB-D-0032
CONS. WORK	
PRIM A/E	ANDERSON HALLAS ARCHITECT PC
SUB A/E	
CONSTR. CON.	
NAME	BUILDING 56
STREET	6TH STREET
CITY/ST./ZIP	DENVER, COLORADO 80255
BUILDING NO.	BUILDING 56
OTHER BUILDING NOS	
FACILITY CODE	
PROJECT TITLE	BUILDING 56 - NRCS
PROJECT DESCRIPTION	BUILDING 56 - 2ND FLOOR NRCS CONSOLIDATION
PROJECT NO.	EP-GS-P-08-16-JB-7053
GSA PM	BEN REKO
SUBMISSION	100% CONSTRUCTIONS DOCUMENTS
SUB. DATE	7/25/2019
DRAWING TITLE	MECHANICAL DEMO PLAN PART A
FILE NAME	
FLOOR NO.	2ND FLOOR
DRAWN BY	JSW DATE DRAFTED: 12/04/2017
CHECKED BY	TCM/DMD SHEET SIZE: 22X34
DRAWING NO.	MD1
DISCIPLINE	MECHANICAL
SHEET TYPE	SEQUENCE
SHEET	18 OF 50

GENERAL SERVICES ADMINISTRATION

GSA

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Principal: Dave Anderson
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360
Three Sixty Engineering, Inc.
600 Broadway, Suite 2500
Denver, CO 80202
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303.541.3222 fax
877.541.1414
E/M/D



CERTIFICATION


KEY PLAN

MARK	DATE	DESCRIPTION

REVISION NOTES

GRAPHIC SCALE

CONTRACTOR	A/E CON. NO.	GS-08P-JB-D-0017
	A/E TASK NO.	EP-GS-P-08-16-JB-7053
	CONS. CONTR.	GS-08P-13-JB-D-0032
	CONS. WORK	
	PRIM A/E	ANDERSON HALLAS ARCHITECT PC
	SUB A/E	
	CONSTR. CON.	
BUILDING	NAME	BUILDING 56
	STREET	6TH STREET
	CITY/ST./ZIP	DENVER, COLORADO 80255
	BUILDING NO.	BUILDING 56
OTHER BUILDING NOS		
FACILITY CODE		
PROJECT	PROJECT TITLE	BUILDING 56 - NRCS
	PROJECT DESCRIPTION	BUILDING 56 - 2ND FLOOR NRCS CONSOLIDATION
	PROJECT NO.	EP-GS-P-08-16-JB-7053
	GSA PM	BEN REKO
	SUBMISSION	100% CONSTRUCTIONS DOCUMENTS
	SUB. DATE	7/25/2019
DRAWING	DRAWING TITLE	MECHANICAL FLOOR PLAN PART A
	FILE NAME	
	FLOOR NO.	2ND FLOOR
	DRAWN BY	JSW DATE DRAFTED: 12/04/2017
	CHECKED BY	TCM/DMD SHEET SIZE: 22X34
	DRAWING NO.	M 1
	DISCIPLINE	MECHANICAL
	SHEET TYPE	
	SEQUENCE	
	SHEET	19 OF 50

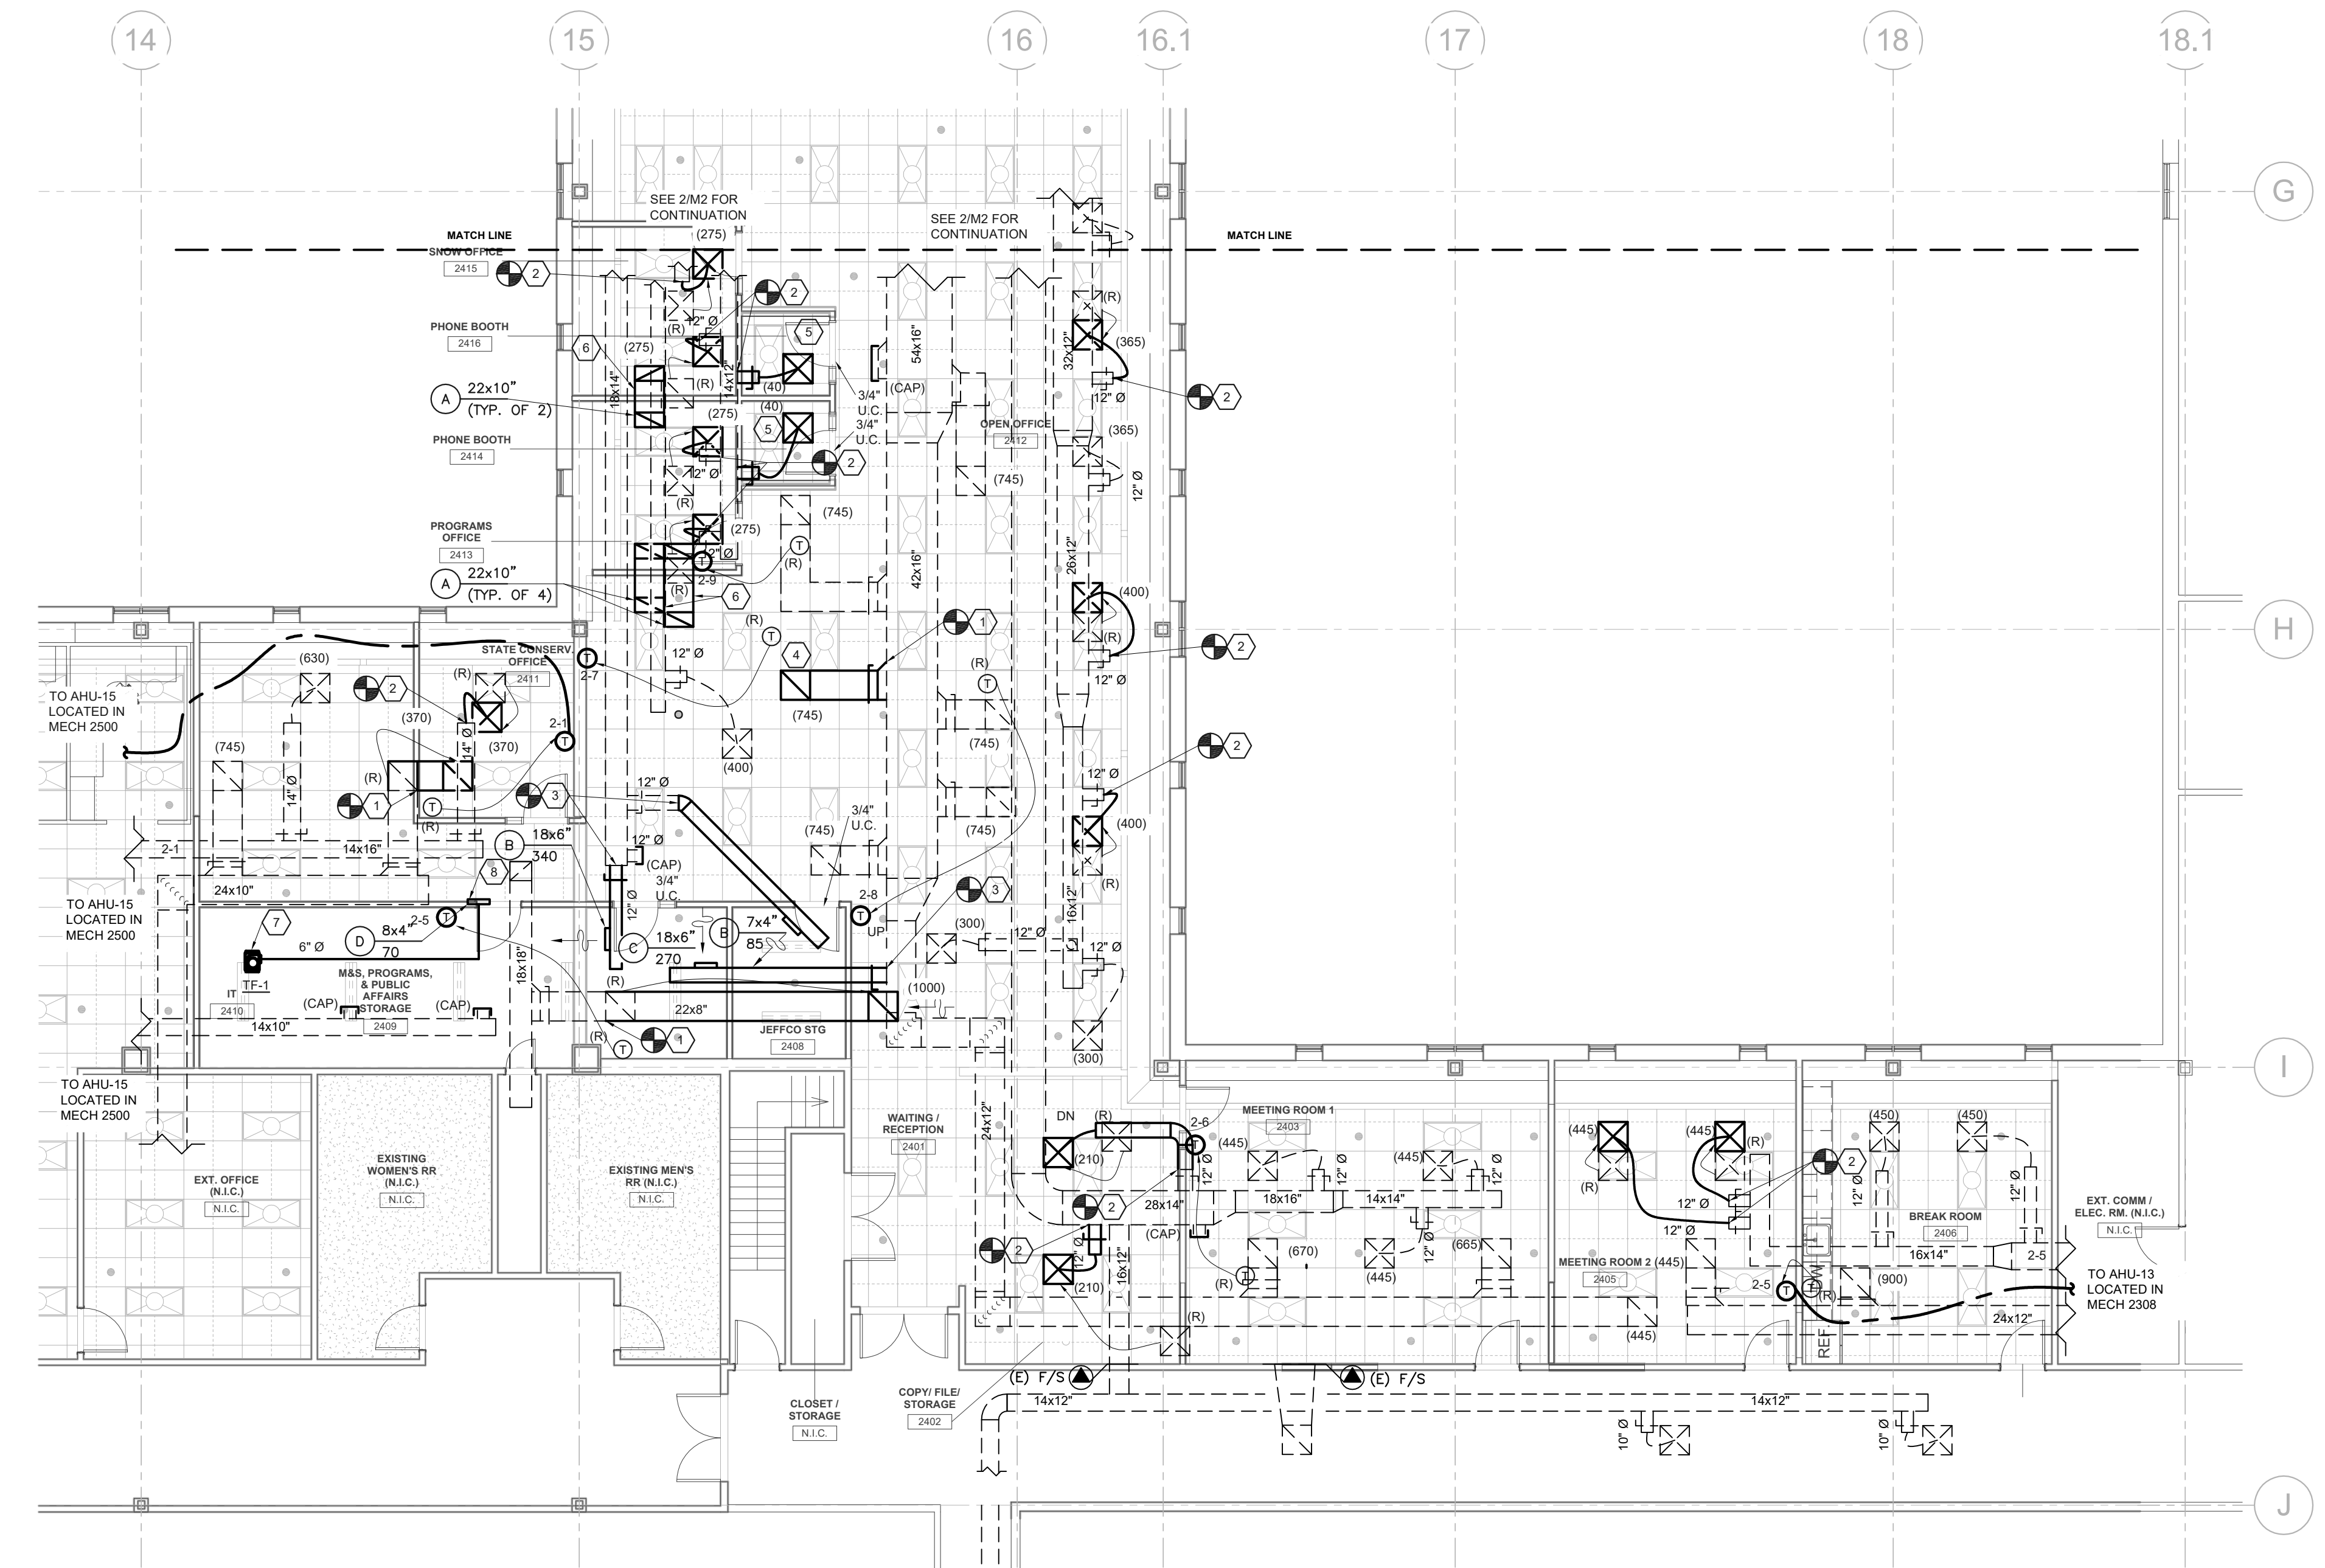

1 MECHANICAL FLOOR PLAN PART A
SCALE: 1/8" = 1'-0"
NORTH


- KEY NOTES:**
- CONNECT NEW 22x8" DUCT TO EXISTING AND ROUTE TO RELOCATED RETURN GRILLE AS SHOWN.
 - CONNECT NEW 12" Ø DUCT TO EXISTING.
 - CONNECT NEW 12" Ø SPIRAL DUCT TO EXISTING AND ROUTE THROUGH EXPOSED CEILING AREA AS SHOWN.
 - RELOCATED RETURN GRILLE FROM MD1.
 - RELOCATED DIFFUSER FROM MD1.
 - PROVIDE AND INSTALL 22x10" TRANSFER DUCT BETWEEN (2) NEW RETURN AIR GRILLES.
 - PROVIDE AND INSTALL NEW TRANSFER FAN AND SUSPEND FROM STRUCTURE.
 - 6" Ø DUCT FROM TRANSFER FAN DISCHARGE TO WALL MOUNTED GRILLE. MOUNT GRILLE HIGH ON WALL BELOW CEILING LEVEL.

11/23/2017 10:52:16 AM


PLUMBING LEGEND	
---	COLD WATER
----	HOT WATER
- - - -	VENT
- - - -	WASTE

KEY NOTES:

- 1 PROVIDE AND INSTALL NEW SINK WITH GARBAGE DISPOSAL WITH 1/2" CW, 1/2" HW, 2" W AND 1-1/2" V CONNECTIONS.
- 2 PROVIDE 1/2" HW CONNECTION TO NEW DISHWASHER AND ROUTE DISHWASHER DRAIN TO GARBAGE DISPOSAL THROUGH CODE APPROVED AIRGAP.
- 3 CONNECT NEW 3/4" HW LINE TO EXISTING HW LINE SERVED BY EXISTING WATER HEATER SERVING WOMEN'S RESTROOM ON FIRST FLOOR (ABOUT 15' AWAY FROM BREAK ROOM) AND ROUTE UP TO BREAK ROOM TO SERVE NEW FIXTURES. PROVIDE NEW LINE WITH BALL VALVE FOR ISOLATION. CONTRACTOR TO CONFIRM EXACT LOCATION OF WATER HEATER IN FIELD.
- 4 CONNECT NEW 2" W AND 1-1/2" V LINES TO EXISTING WV LINES SERVING FIRST FLOOR RESTROOMS (ABOUT 15' AWAY FROM BREAK ROOM). CONTRACTOR TO VERIFY EXACT LOCATIONS OF MAIN WV LINES IN FIELD.
- 5 CONNECT NEW 1/2" CW LINE TO EXISTING CW MAIN ON FIRST FLOOR (ABOUT 15' AWAY FROM BREAK ROOM) AND ROUTE UP TO SERVE NEW SINK. PROVIDE NEW LINE WITH BALL VALVE FOR ISOLATION. CONTRACTOR TO CONFIRM EXACT LOCATION OF CW MAIN IN FIELD.
- 6 PROVIDE AND INSTALL ICE MAKER BOX WITH 1/2" CW CONNECTION. PROVIDE CW SUPPLY LINE WITH AUTOMATIC WATER SHUT-OFF VALVE AND WIRELESS LEAK DETECTION. PROVIDE ACCESS PANEL IN WALL FOR AUTOMATIC SHUT-OFF VALVE.

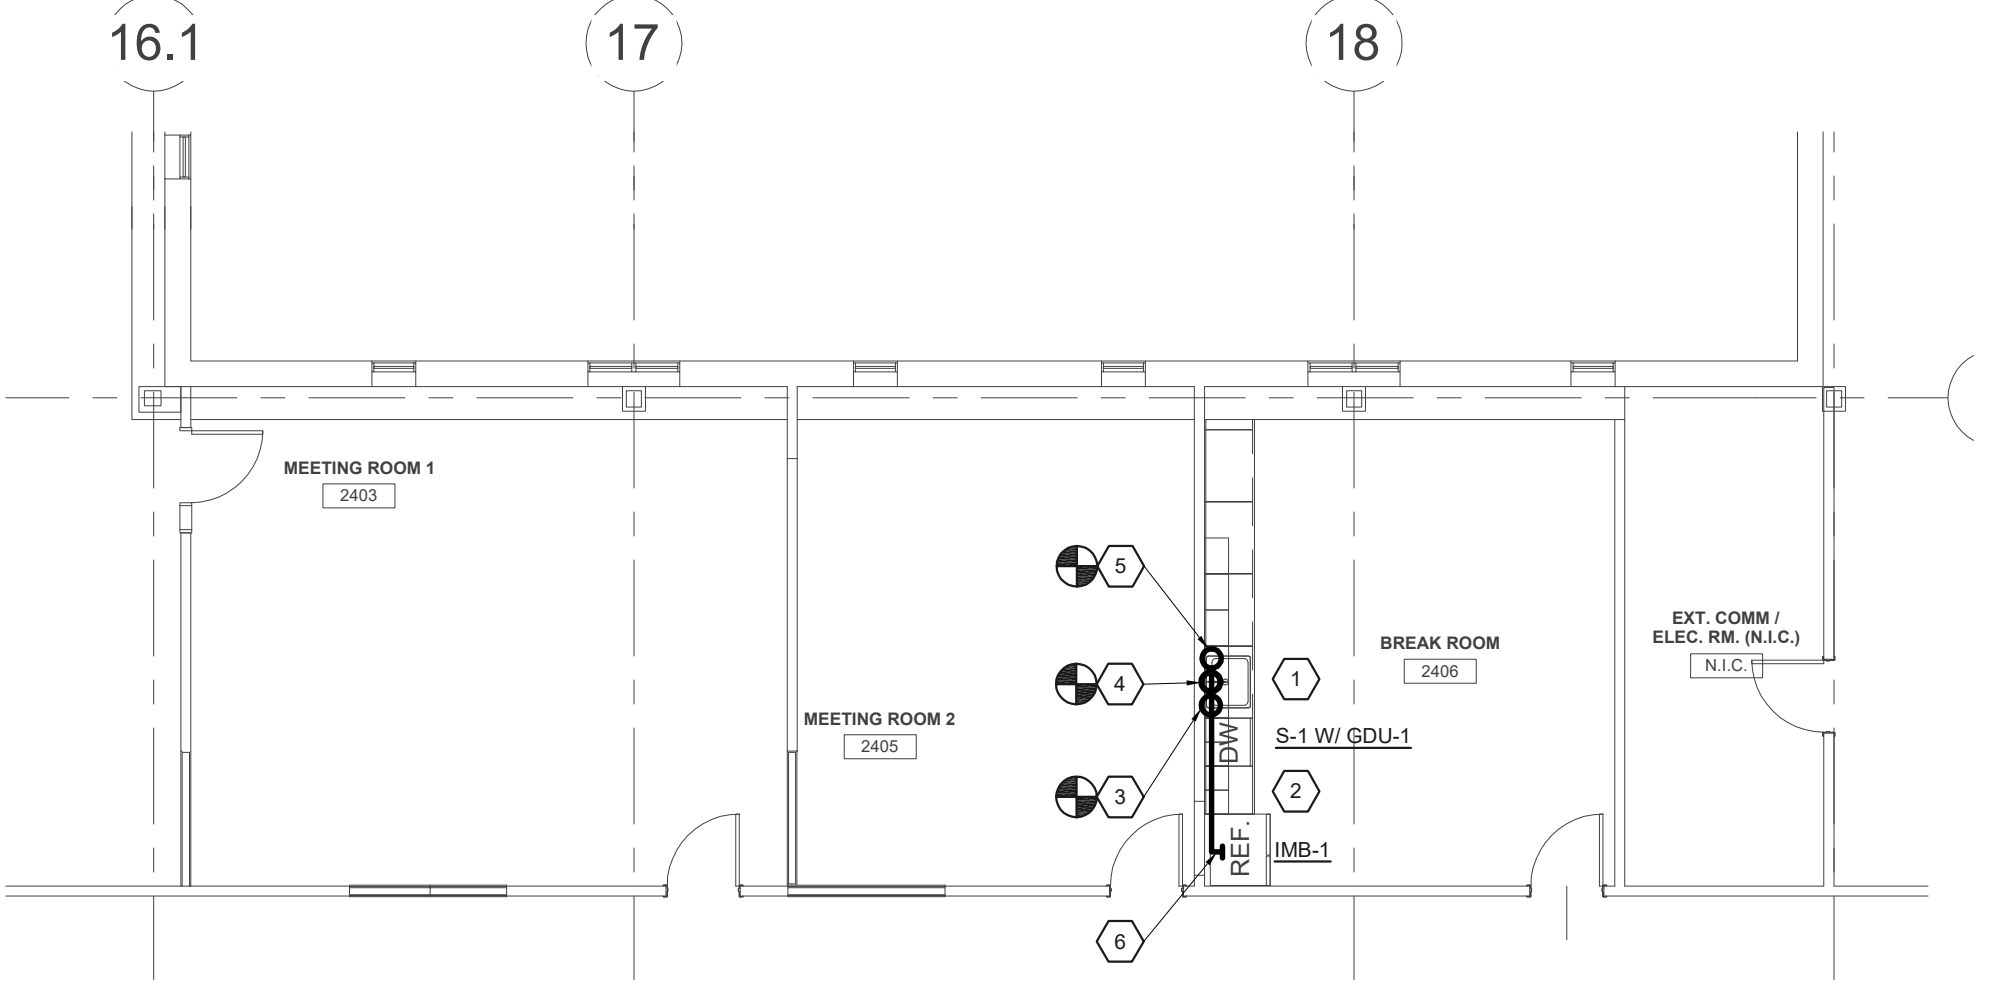

1 PLUMBING FLOOR PLAN
SCALE: 1/8" = 1'-0"

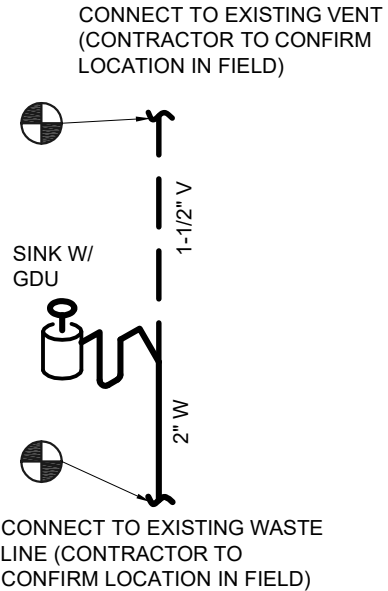

2 SINK WASTE + VENT ISOMETRIC
SCALE: NOT TO SCALE

PLUMBING FIXTURE SCHEDULE										
TAG	DESCRIPTION	MANUFACTURER	MODEL NUMBER	FINISH	MANUFACTURER	MODEL NUMBER	FINISH	GPM/GPF	ELECTRICAL	REMARKS
S-1	SINK- DOUBLE COMPARTMENT (ADA)	JUST	DL-ADA-1933-A-GR	STAINLESS STEEL (18 GA)	DELTA	100LF-HDF	CHROME	1.5	-	1,2,3,4
IMB-1	ICE MAKER BOX	SIoux CHIEF	696-G1010MF	WHITE	WATERCOP	Z-WAVE	-	-	110/1/60	5,6
GDU-1	GARBAGE DISPOSAL UNIT	INSINKERATOR	BADGER 5	-	-	-	-	-	120/60/1 1/2 HP	-

REMARKS:

- 17 GA. P-TRAP, LOOSE KEY ANGLE STOPS, STAINLESS STEEL BRAIDED SUPPLIES
- PROVIDE LEONARD #270-LF MIXING VALVE UNDER FIXTURE. (ASSE 1070 RATED)
- PROVIDE WITH TRUEBRO #103 E-Z P-TRAP AND SUPPLIES INSULATION KIT
- 6" DEEP BOWL, REAR DRAIN LOCATION
- WITH "AA" WATER HAMMER ARRESTERS
- AUOTMATIC WATER SHUT-OFF VALVE WITH WIRELESS LEAK DETECTION SENSOR

GENERAL SERVICES ADMINISTRATION

GSA

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360
Three Sixty Engineering, Inc.
609 Jackson St. Suite 300
Boulder, CO 80502
303.440.3300
877.641.6114
EIMD

CERTIFICATION

KEY PLAN

AREA OF WORK - PART 'A'

MARK	DATE	DESCRIPTION

CONTRACTOR GRAPHIC SCALE	
A/E CON. NO.	GS-08P-JB-D-0017
A/E TASK NO.	EP-GS-P-08-16-JB-7053
CONS. CONTR.	GS-08P-13-JB-D-0032
CONS. WORK	
PRIM A/E	ANDERSON HALLAS ARCHITECT PC
SUB A/E	
CONSTR. CON.	
NAME	BUILDING 56
STREET	6TH STEET
CITY/ST./ZIP	DENVER, COLORADO 80255
BUILDING NO.	BUILDING 56
OTHER BUILDING NOS	
FACILITY CODE	
PROJECT TITLE	BUILDING 56 - NRCS
PROJECT DESCRIPTION	BUILDING 56 - 2ND FLOOR NRCS CONSOLIDATION
PROJECT NO.	EP-GS-P-08-16-JB-7053
GSA PM	BEN REKO
SUBMISSION	100% CONSTRUCTIONS DOCUMENTS
SUB. DATE	7/25/2019
DRAWING TITLE	PLUMBING FLOOR PLAN
FILE NAME	
FLOOR NO.	2ND FLOOR
DRAWN BY	JSW DATE DRAFTED: 12/04/2017
CHECKED BY	TCM/DMD SHEET SIZE: 22X34
DRAWING NO.	P 1
DISCIPLINE	SHEET TYPE SEQUENCE
SHEET	21 OF 50


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GENERAL NOTES

A	FOR POWER DEVICES TO BE REMOVED, REMOVE ALL ASSOCIATED RACEWAYS AND CONDUCTORS COMPLETELY BACK TO SOURCE. MARK ASSOCIATED BREAKER AND DIRECTORY AS "SPARE" FOR THE UNUSED CIRCUIT.
B	FOR IT OUTLETS TO BE REMOVED, REMOVE ALL ASSOCIATED RACEWAYS AND CABLING COMPLETELY BACK TO THE IT RACK. REMOVE ANY ASSOCIATED PATCH PANEL PORT LABELING.

KEYNOTE LEGEND

KEY VALUE	KEYNOTE TEXT
1	REMOVE WALL-MOUNTED IT CABINET AND ASSOCIATED FIBER-OPTIC BACKBONE CABLING BACK TO SOURCE (MDF). RELOCATE ALL RACK COMPONENTS TO NEW IT RACK LOCATION. COORDINATE ALL WORK WITH NRCS IT STAFF PRIOR TO COMMENCING WORK.
2	ALL POWER AND DATA CONNECTIONS ON THE INSIDE OF THE RECEPTION DESK (NOT SHOWN) TO BE REMOVED.

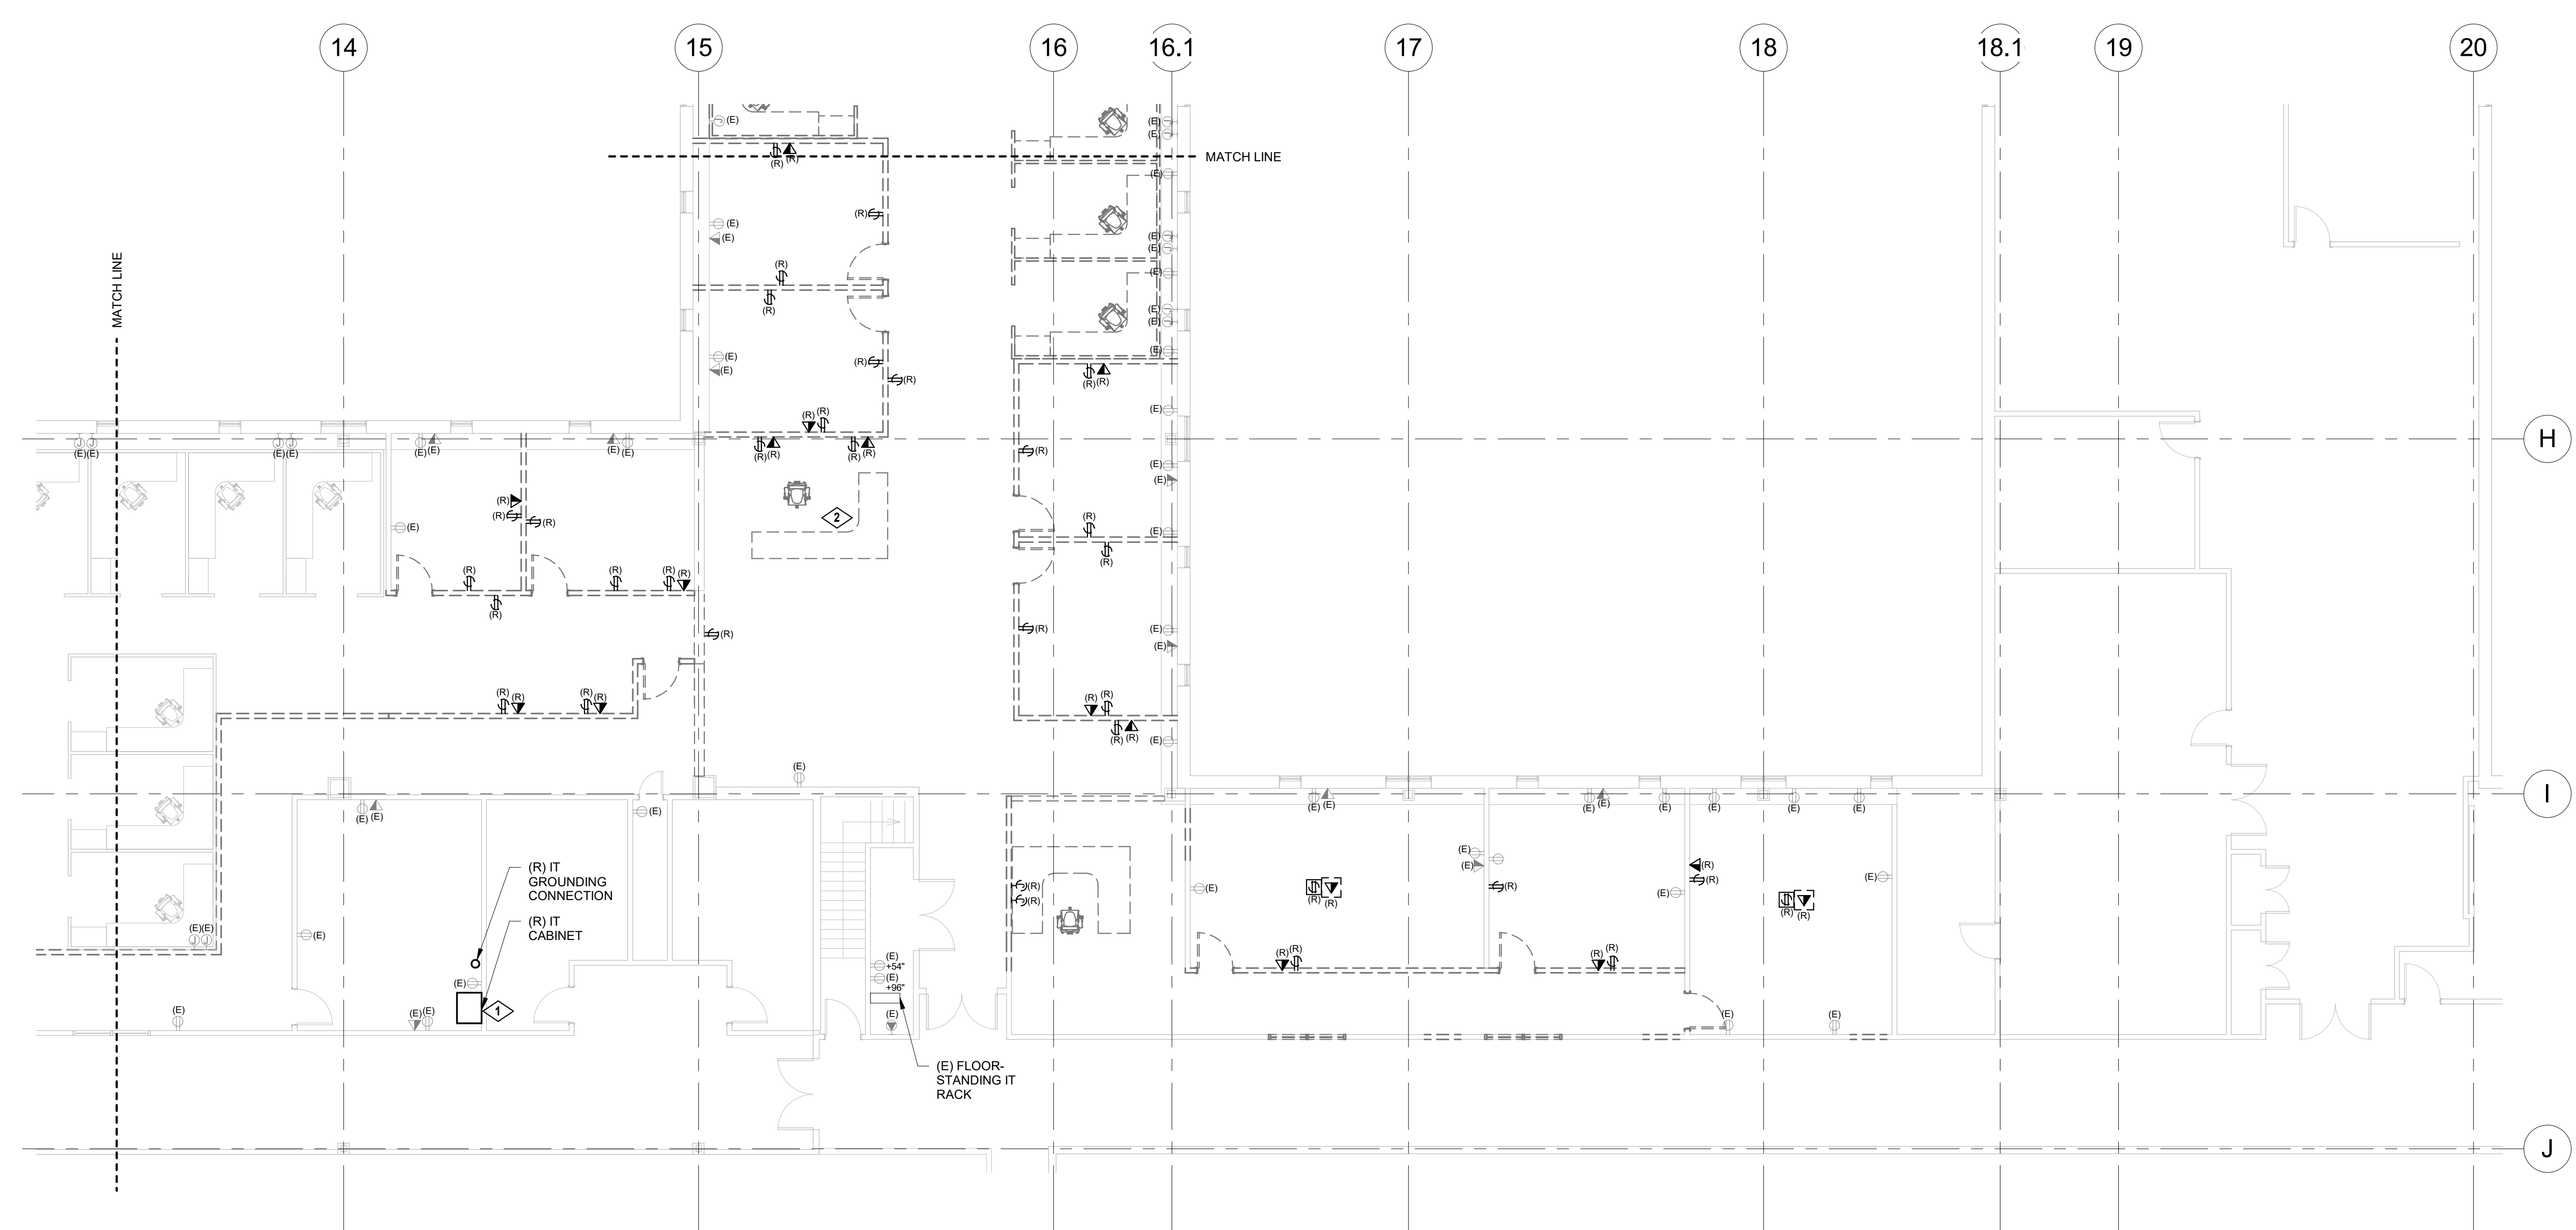

ELECTRICAL DEMO POWER PLAN - AREA A
1/8" = 1'-0"

CERTIFICATION

KEY PLAN

2nd FLOOR KEY PLAN

MARK	DATE	DESCRIPTION

REVISION NOTES

GRAPHIC SCALE

A/E CON. NO.	GS-08P-JB-D-0017
A/E TASK NO.	EP-GS-P-08-16-JB-7053
CONS. CONTR.	GS-08P-13-JB-D-0032
CONS. WORK	
PRIM A/E	ANDERSON HALLAS ARCHITECT PC
SUB A/E	
CONSTR. CON.	
NAME	BUILDING 56
STREET	6TH STREET
CITY/ST./ZIP	DENVER, COLORADO 80255
BUILDING NO.	BUILDING 56
OTHER BUILDING NOS	
FACILITY CODE	
PROJECT TITLE	BUILDING 56 - NRCS
PROJECT DESCRIPTION	BUILDING 56 - 2ND FLOOR NRCS CONSOLIDATION
PROJECT NO.	EP-GS-P-08-16-JB-7053
GSA PM	BEN REKO
SUBMISSION SUB. DATE	100% CONSTRUCTION DOCUMENTS 7/25/2019
DRAWING TITLE	ELECTRICAL DEMO POWER PLAN - AREA A
FILE NAME	
FLOOR NO.	
DRAWN BY	DATE DRAFTED:
CHECKED BY	SHEET SIZE: 22X34
DRAWING NO.	ED 2 01
DISCIPLINE	SHEET TYPE SEQUENCE
	SHEET 24 OF 50



GENERAL SERVICES
ADMINISTRATION


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303.236.0855 Phone | 720.412.2812 Cell
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Principal: Dave Anderson
AIA, LEED AP
daveanderson@andarch.com

GENERAL NOTES


A	FOR POWER DEVICES TO BE REMOVED, REMOVE ALL ASSOCIATED RACEWAYS AND CONDUCTORS COMPLETELY BACK TO SOURCE. MARK ASSOCIATED BREAKER AND DIRECTORY AS "SPARE" FOR THE UNUSED CIRCUIT.
B	FOR IT OUTLETS TO BE REMOVED, REMOVE ALL ASSOCIATED RACEWAYS AND CABLING COMPLETELY BACK TO THE IT RACK. REMOVE ANY ASSOCIATED PATCH PANEL PORT LABELING.




NORTH 1
ELECTRICAL DEMO POWER PLAN - AREA B
1/8" = 1'-0"

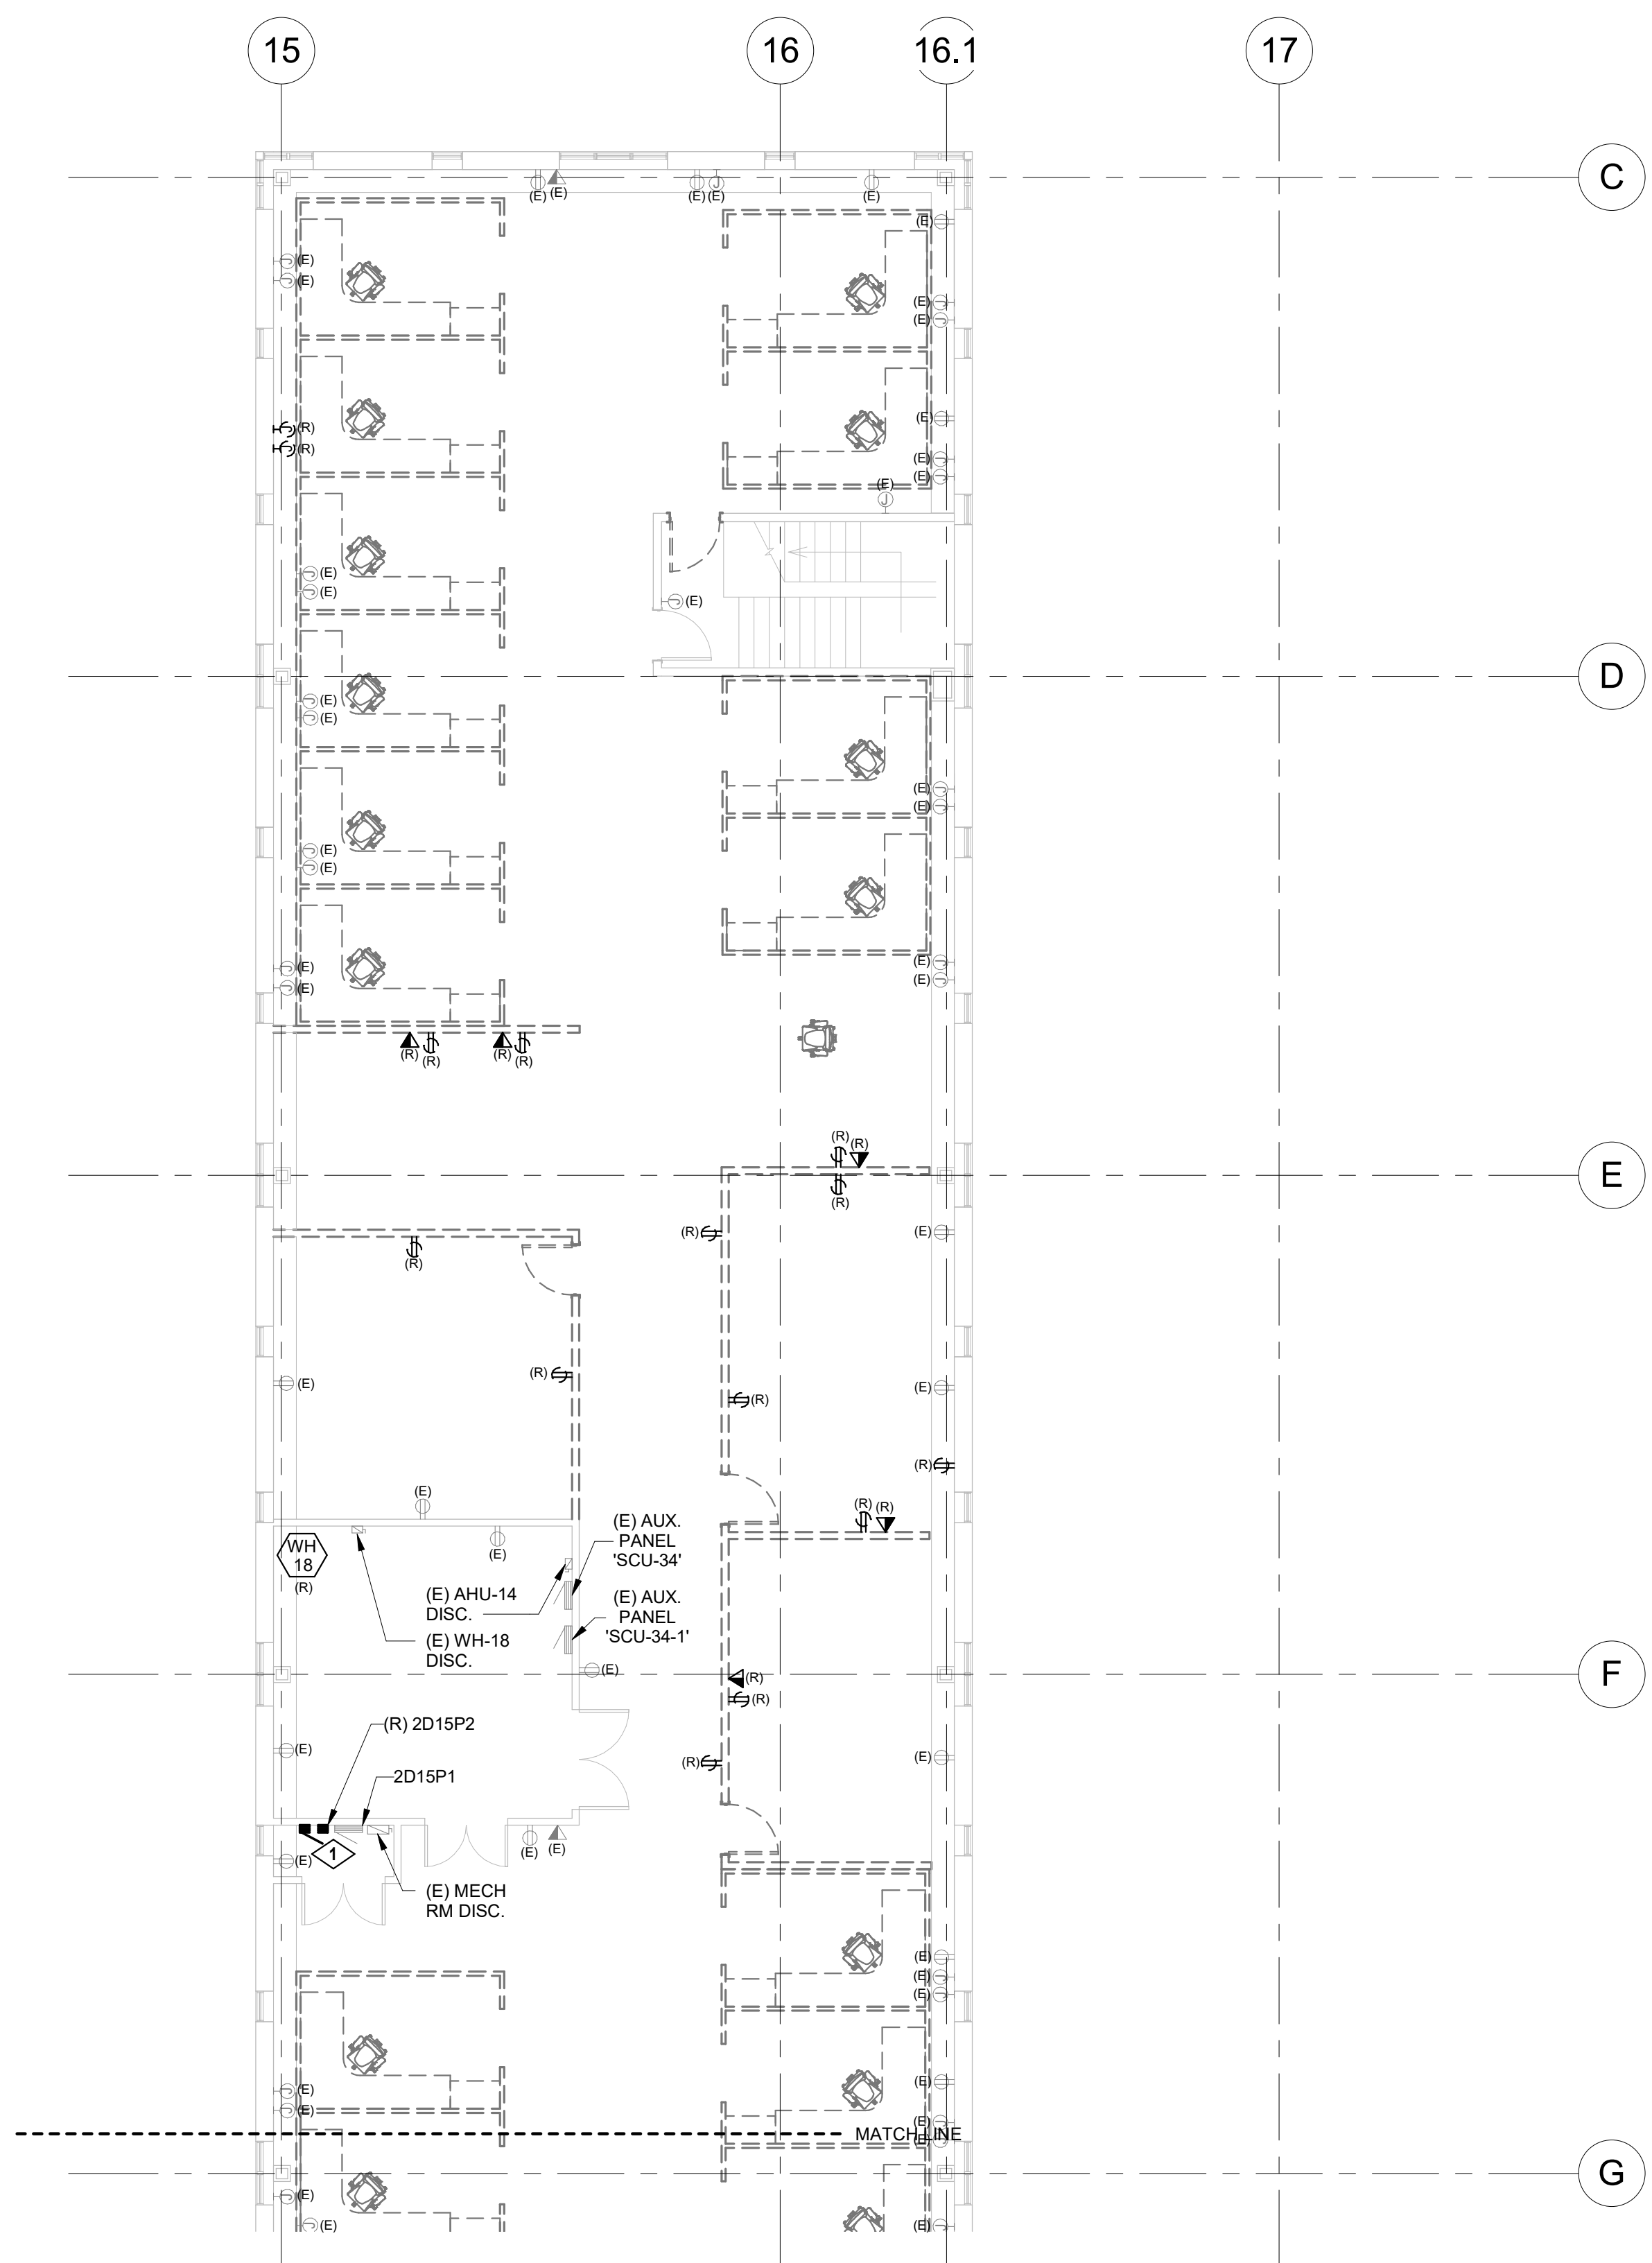8/8/2019 8:25:35 AM

CERTIFICATION

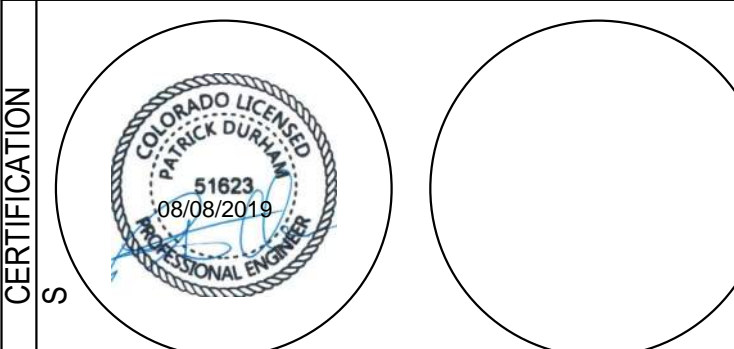

KEY PLAN

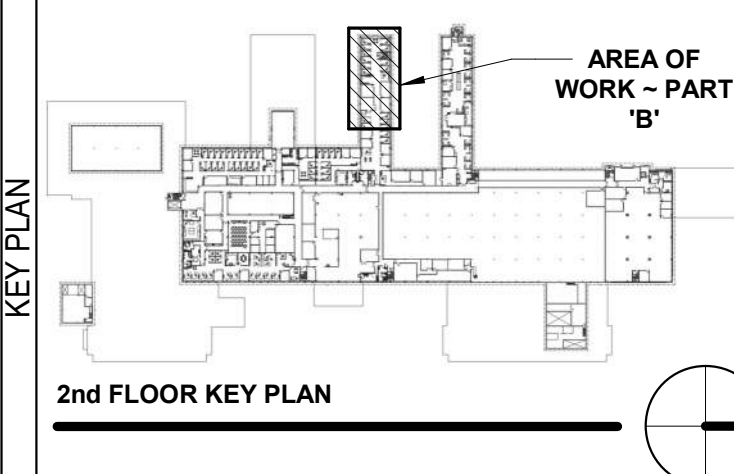

REVISION NOTES

MARK	DATE	DESCRIPTION

GRAPHIC SCALE

CONTRACTORS

A/E CON. NO.	GS-08P-JB-D-0017
A/E TASK NO.	EP-GS-P-08-16-JB-7053
CONS. CONTR.	GS-08P-13-JB-D-0032
CONS. WORK	
PRIM A/E	ANDERSON HALLAS ARCHITECT PC
SUB A/E	
CONSTR. CON.	

BUILDING


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STREET	6TH STREET
CITY/ST./ZIP	DENVER, COLORADO 80255
BUILDING NO.	BUILDING 56
OTHER BUILDING NOS	
FACILITY CODE	

PROJECT

PROJECT TITLE	BUILDING 56 - NRCS
PROJECT DESCRIPTION	BUILDING 56 - 2ND FLOOR NRCS CONSOLIDATION
PROJECT NO.	EP-GS-P-08-16-JB-7053
GSA PM	BEN REKO
SUBMISSION	100% CONSTRUCTION DOCUMENTS
SUB. DATE	7/25/2019
DRAWING TITLE	ELECTRICAL DEMO POWER PLAN - AREA B

DRAWING

FILE NAME	
FLOOR NO.	
DRAWN BY	DATE DRAFTED:
CHECKED BY	SHEET SIZE: 22X34
DRAWING NO.	ED 2 02
DISCIPLINE	SHEET TYPE SEQUENCE
	SHEET 25 OF 50

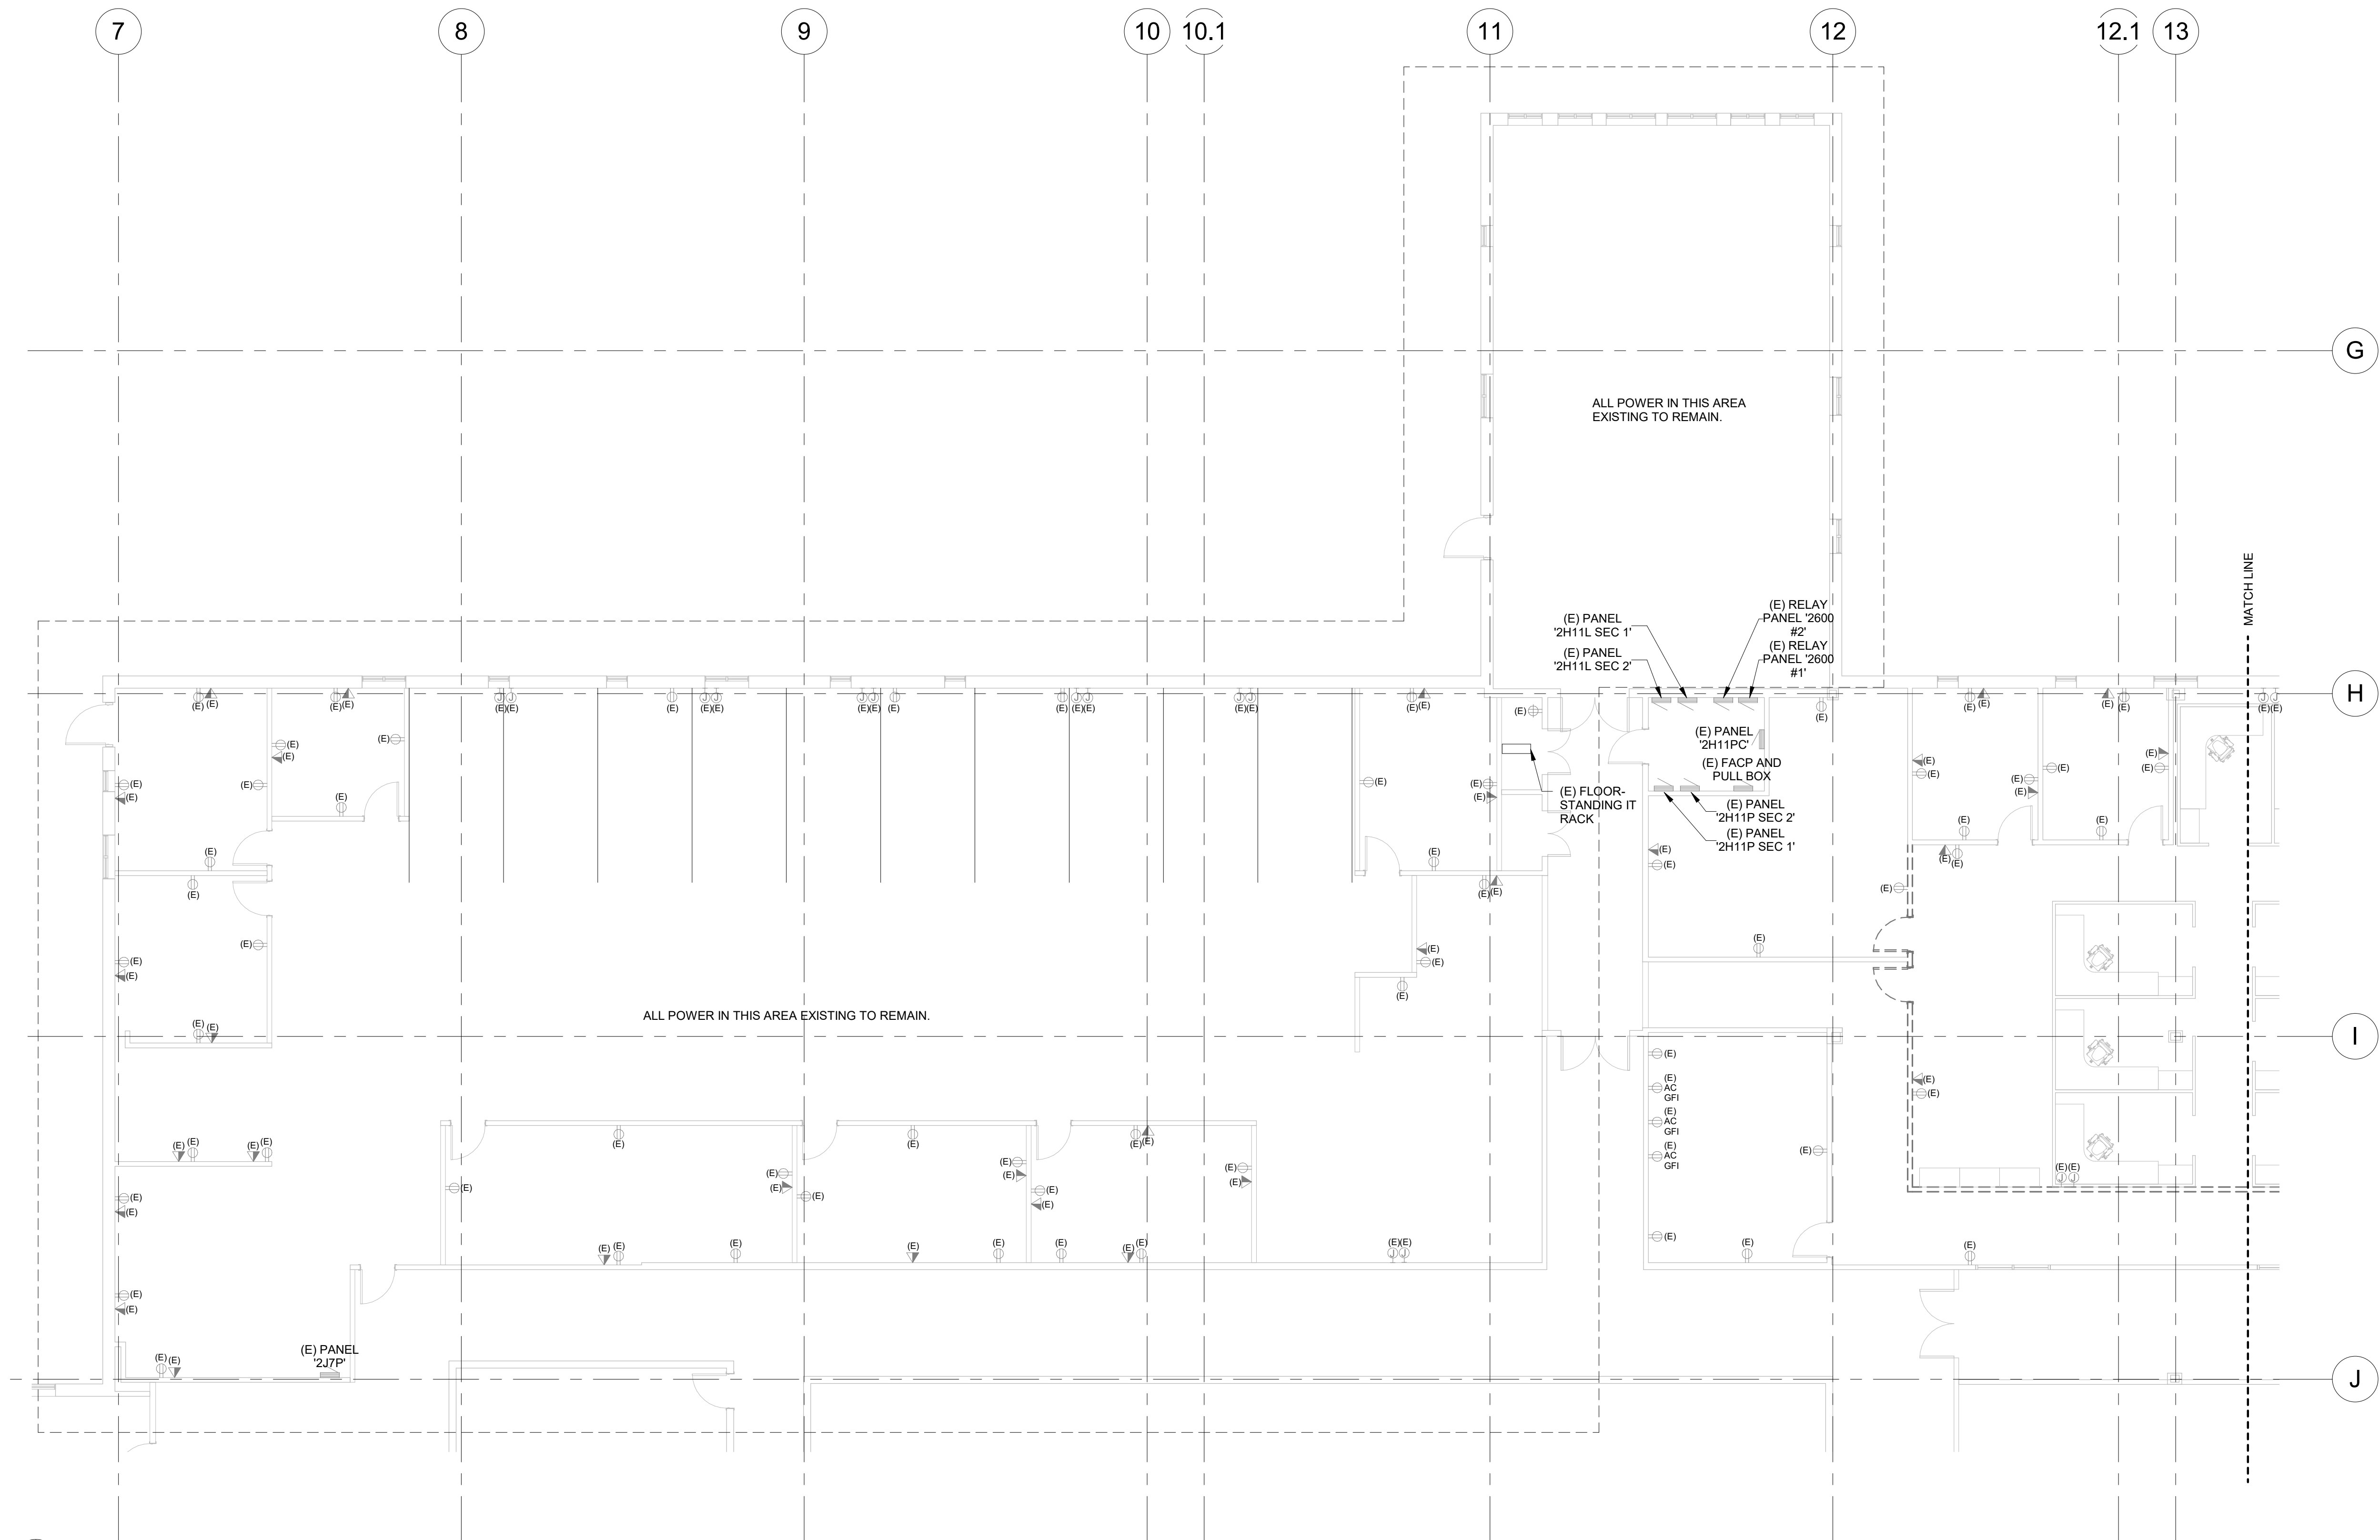

GENERAL NOTES	
A	FOR POWER DEVICES TO BE REMOVED, REMOVE ALL ASSOCIATED RACEWAYS AND CONDUCTORS COMPLETELY BACK TO SOURCE. MARK ASSOCIATED BREAKER AND DIRECTORY AS "SPARE" FOR THE UNUSED CIRCUIT.
B	FOR IT OUTLETS TO BE REMOVED, REMOVE ALL ASSOCIATED RACEWAYS AND CABLING COMPLETELY BACK TO THE IT RACK. REMOVE ANY ASSOCIATED PATCH PANEL PORT LABELING.

GENERAL SERVICES ADMINISTRATION

GSA

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CERTIFICATION

KEY PLAN

2nd FLOOR KEY PLAN

MARK	DATE	DESCRIPTION

REVISION NOTES	

GRAPHIC SCALE	

CONTRACTORS	
A/E CON. NO.	GS-08P-JB-D-0017
A/E TASK NO.	EP-GS-P-08-16-JB-7053
CONS. CONTR.	GS-08P-13-JB-D-0032
CONS. WORK	
PRIM A/E	ANDERSON HALLAS ARCHITECT PC
SUB A/E	
CONSTR. CON.	
NAME	BUILDING 56
STREET	6TH STREET
CITY/ST./ZIP	DENVER, COLORADO 80255
BUILDING NO.	BUILDING 56
OTHER BUILDING NOS	
FACILITY CODE	
PROJECT	
TITLE	BUILDING 56 - NRCS
DESCRIPTION	BUILDING 56 - 2ND FLOOR NRCS CONSOLIDATION
PROJECT NO.	EP-GS-P-08-16-JB-7053
GSA PM	BEN REKO
SUBMISSION	100% CONSTRUCTION DOCUMENTS
SUB. DATE	7/25/2019
DRAWING TITLE	ELECTRICAL DEMO POWER PLAN - AREA C
FILE NAME	
FLOOR NO.	
DRAWN BY	
CHECKED BY	
DATE DRAFTED:	
SHEET SIZE:	22X34
DRAWING NO.	ED 2 03
DISCIPLINE	
SHEET TYPE	
SEQUENCE	
SHEET	26
OF	50

NORTH
ELECTRICAL DEMO POWER PLAN - AREA C
1/8" = 1'-0"

GENERAL NOTES

A LIGHTING ADD/ALTERNATE: REPLACE ALL LAY-IN 2' X 4' FIXTURES INDICATED AS EITHER "(E)" OR "(ER)" ON LIGHTING DEMOLITION DRAWINGS, WITH NEW LED LAY-IN 2' X 4' FIXTURES. REFER TO NEW LIGHTING PLANS FOR LAYOUTS.





GENERAL SERVICES ADMINISTRATION

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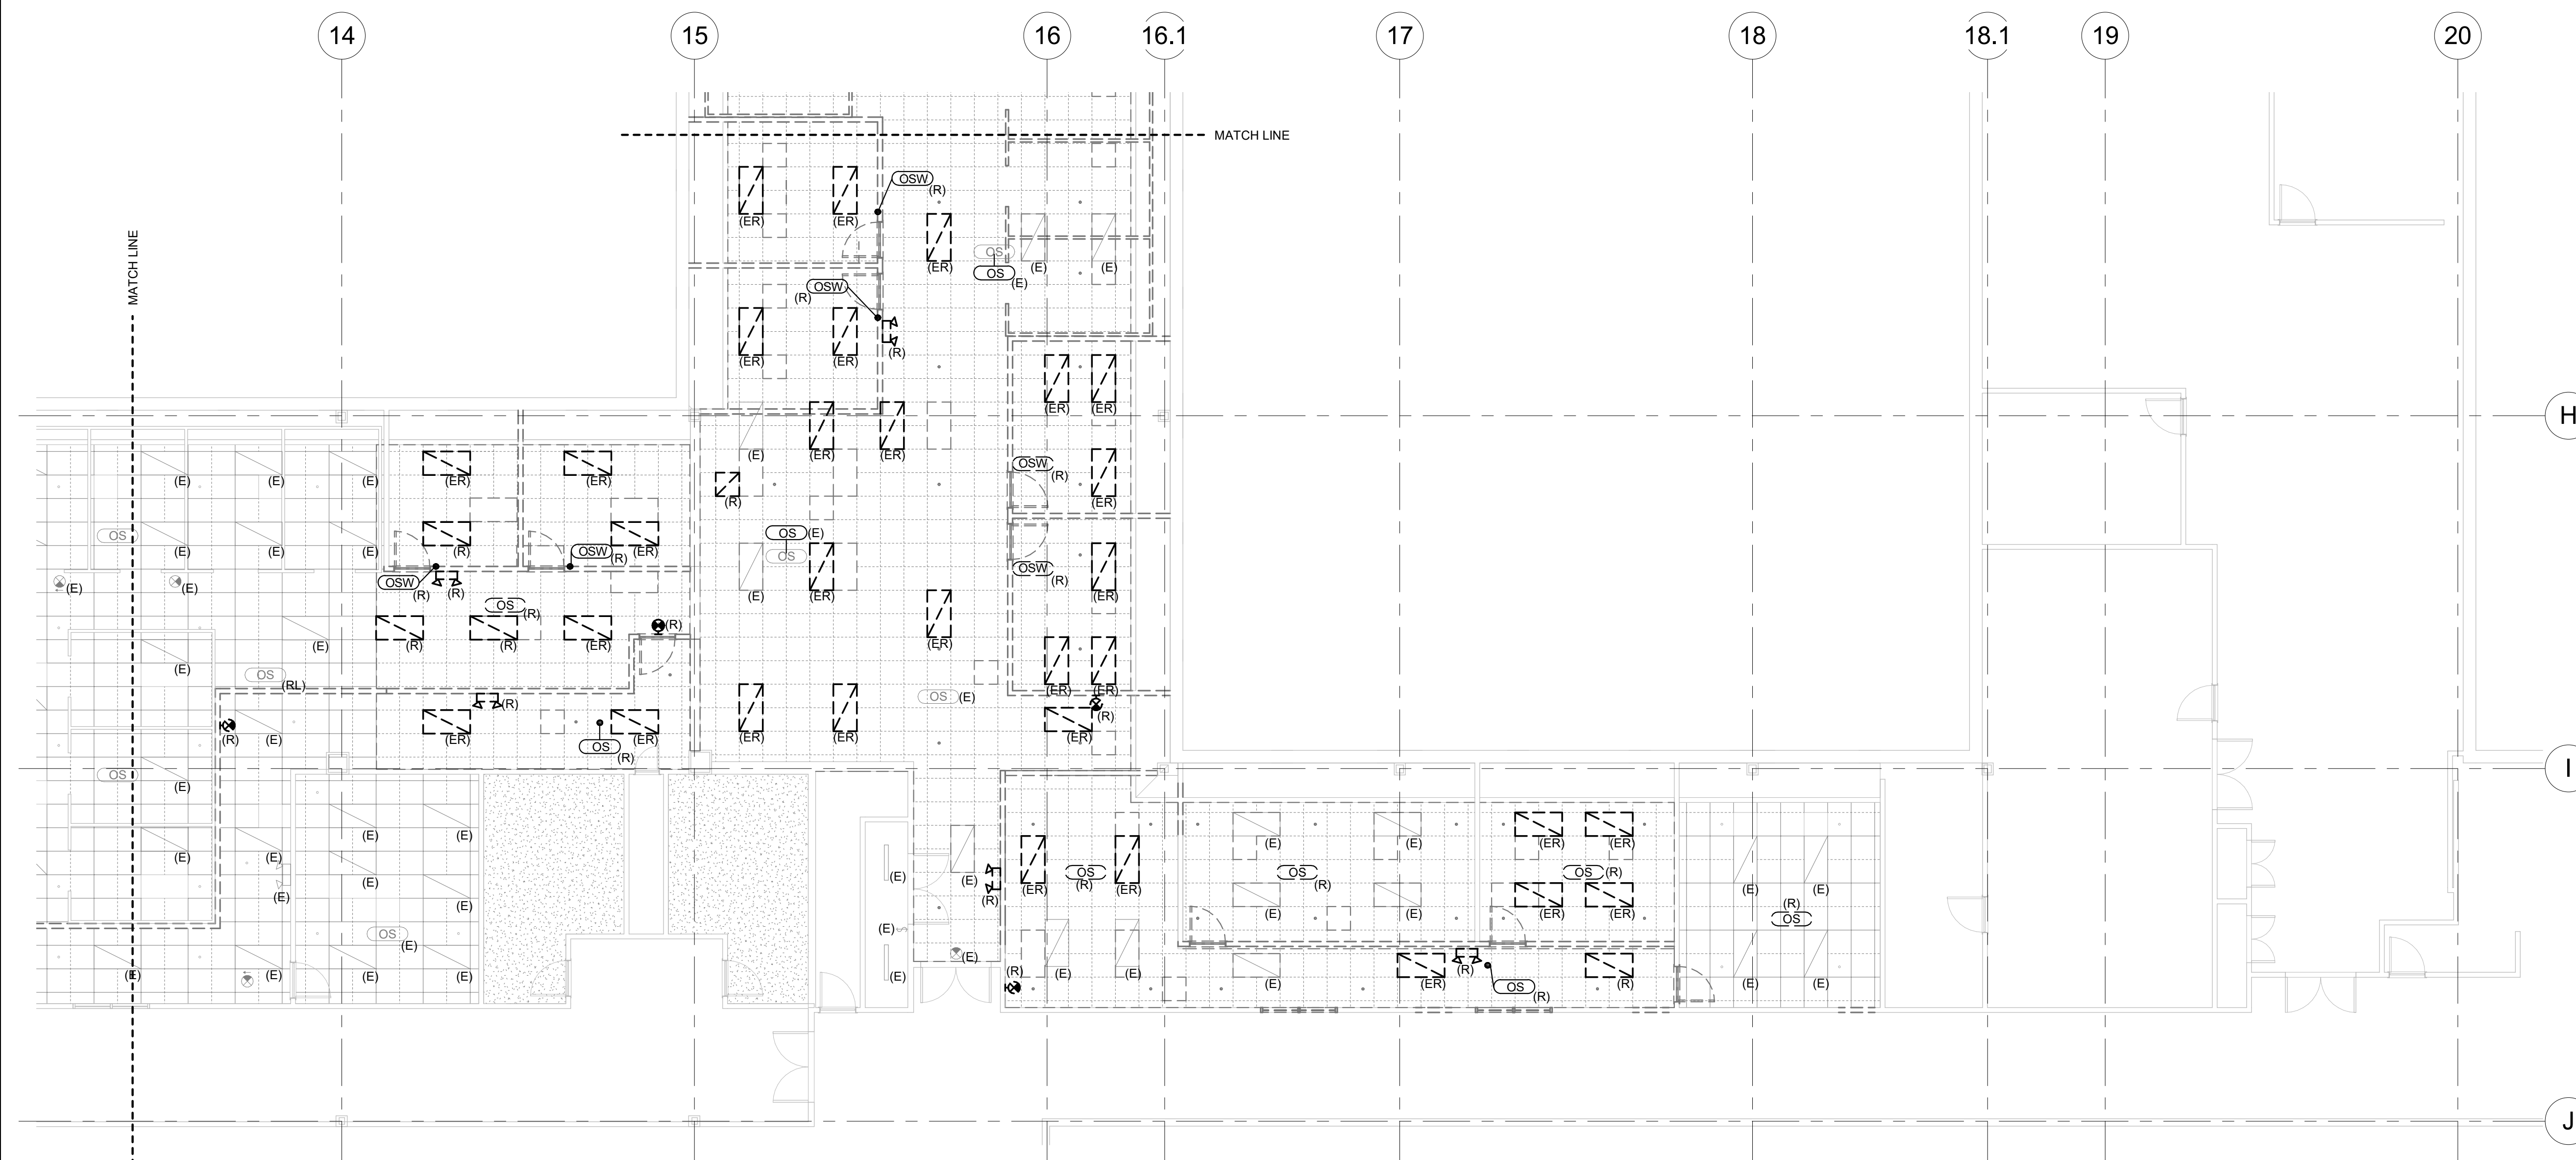


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Principal: Dave Anderson
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daveanderson@andarch.com

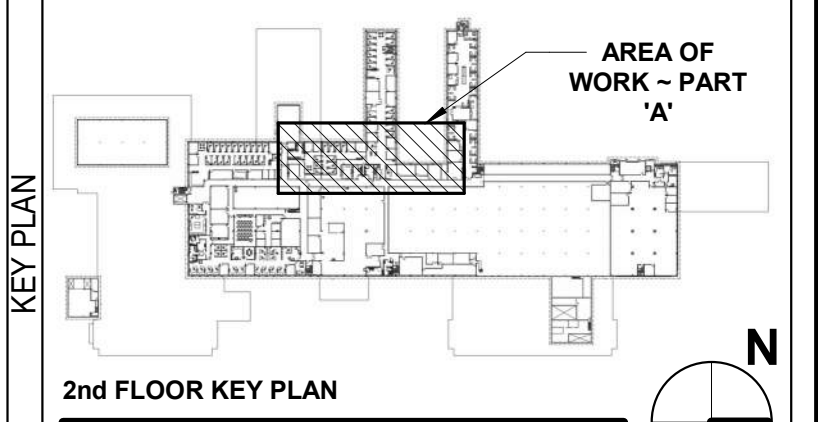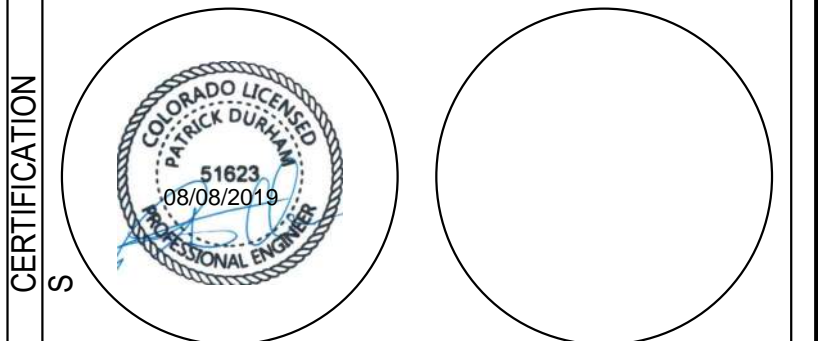

MARK	DATE	DESCRIPTION

CONTRACTORS	
A/E CON. NO.	GS-08P-JB-D-0017
A/E TASK NO.	EP-GS-P-08-16-JB-7053
CONS. CONTR.	GS-08P-13-JB-D-0032
CONS. WORK	
PRIM A/E	ANDERSON HALLAS ARCHITECT PC
SUB A/E	
CONSTR. CON.	
BUILDING	
NAME	BUILDING 56
STREET	6TH STREET
CITY/ST./ZIP	DENVER, COLORADO 80255
BUILDING NO.	BUILDING 56
OTHER BUILDING NOS	
FACILITY CODE	
PROJECT	
PROJECT TITLE	BUILDING 56 - NRCS
PROJECT DESCRIPTION	BUILDING 56 - 2ND FLOOR NRCS CONSOLIDATION
PROJECT NO.	EP-GS-P-08-16-JB-7053
GSA PM	BEN REKO
SUBMISSION	100% CONSTRUCTION DOCUMENTS
SUB. DATE	7/25/2019
DRAWING TITLE	ELECTRICAL DEMO LIGHTING PLAN - AREA A
FILE NAME	
FLOOR NO.	
DRAWN BY	DATE DRAFTED:
CHECKED BY	SHEET SIZE: 22X34
DRAWING NO.	ED 3 01
DISCIPLINE	SHEET TYPE SEQUENCE
SHEET 27	OF 50




ELECTRICAL DEMO LIGHTING PLAN - AREA A
1/8" = 1'-0"

8/8/2019 8:25:36 AM

GENERAL NOTES

A LIGHTING ADD/ALTERNATE: REPLACE ALL LAY-IN 2' X 4' FIXTURES INDICATED AS EITHER "(E)" OR "(ER)" ON LIGHTING DEMOLITION DRAWINGS, WITH NEW LED LAY-IN 2' X 4' FIXTURES. REFER TO NEW LIGHTING PLANS FOR LAYOUTS.

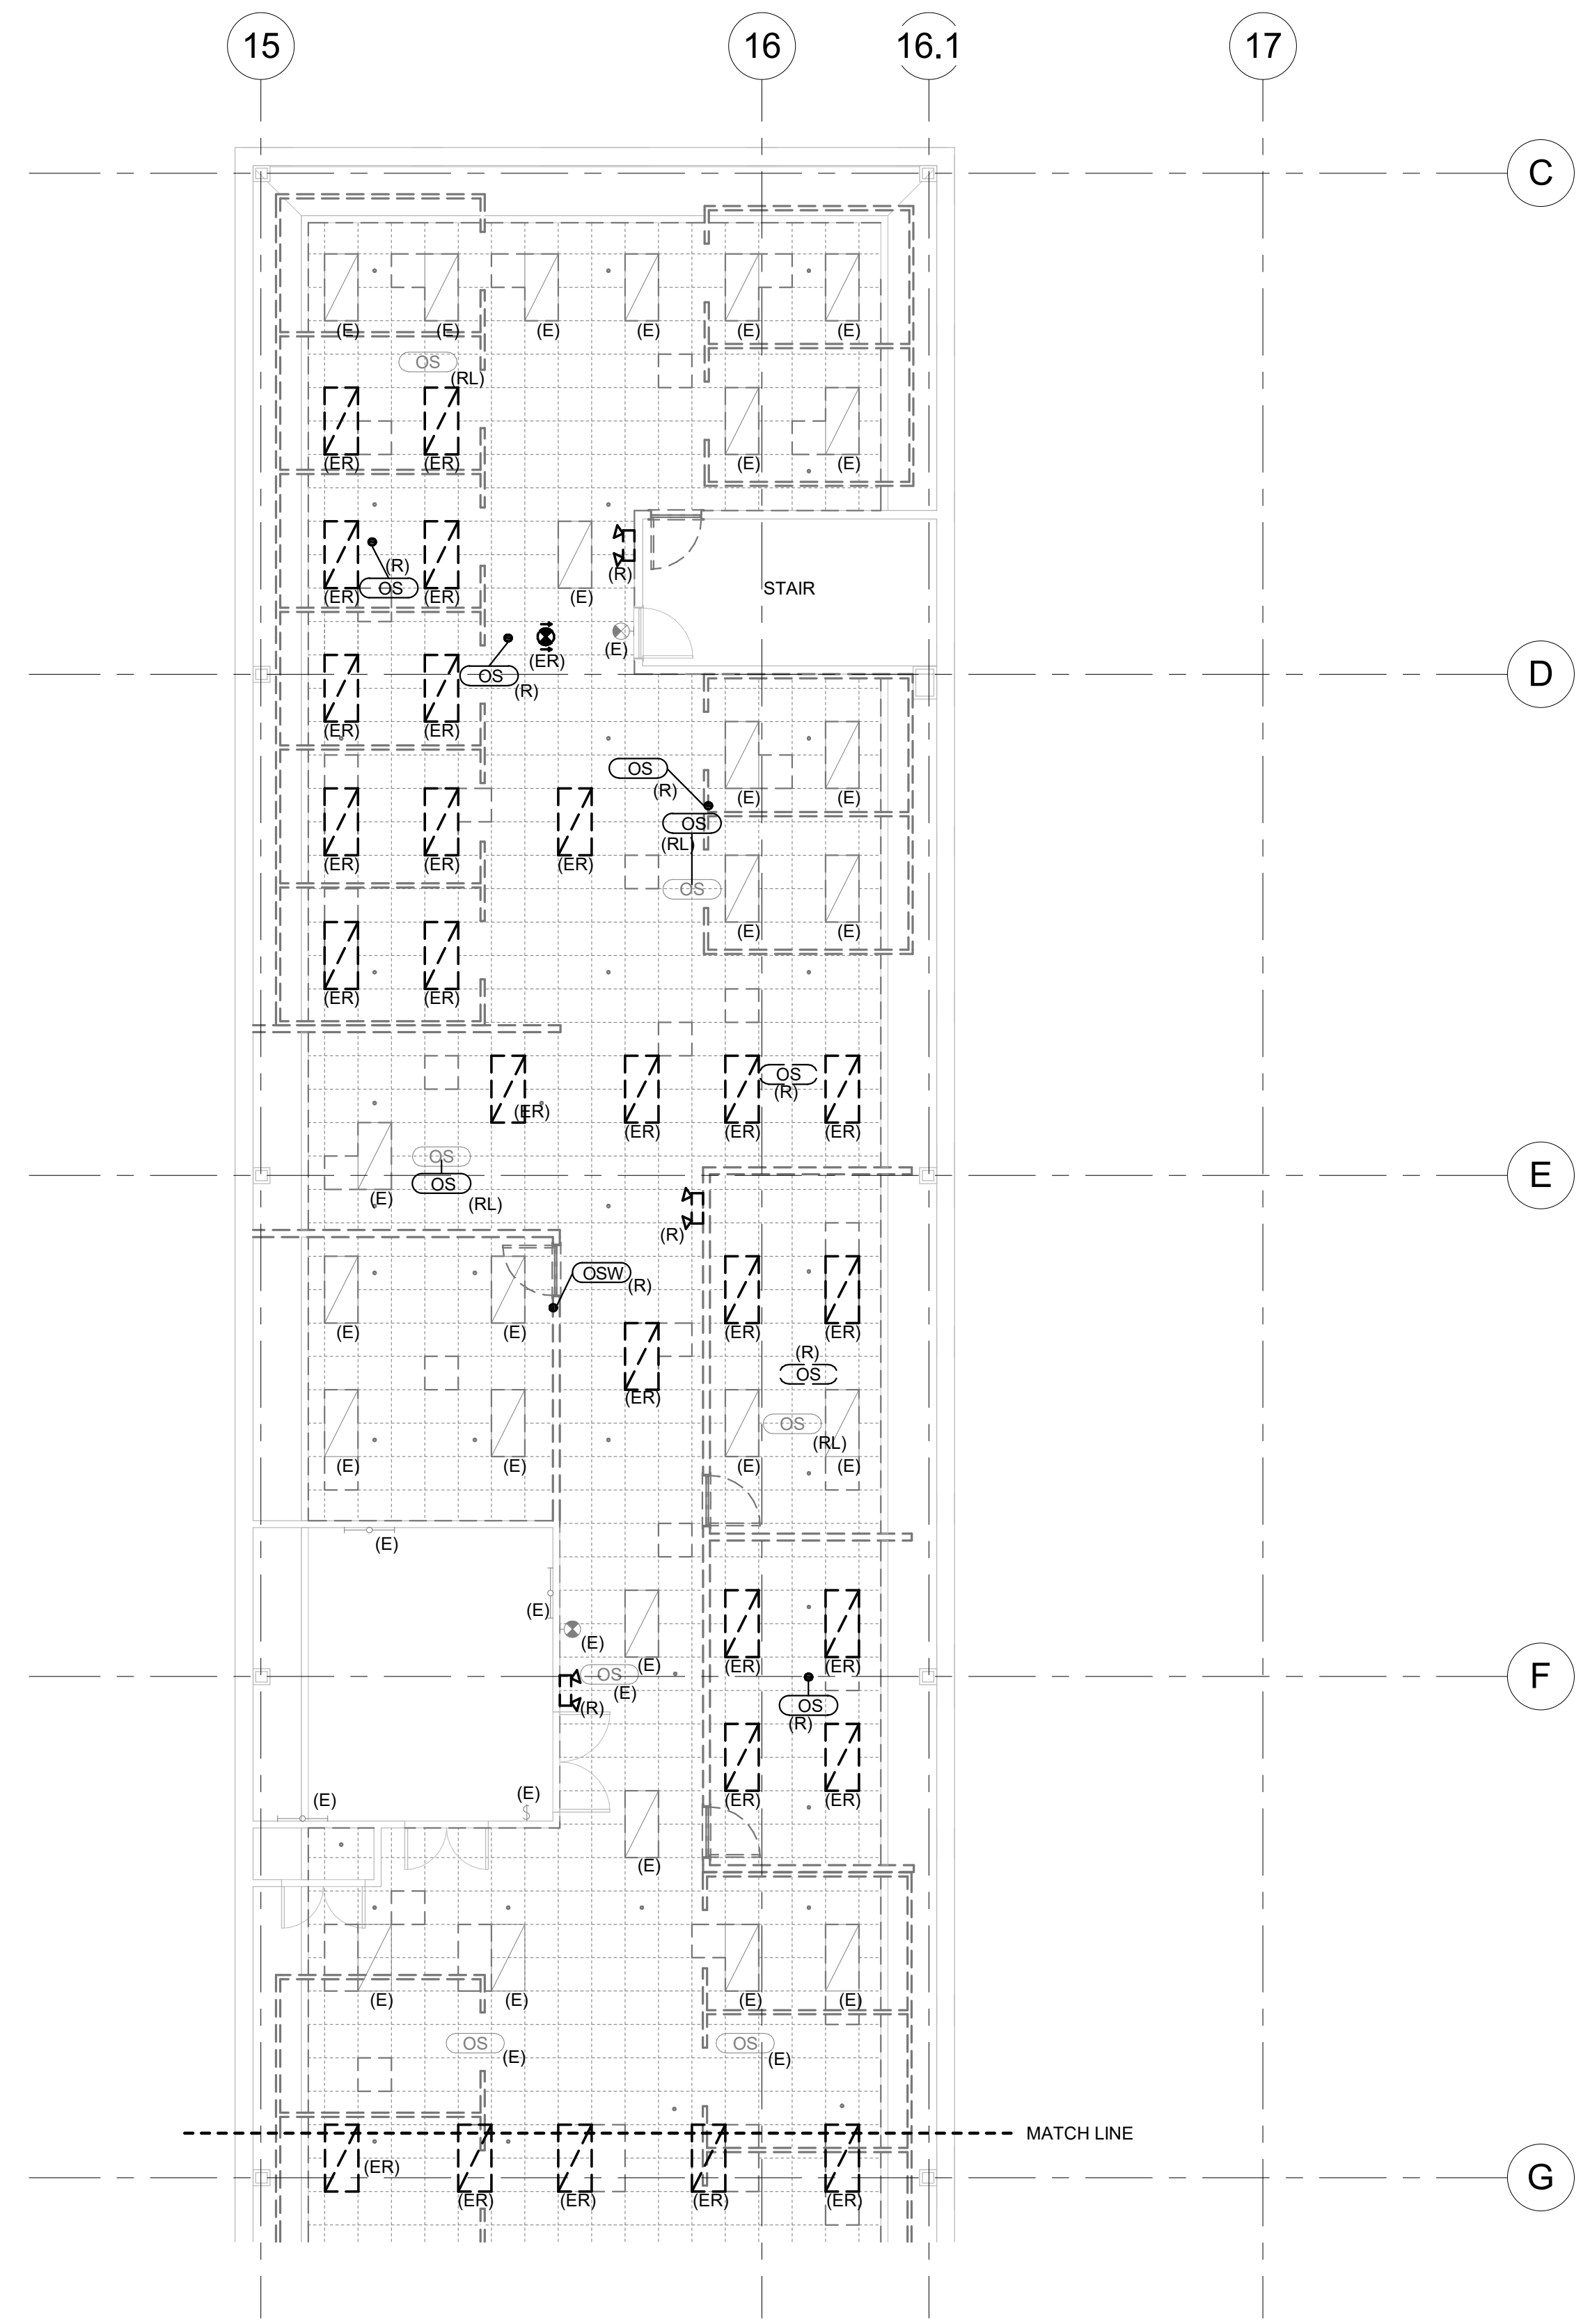

NORTH ① ELECTRICAL DEMO LIGHTING PLAN - AREA B
 1/8" = 1'-0"

GENERAL SERVICES
 ADMINISTRATION

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 Project Manager
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CERTIFICATION

COLORADO LICENSE
 PATRICK DUMAS
 51623
 08/09/2019
 PERSONAL ENGINEER

KEY PLAN

2nd FLOOR KEY PLAN

N

MARK	DATE	DESCRIPTION

REVISION NOTES

CONTRACTORS

A/E CON. NO.	GS-08P-JB-D-0017
A/E TASK NO.	EP-GS-P-08-16-JB-7053
CONS. CONTR.	GS-08P-13-JB-D-0032
CONS. WORK	
PRIM A/E	ANDERSON HALLAS ARCHITECT PC
SUB A/E	
CONSTR. CON.	

BUILDING

NAME	BUILDING 56
STREET	6TH STREET
CITY/ST./ZIP	DENVER, COLORADO 80255
BUILDING NO.	BUILDING 56
OTHER BUILDING NOS	
FACILITY CODE	

PROJECT

PROJECT TITLE	BUILDING 56 - NRCS
PROJECT DESCRIPTION	BUILDING 56 - 2ND FLOOR NRCS CONSOLIDATION
PROJECT NO.	EP-GS-P-08-16-JB-7053
GSA PM	BEN REKO
SUBMISSION	100% CONSTRUCTION DOCUMENTS
SUB. DATE	7/25/2019
DRAWING TITLE	ELECTRICAL DEMO LIGHTING PLAN - AREA B
FILE NAME	
FLOOR NO.	
DRAWN BY	DATE DRAFTED:
CHECKED BY	SHEET SIZE: 22X34


DRAWING

DRAWING NO.	ED 3 02
DISCIPLINE	SHEET TYPE
SHEET 28	OF 50

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
GENERAL NOTES

A LIGHTING ADD/ALTERNATE: REPLACE ALL LAY-IN 2' X 4' FIXTURES INDICATED AS EITHER "(E)" OR "(ER)" ON LIGHTING DEMOLITION DRAWINGS, WITH NEW LED LAY-IN 2' X 4' FIXTURES. REFER TO NEW LIGHTING PLANS FOR LAYOUTS.




GENERAL SERVICES
ADMINISTRATION

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Project Manager
D.F.C. BUILDING 41 - SUITE 246
DENVER, COLORADO - 80255
303.236.0855 Phone 720.412.2812 Cell
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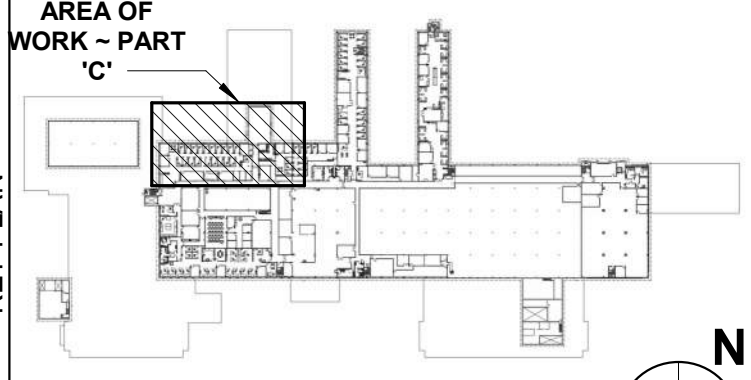
ANDERSON HALLAS
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Principal: Dave Anderson
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CERTIFICATION




KEY PLAN

AREA OF
WORK - PART
'C'




2nd FLOOR KEY PLAN

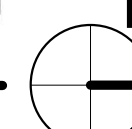

MARK	DATE	DESCRIPTION

CONTRACTORS	REVISION NOTES
A/E CON. NO. GS-08P-JB-D-0017	
A/E TASK NO. EP-GS-P-08-16-JB-7053	
CONS. CONTR. GS-08P-13-JB-D-0032	
CONS. WORK	
PRIM A/E ANDERSON HALLAS ARCHITECT PC	
SUB A/E	
CONSTR. CON.	
NAME BUILDING 56	
STREET 6TH STREET	
CITY/ST/ZIP DENVER, COLORADO 80255	
BUILDING NO. BUILDING 56	
OTHER BUILDING NOS	
FACILITY CODE	
PROJECT TITLE BUILDING 56 - NRCS	
DESCRIPTION BUILDING 56 - 2ND FLOOR NRCS CONSOLIDATION	
PROJECT NO. EP-GS-P-08-16-JB-7053	
GSA PM BEN REKO	
SUBMISSION 100% CONSTRUCTION DOCUMENTS	
SUB. DATE 7/25/2019	
DRAWING TITLE ELECTRICAL DEMO LIGHTING PLAN - AREA C	
FILE NAME	
FLOOR NO.	
DRAWN BY DATE DRAFTED:	
CHECKED BY SHEET SIZE: 22X34	
DRAWING NO. ED 3 03	
DISCIPLINE SHEET TYPE SEQUENCE	
SHEET 29 OF 50	

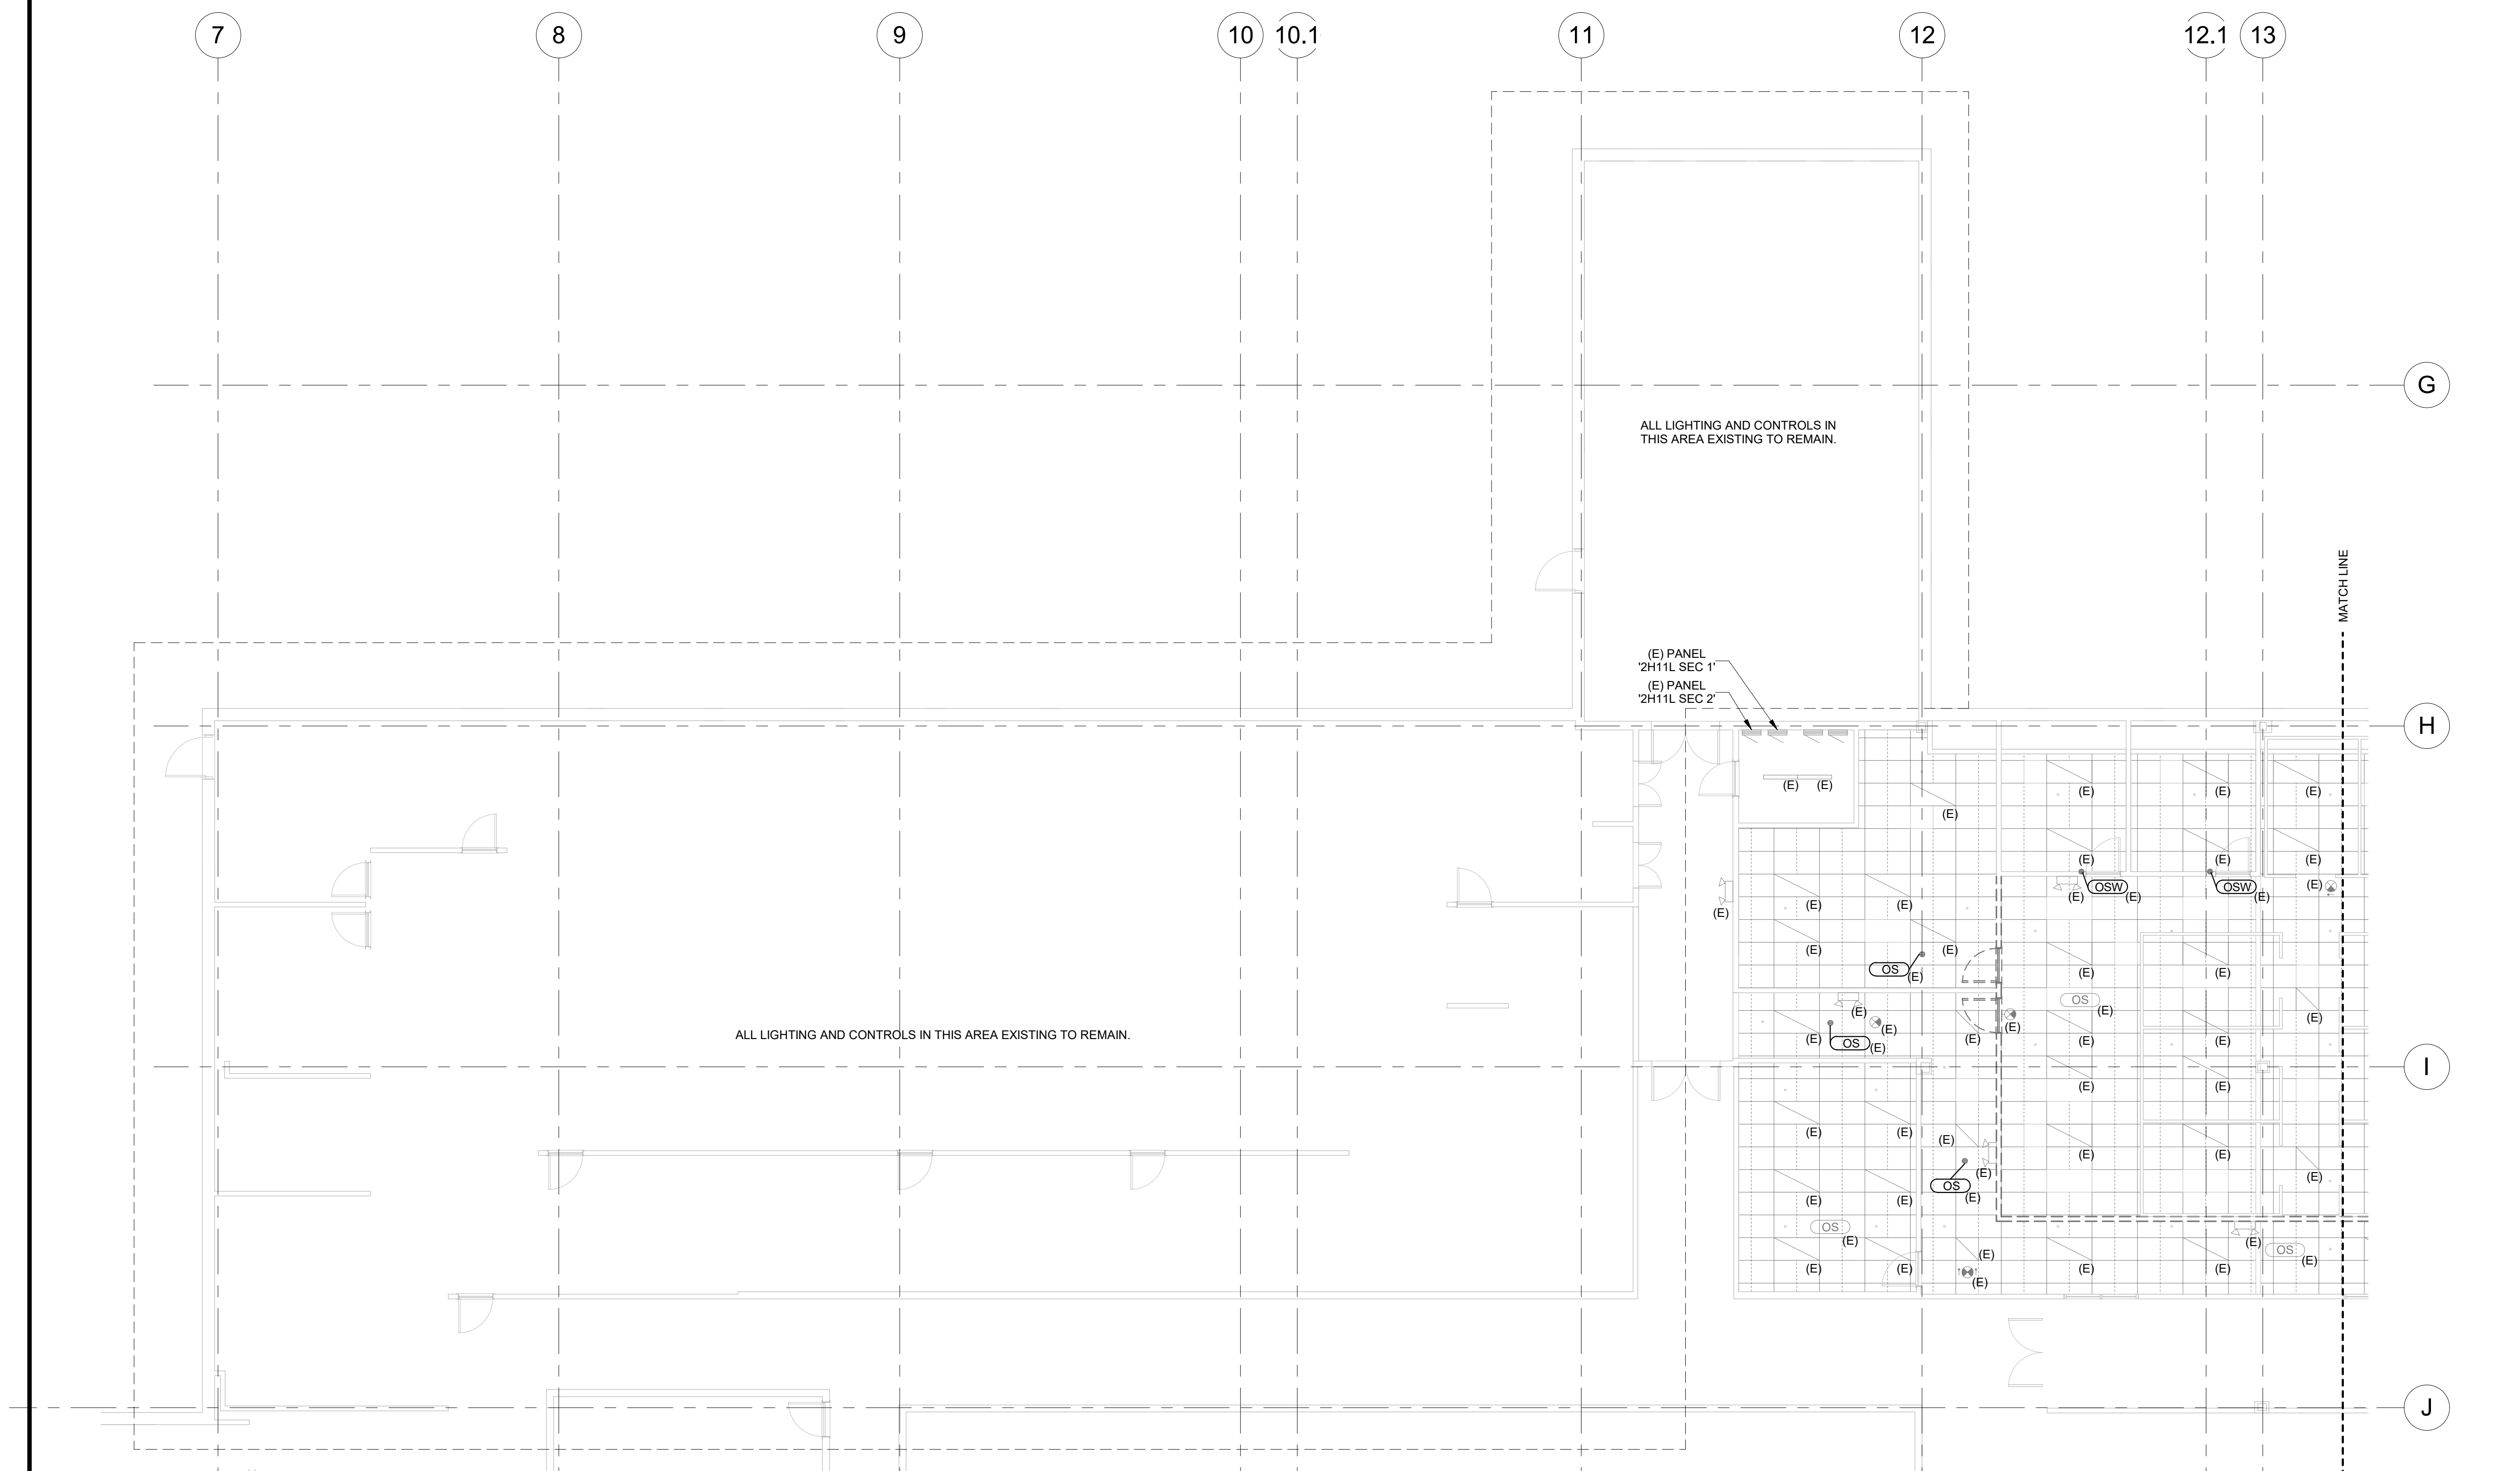

 NORTH
ELECTRICAL DEMO LIGHTING PLAN - AREA C
1/8" = 1'-0"


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KEYNOTE LEGEND

KEY VALUE	KEYNOTE TEXT
1	TOGGLE SWITCH TO BE CONNECTED TO GARBAGE DISPOSAL GFCI OUTLET LOCATED UNDER SINK.
2	EC SHALL PROVIDE FURNITURE FEED. PROVIDE 1" CONDUIT STUB-UP FOR DATA FEED. PROVIDE POWER FEED WITH (4) 120V, 20A DEDICATED CIRCUITS. EACH WITH A DEDICATED NEUTRAL. 8-WIRE FEED CONSISTING OF 8#12 + 1#12 IN 1" C.
3	EC TO PROVIDE (1) 1" AND (1) 1-1/4" EMT CONDUIT SET BETWEEN THE DATA OUTLETS, AND FROM DATA OUTLETS TO STUB ABOVE CEILING. ALSO, PROVIDE A SIMILAR SET OF CONDUITS FROM LOWER DATA OUT TO CONNECT TO FLOOR BOX, AND TO RUN BETWEEN FLOOR BOXES.
4	CONDUIT, INNERDUCT AND FIBER-OPTIC BACKBONE CABLING FROM IT EQUIPMENT RACK IN ADP ROOM 2752. REFER TO SHEET E-2-04.
5	EC SHALL PROVIDE FURNITURE FEED. PROVIDE 1" CONDUIT STUB-UP FOR DATA FEED. PROVIDE POWER FEED WITH (2) 120V, 20A DEDICATED CIRCUITS. EACH WITH A DEDICATED NEUTRAL. 8-WIRE FEED CONSISTING OF 8#12 + 1#12 IN 1" C.
6	ASSUMED LOCATION OF FIRE-RATED PARTITION. PROVIDE CONDUIT SLEEVE THROUGH FIRE-RATED PARTITION AND SUITABLE FIRE-RETARDANT PILLOW BLOCK AT PENETRATION.
7	PROVIDE NEW FLOOR-STANDING IT EQUIPMENT RACK IN NEW IT ROOM, COMPLETE WITH VERTICAL AND HORIZONTAL CABLE MANAGERS, PDU, FIBER-DISTRIBUTION UNIT (FDU), PATCH PANELS AND RELOCATED EQUIPMENT FROM THE SALVAGED IT CABINET FROM NEARBY STORAGE ROOM. REFER TO DIVISION 27 SPECIFICATIONS INCLUDING SECTIONS 271100 AND 271116. LEAVE SPACE AT BOTTOM OF RACK FOR (1) OR (2) OWNER-PROVIDED UPS'S. COORDINATE LAYOUT WITHIN MIDDLE OF RACK FOR CONFIGURATION OF HORIZONTAL CABLE MANAGERS, PATCH PANELS AND OWNER-PROVIDED NETWORK SWITCHES. ARRANGE FDU AND PDU AT TOP OF RACK.
8	PROVIDE A 4'W X 8'H SHEET OF 3/4" FIRE RATE AC PLYWOOD BACKING ON WALL, PAINTED WITH FIRE-RETARDANT PAINT TO MATCH SURROUNDING WALL EXCEPT LEAVING A WINDOW UNPAINTED TO SHOW FIRE STAMP.
9	ROUTE TELECOM CABLING INTO FURNITURE SYSTEM AND TERMINATE AT 2-PORT OUTLET WITHIN EACH CUBICLE. EXISTING "NORTH" IT ROOM.
10	EXISTING "NORTH" IT ROOM.
11	ALL VOICE/DATA OUTLETS IN THIS AREA SHALL BE CABLED BACK TO THE EXISTING "NORTH" IT ROOM.

GENERAL NOTES

A	UNLESS OTHERWISE NOTED, ALL CIRCUIT NUMBERS INDICATED ON THIS SHEET SHALL REFER TO CIRCUIT ORIGINATING IN PANELBOARDS BASED UPON THE FOLLOWING CONVENTION, (THIS SHEET ONLY): TBD-# = CIRCUIT TO PANEL 'TBD'
B	REFER TO 'FA' DRAWINGS FOR FIRE ALARM INFORMATION AND SCOPE OF WORK.
C	ALL NEW TELECOMMUNICATIONS OUTLETS SHOWN ON THESE DRAWINGS SHALL BE CABLED BACK TO THE NEW IT EQUIPMENT RACK IN STORAGE ROOM 2409.

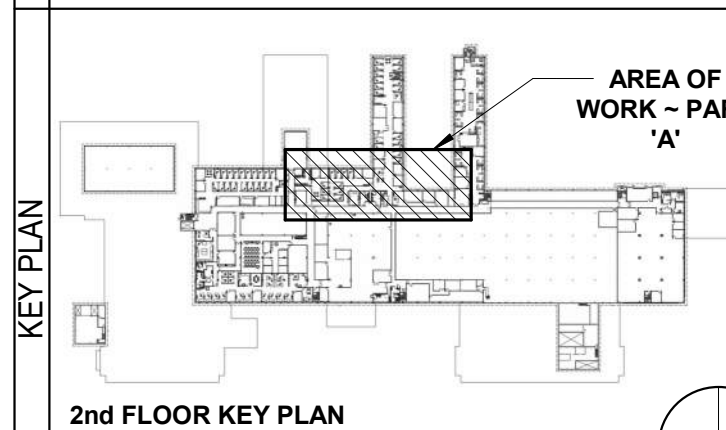

MARK	DATE	DESCRIPTION

CONTRACTOR	DESCRIPTION
A/E CON. NO.	GS-08P-JB-D-0017
A/E TASK NO.	EP-GS-P-08-16-JB-7053
CONS. CONTR.	GS-08P-13-JB-D-0032
CONS. WORK	
PRIM A/E	ANDERSON HALLAS ARCHITECT PC
SUB A/E	
CONSTR. CON.	


BUILDING	DESCRIPTION
NAME	BUILDING 56
STREET	6TH STREET
CITY/ST/ZIP	DENVER, COLORADO 80255
BUILDING NO.	BUILDING 56
OTHER BUILDING NOS	
FACILITY CODE	

PROJECT	DESCRIPTION
PROJECT TITLE	BUILDING 56 - NRCS
PROJECT DESCRIPTION	BUILDING 56 - 2ND FLOOR NRCS CONSOLIDATION
PROJECT NO.	EP-GS-P-08-16-JB-7053
GSA PM	BEN REKO
SUBMISSION	100% CONSTRUCTION DOCUMENTS
SUB. DATE	7/25/2019


DRAWING	DESCRIPTION
DRAWING TITLE	ELECTRICAL POWER PLAN - AREA A
FILE NAME	
FLOOR NO.	
DRAWN BY	
CHECKED BY	

DATE DRAFTED	SHEET SIZE
	22X34

DRAWING NO.	E 2 01
DISCIPLINE	ELECTRICAL
SHEET	30
OF	50

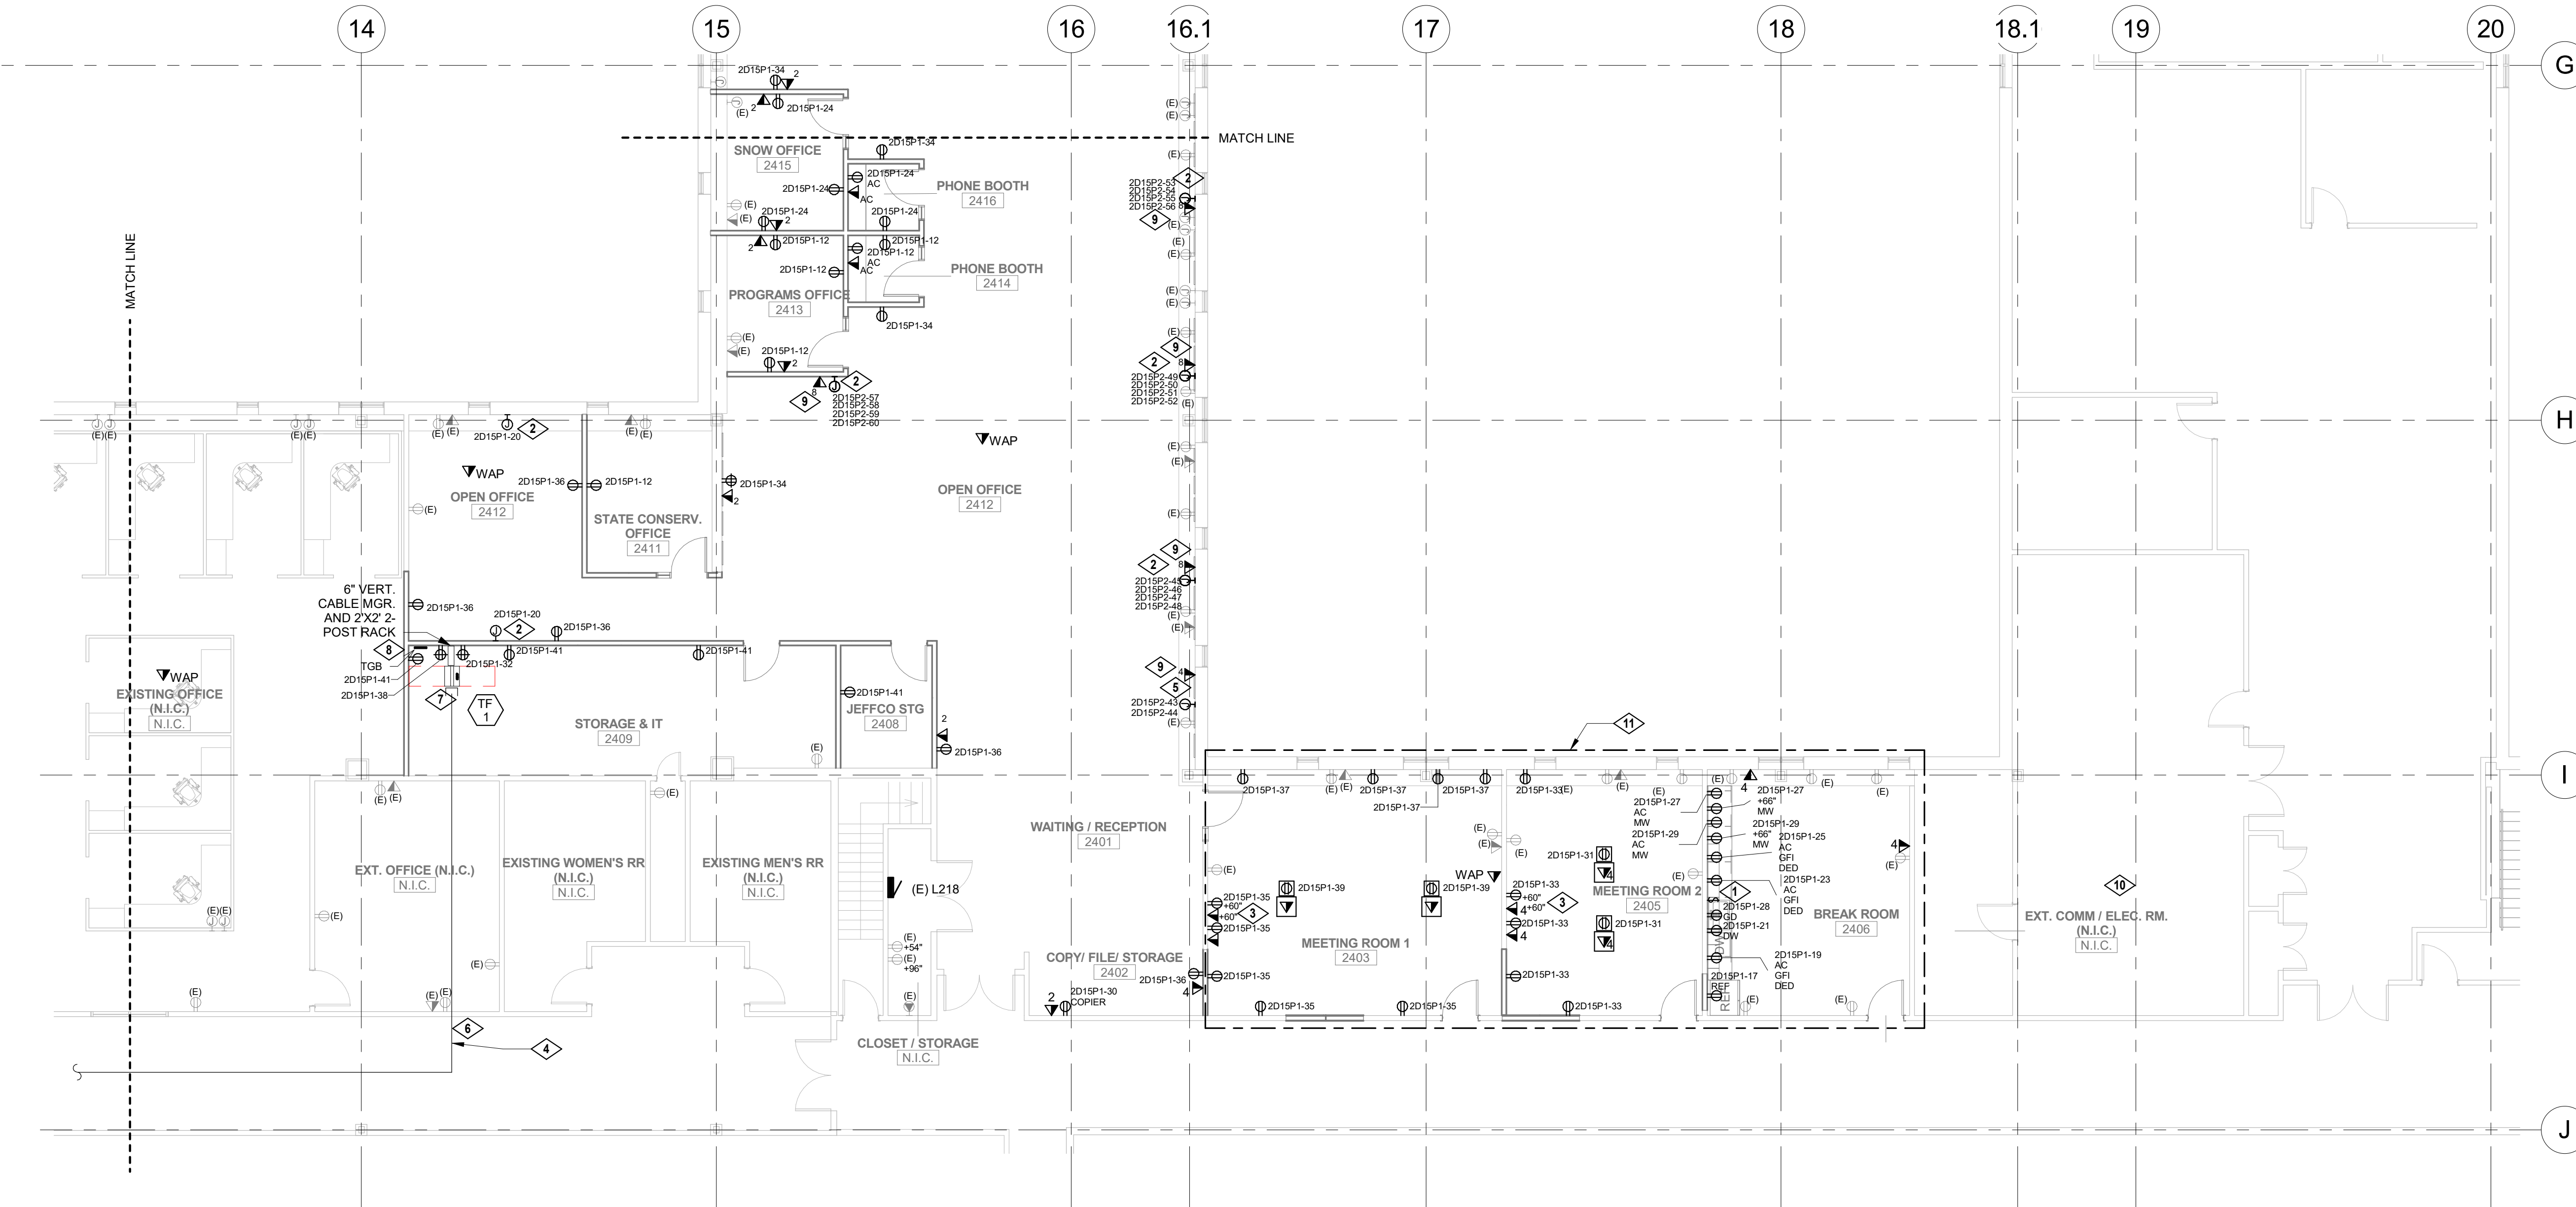

ELECTRICAL POWER PLAN - AREA A
1/8" = 1'-0"
NORTH

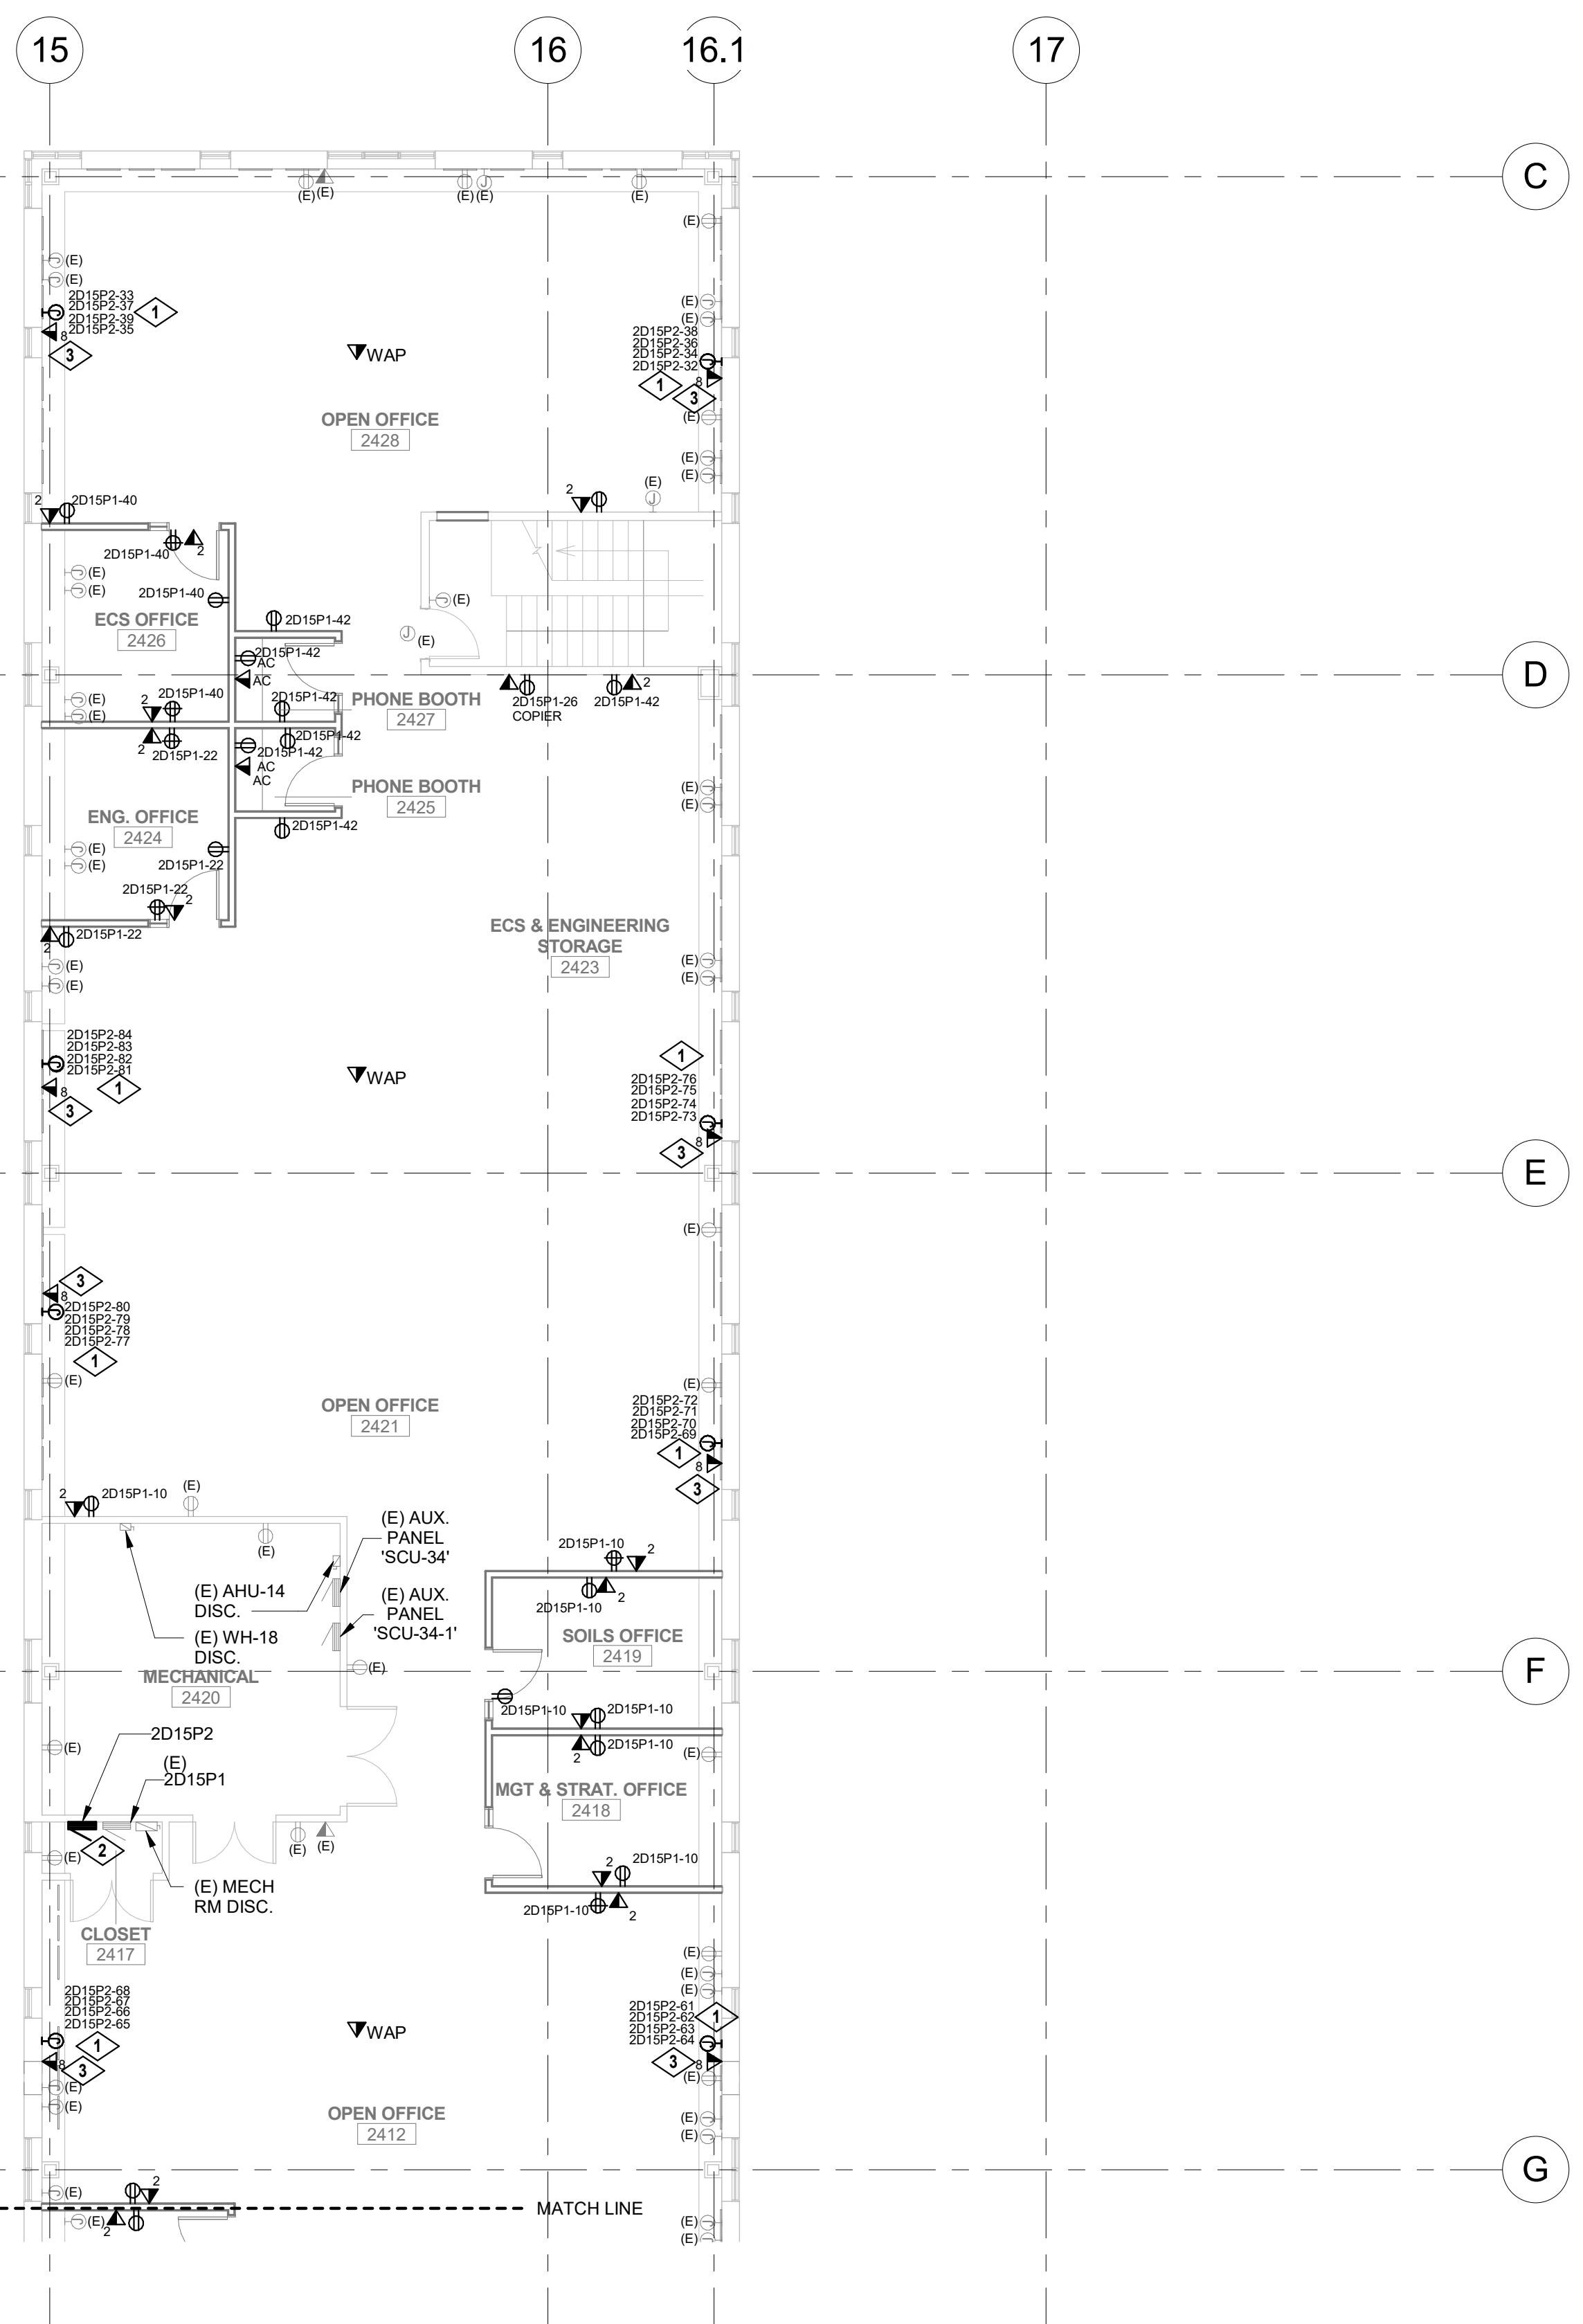

GENERAL NOTES

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B	REFER TO 'FA' DRAWINGS FOR FIRE ALARM INFORMATION AND SCOPE OF WORK.
C	ALL NEW TELECOMMUNICATIONS OUTLETS SHOWN ON THESE DRAWINGS SHALL BE CABLED BACK TO THE NEW IT EQUIPMENT RACK IN STORAGE ROOM 2409.

KEYNOTE LEGEND

KEY VALUE	KEYNOTE TEXT
1	EC SHALL PROVIDE FURNITURE FEED. PROVIDE 1" CONDUIT STUB-UP FOR DATA FEED. PROVIDE POWER FEED WITH (4) 120V, 20A DEDICATED CIRCUITS. EACH WITH A DEDICATED NEUTRAL. 8-WIRE FEED CONSISTING OF #12 + 1#12 IN 1" C.
2	REPLACEMENT PANEL AT SAME LOCATION AS PRE-EXISTING ONE. RE-TERMINATE ALL PRE-EXISTING CONDUITS AND BRANCH CIRCUITS INTO NEW PANEL AT SAME BREAKER LOCATIONS. PROVIDE WIRING GUTTER/J-BOXES ABOVE NEW PANEL AS REQUIRED TO SPLICE AND EXTEND CIRCUITS INTO NEW PANEL. REFER TO ONE-LINE DIAGRAM.
3	ROUTE TELECOM CABLING INTO FURNITURE SYSTEM AND TERMINATE AT 2-PORT OUTLET WITHIN EACH CUBICLE.

NORTH **1** ELECTRICAL POWER PLAN - AREA B
1/8" = 1'-0"


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GSA
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Project Manager
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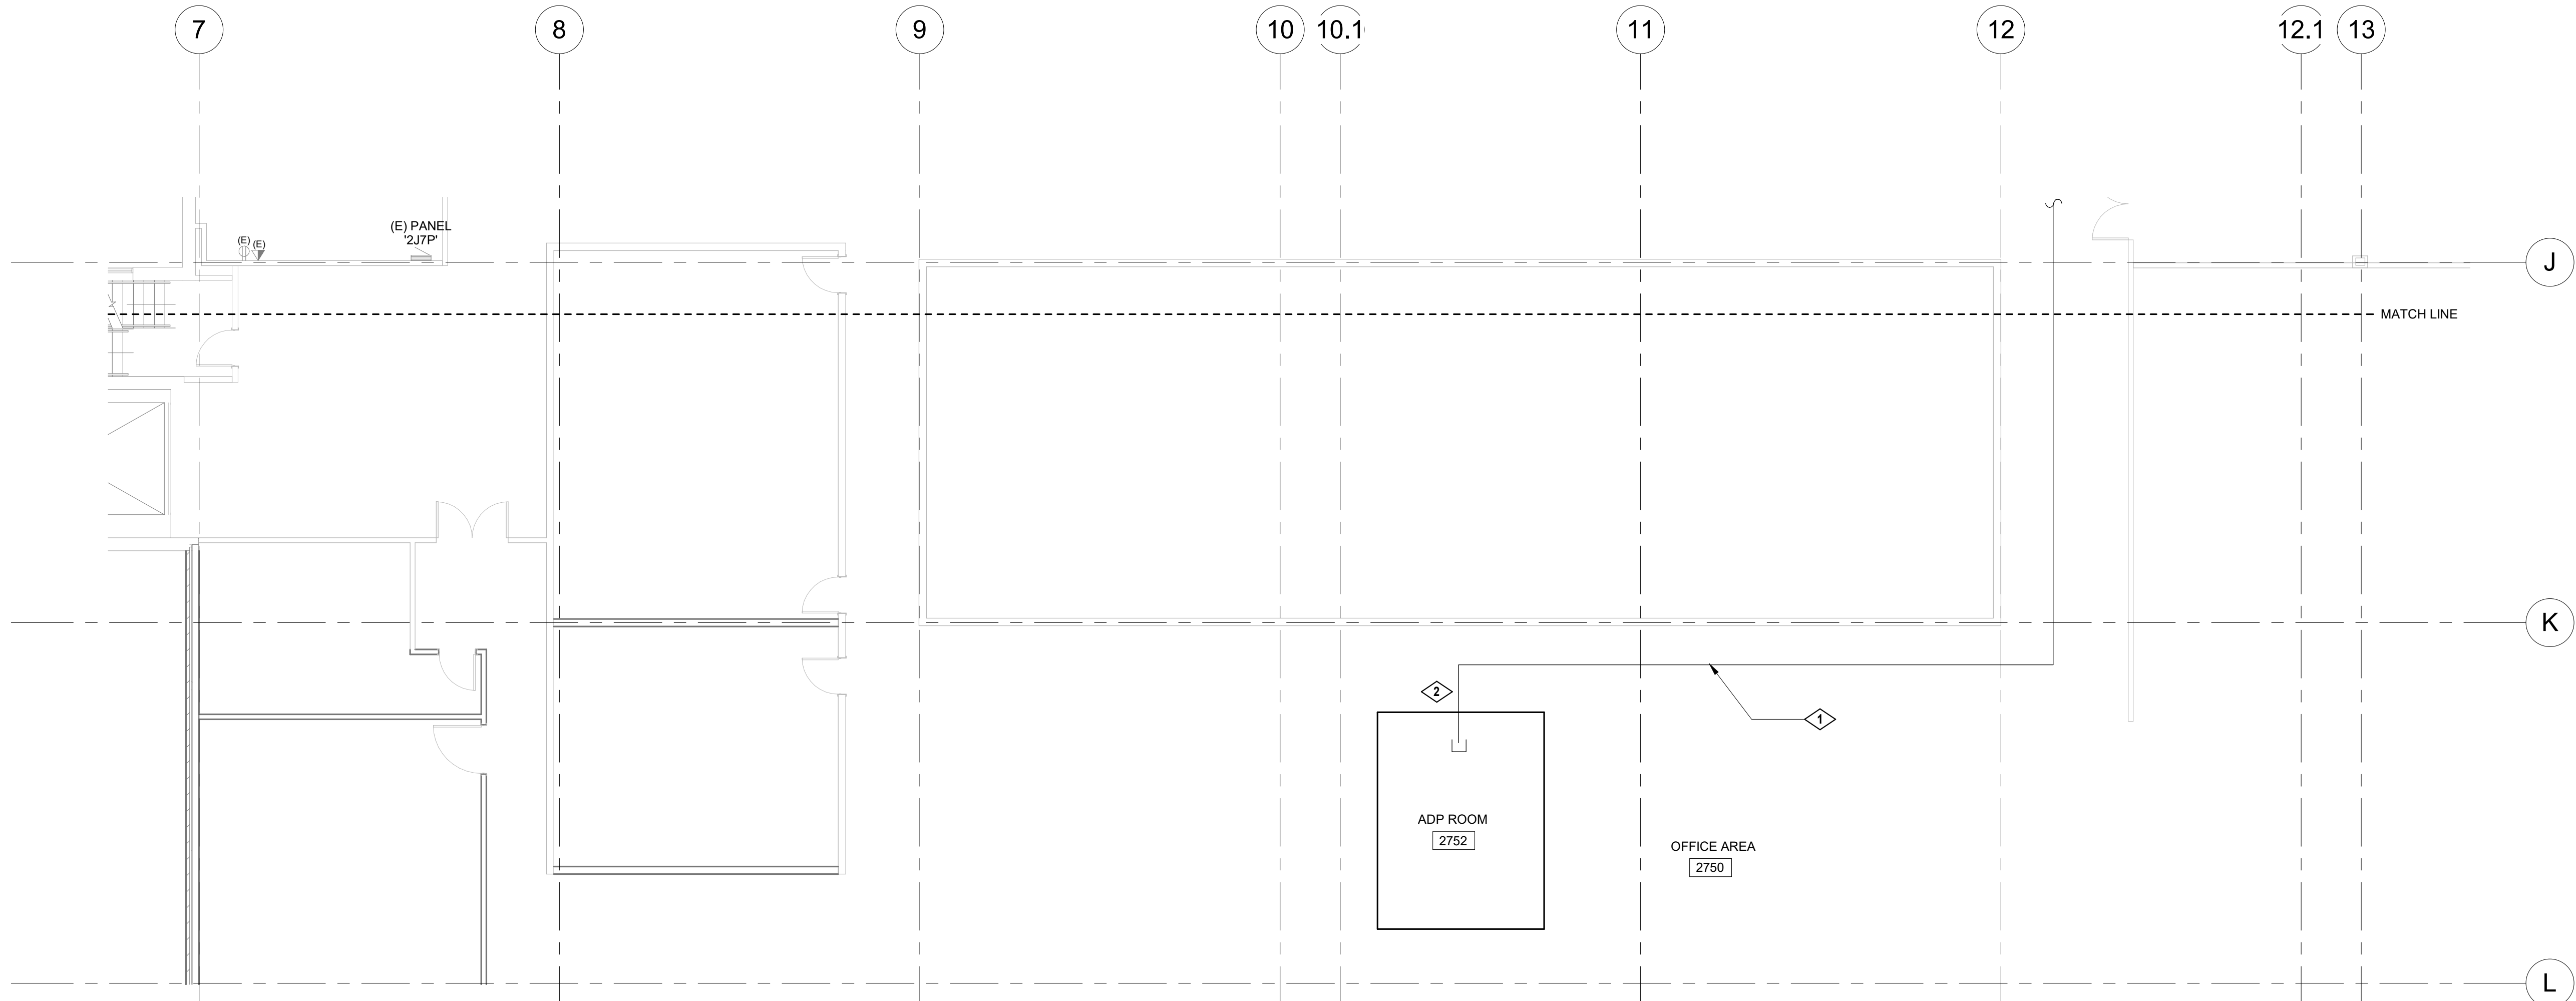
ELECTRICAL POWER PLAN - AREA C
1/8" = 1'-0"
NORTH

CERTIFICATION		
KEY PLAN		
<p>2nd FLOOR KEY PLAN</p>		
REVISION NOTES		
MARK	DATE	DESCRIPTION
CONTRACTORS		
A/E CON. NO.	GS-08P-JB-D-0017	
A/E TASK NO.	EP-GS-P-08-16-JB-7053	
CONS. CONTR.	GS-08P-13-JB-D-0032	
CONS. WORK		
PRIM A/E	ANDERSON HALLAS ARCHITECT PC	
SUB A/E		
CONSTR. CON.		
BUILDING		
NAME	BUILDING 56	
STREET	6TH STREET	
CITY/ST./ZIP	DENVER, COLORADO 80255	
BUILDING NO.	BUILDING 56	
OTHER BUILDING NOS		
FACILITY CODE		
PROJECT		
PROJECT TITLE	BUILDING 56 - NRCS	
PROJECT DESCRIPTION	BUILDING 56 - 2ND FLOOR NRCS CONSOLIDATION	
PROJECT NO.	EP-GS-P-08-16-JB-7053	
GSA PM	BEN REKO	
SUBMISSION	100% CONSTRUCTION DOCUMENTS	
SUB. DATE	7/25/2019	
DRAWING TITLE	ELECTRICAL POWER PLAN - AREA C	
FILE NAME		
FLOOR NO.		
DRAWN BY	DATE DRAFTED:	
CHECKED BY	SHEET SIZE: 22X34	
DRAWING NO.	E 2 03	
DISCIPLINE		
SHEET TYPE		
SEQUENCE		
SHEET	32 OF 50	

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KEYNOTE LEGEND	
KEY VALUE	KEYNOTE TEXT
1	PROVIDE A 3" CONDUIT WITH (2) 1" INNERDUCTS FROM ADP ROOM 2752 TO NEW IT ROOM 2410 ON SHEET E-2-01. FOR CONVEYANCE OF NEW FIBER-OPTIC BACKBONE CABLING BETWEEN IT RACKS IN BOTH ROOMS. PROVIDE (1) FIBER-OPTIC BACKBONE CABLE FROM EXISTING FIBER DISTRIBUTION UNIT (FDU) WITHIN ADP ROOM 2752. ROUTED THROUGH INNERDUCT, TO TERMINATE AT NEW RACK-MOUNTED FDU WITHIN THE NEW FLOOR MOUNTED EQUIPMENT RACK IN IT ROOM 2410. REFER TO SECTION 271323 FOR FIBER CABLING AND FDU SPECIFICATIONS. PROVIDE FULL TURN-KEY CABLING INSTALLATION WITH HARDWARE AND TERMINATIONS AND TESTING.
2	ASSUMED LOCATION OF FIRE-RATED PARTITION. PROVIDE CONDUIT SLEEVE THROUGH FIRE-RATED PARTITION AND SUITABLE FIRE-RETARDENT PILLOW BLOCK AT PENETRATION.



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NORTH 1
ELECTRICAL POWER PLAN - AREA D
1/8" = 1'-0"

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 Project Manager
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MARK	DATE	DESCRIPTION



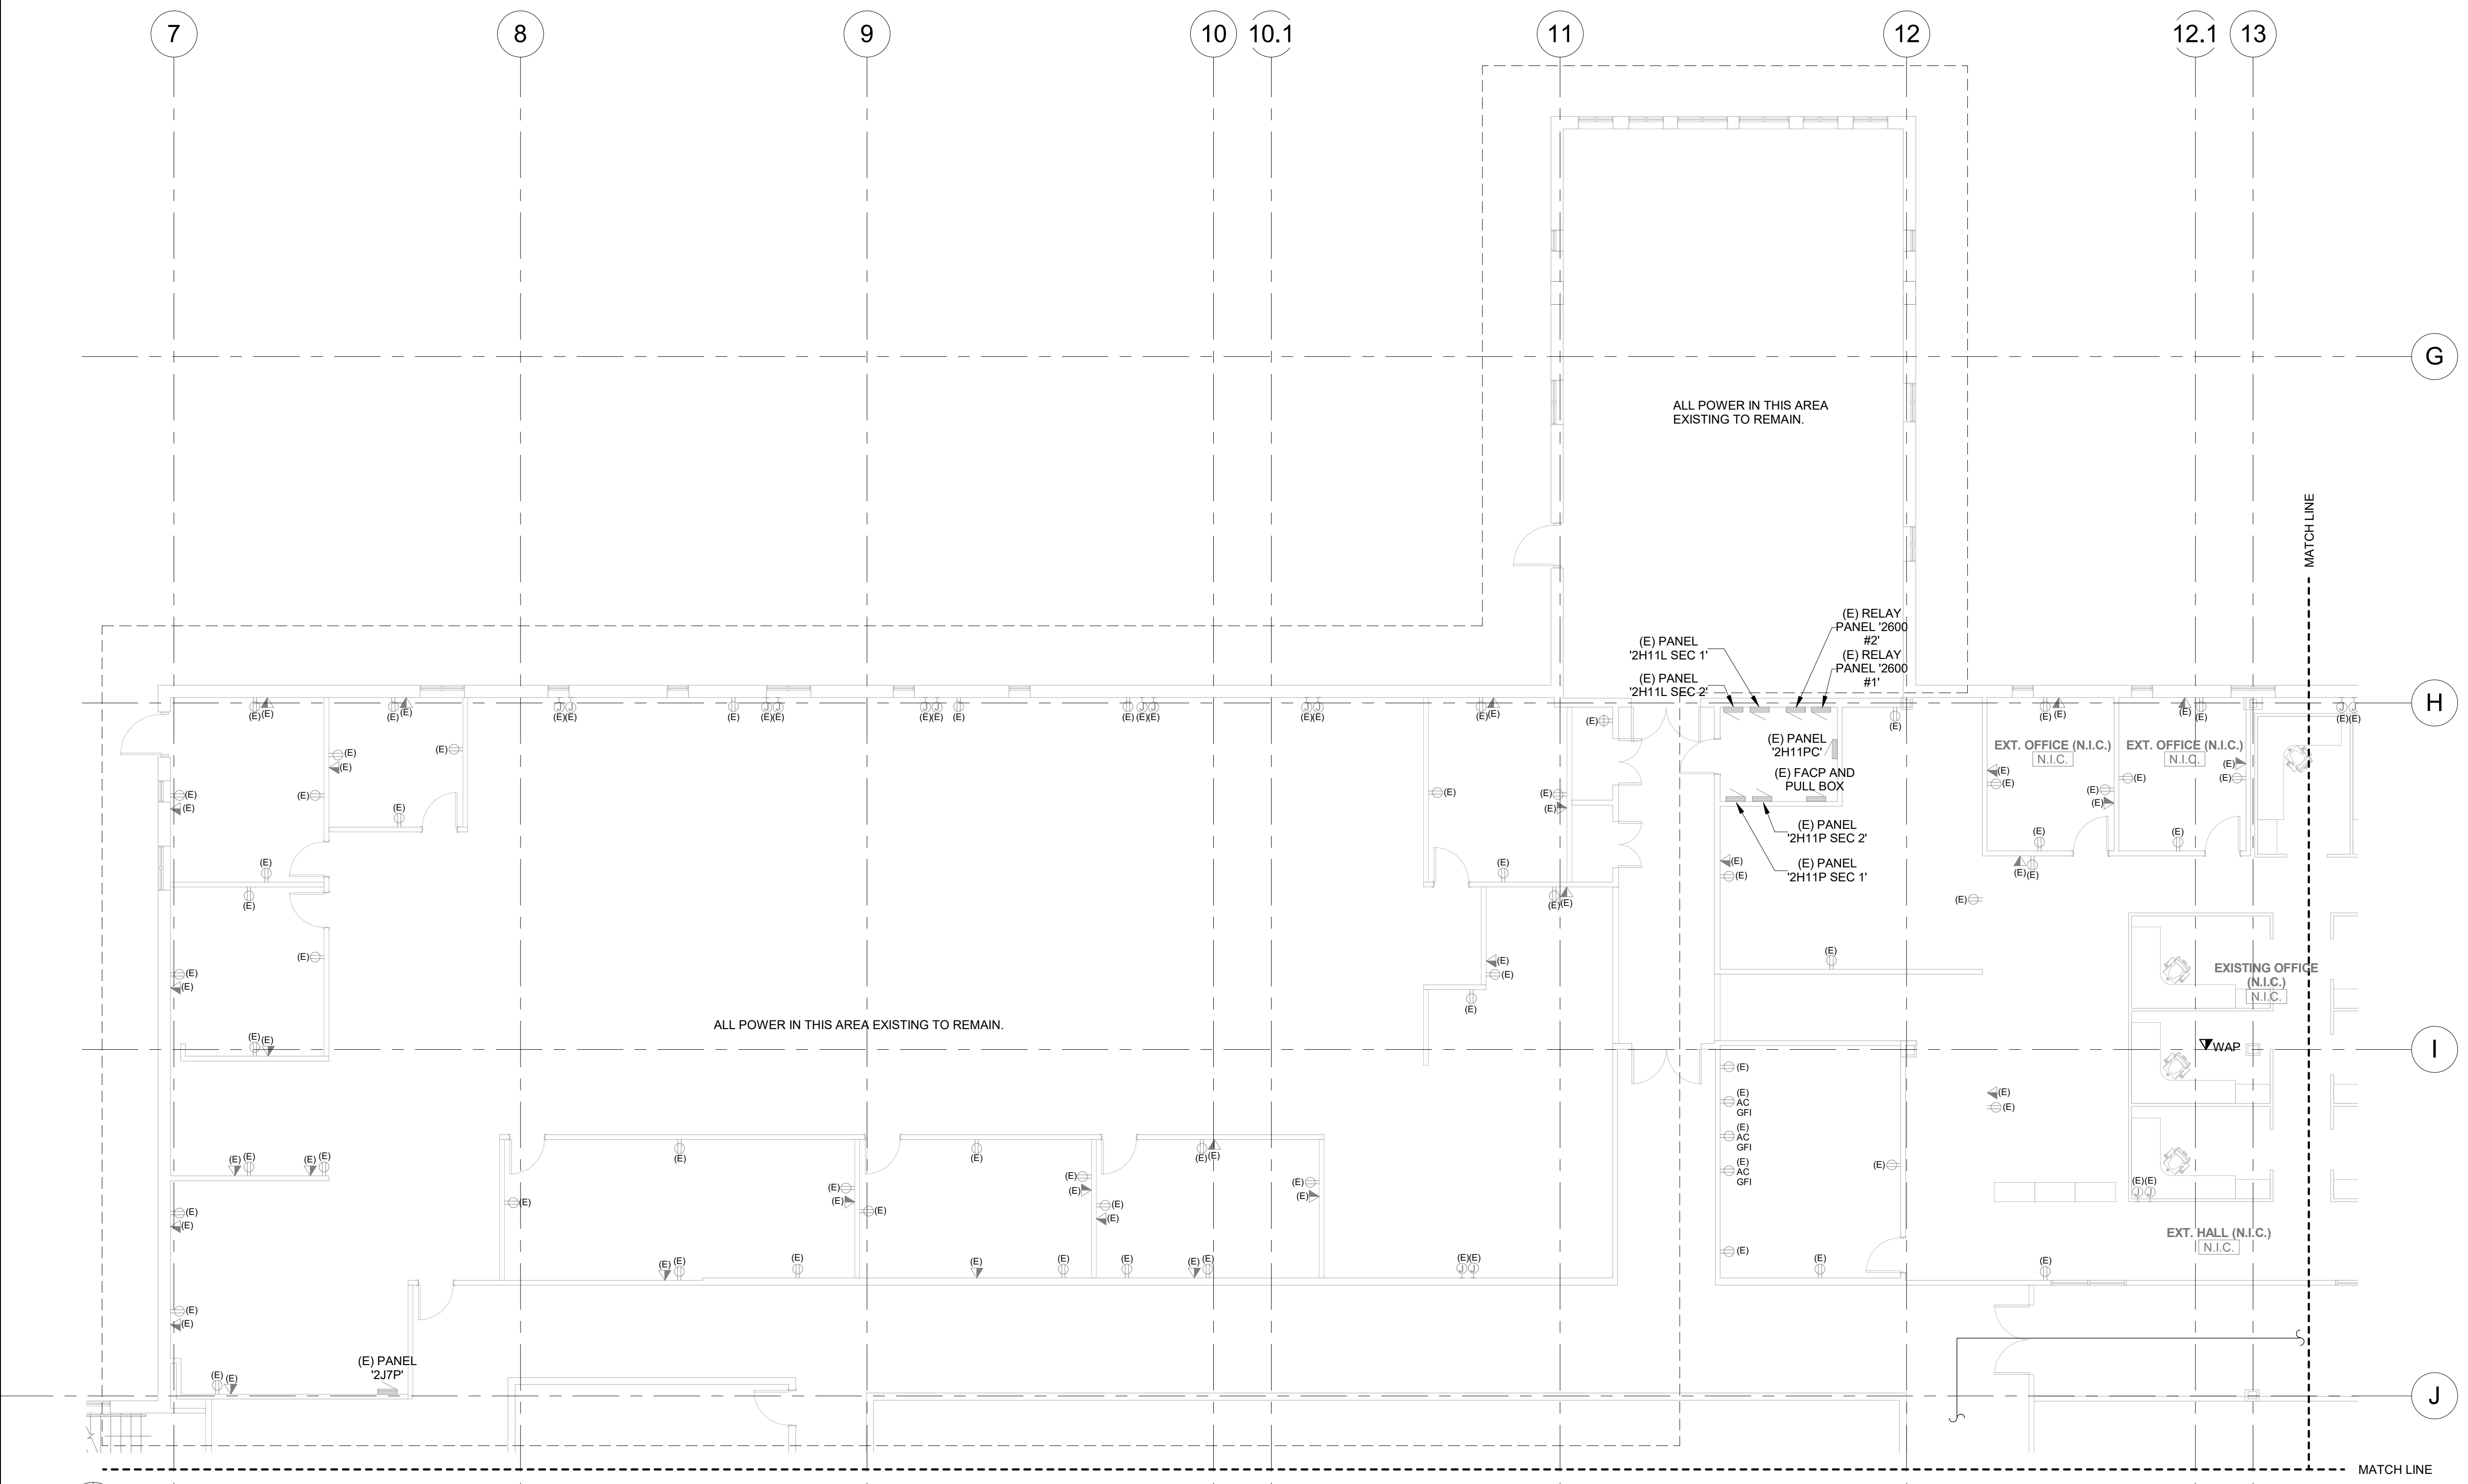
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A/E CON. NO.	NAME	PROJECT TITLE
A/E TASK NO.	STREET	PROJECT DESCRIPTION
CONS. CONTR.	CITY/ST./ZIP	PROJECT NO.
CONS. WORK	BUILDING NO.	GSA PM
PRIM A/E	OTHER BUILDING NOS	SUBMISSION
SUB A/E	FACILITY CODE	SUB. DATE
CONSTR. CON.		DRAWING TITLE
		FILE NAME
		FLOOR NO.
		DRAWN BY
		CHECKED BY
		DRAWING NO.
		DISCIPLINE
		SHEET
		SEQUENCE
		OF

GENERAL NOTES

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KEYNOTE LEGEND

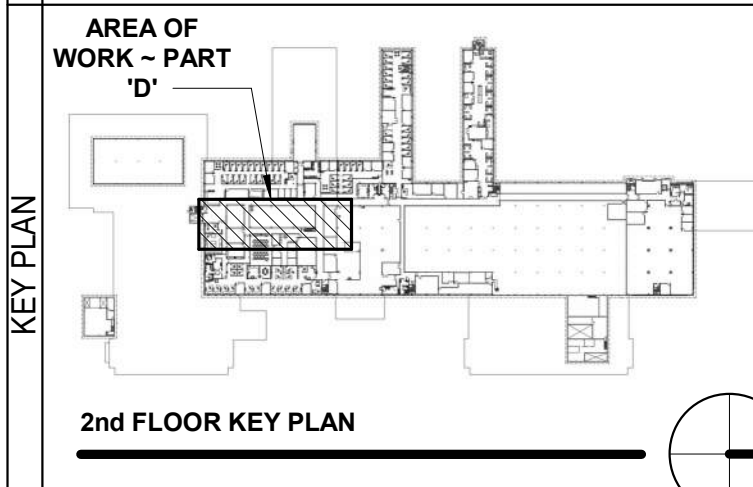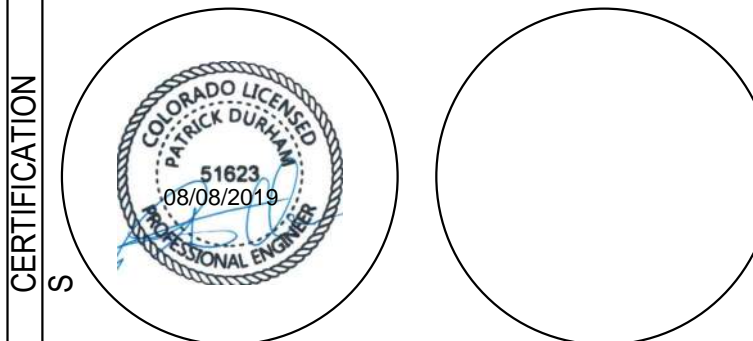KEY VALUE	KEYNOTE TEXT

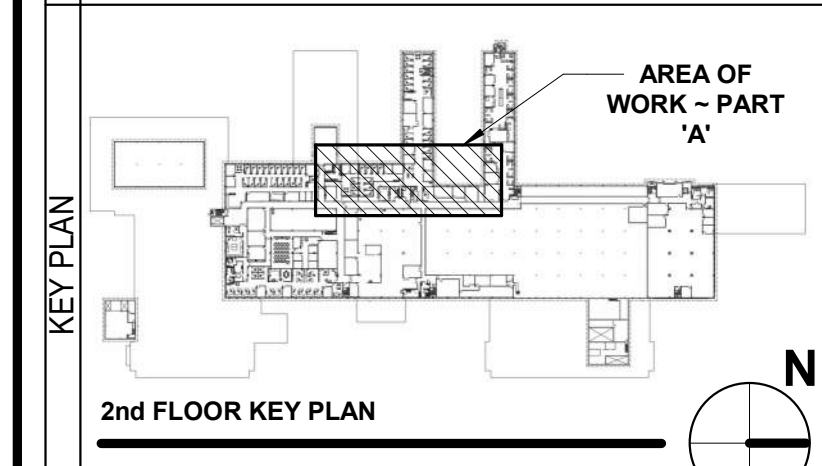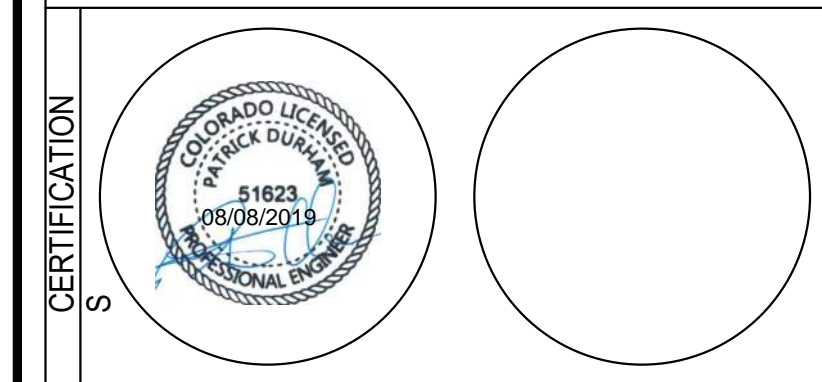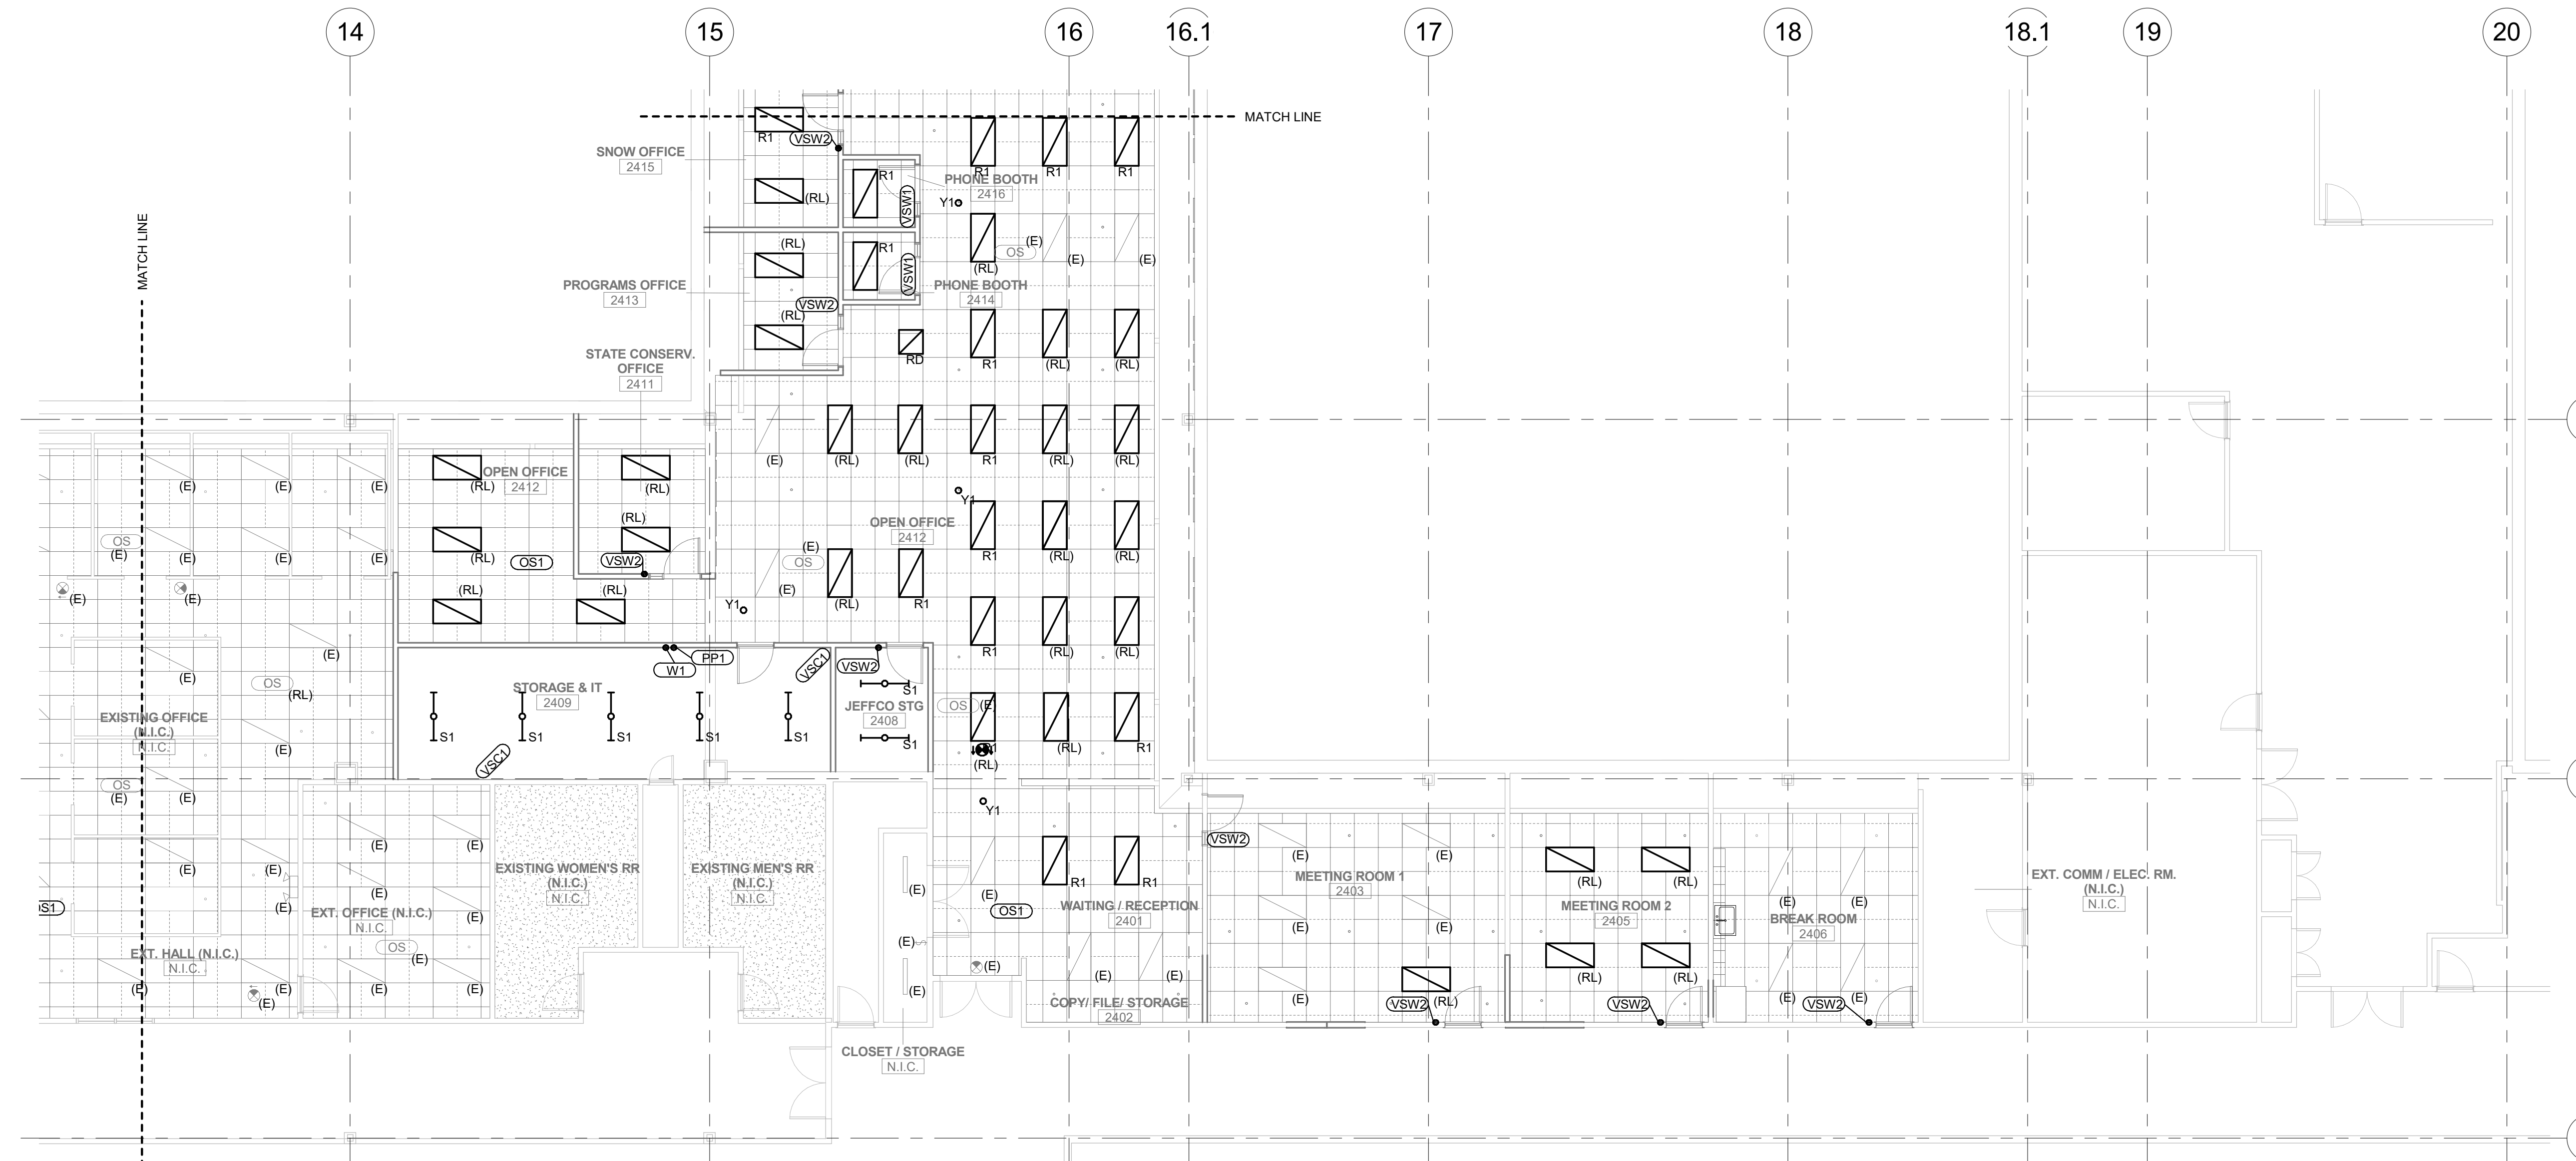

REVISION NOTES

MARK	DATE	DESCRIPTION

GRAPHIC SCALE

CONTRACTORS

A/E CON. NO.	GS-08P-JB-D-0017
A/E TASK NO.	EP-GS-P-08-16-JB-7053
CONS. CONTR.	GS-08P-13-JB-D-0032
CONS. WORK	
PRIM A/E	ANDERSON HALLAS ARCHITECT PC
SUB A/E	
CONSTR. CON.	

BUILDING

NAME	BUILDING 56
STREET	6TH STREET
CITY/ST/ZIP	DENVER, COLORADO 80255
BUILDING NO.	BUILDING 56
OTHER BUILDING NOS	
FACILITY CODE	

PROJECT


PROJECT TITLE	BUILDING 56 - NRCS
PROJECT DESCRIPTION	BUILDING 56 - 2ND FLOOR NRCS CONSOLIDATION
PROJECT NO.	EP-GS-P-08-16-JB-7053
GSA PM	BEN REKO
SUBMISSION	100% CONSTRUCTION DOCUMENTS
SUB. DATE	7/25/2019
DRAWING TITLE	ELECTRICAL LIGHTING PLAN - AREA A

DRAWING

FILE NAME	
FLOOR NO.	
DRAWN BY	DATE DRAFTED:
CHECKED BY	SHEET SIZE: 22X34
DRAWING NO.	E 3 01
DISCIPLINE	SHEET TYPE SEQUENCE
SHEET 34	OF 50

1 NORTH
ELECTRICAL LIGHTING PLAN - AREA A
1/8" = 1'-0"



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SUB. DATE	7/25/2019
PROJECT	
DRAWING TITLE	ELECTRICAL LIGHTING PLAN - AREA B
FILE NAME	
FLOOR NO.	
DRAWN BY	DATE DRAFTED:
CHECKED BY	SHEET SIZE: 22X34
DRAWING NO.	E 3 02
DISCIPLINE	SHEET TYPE SEQUENCE
SHEET	35 OF 50

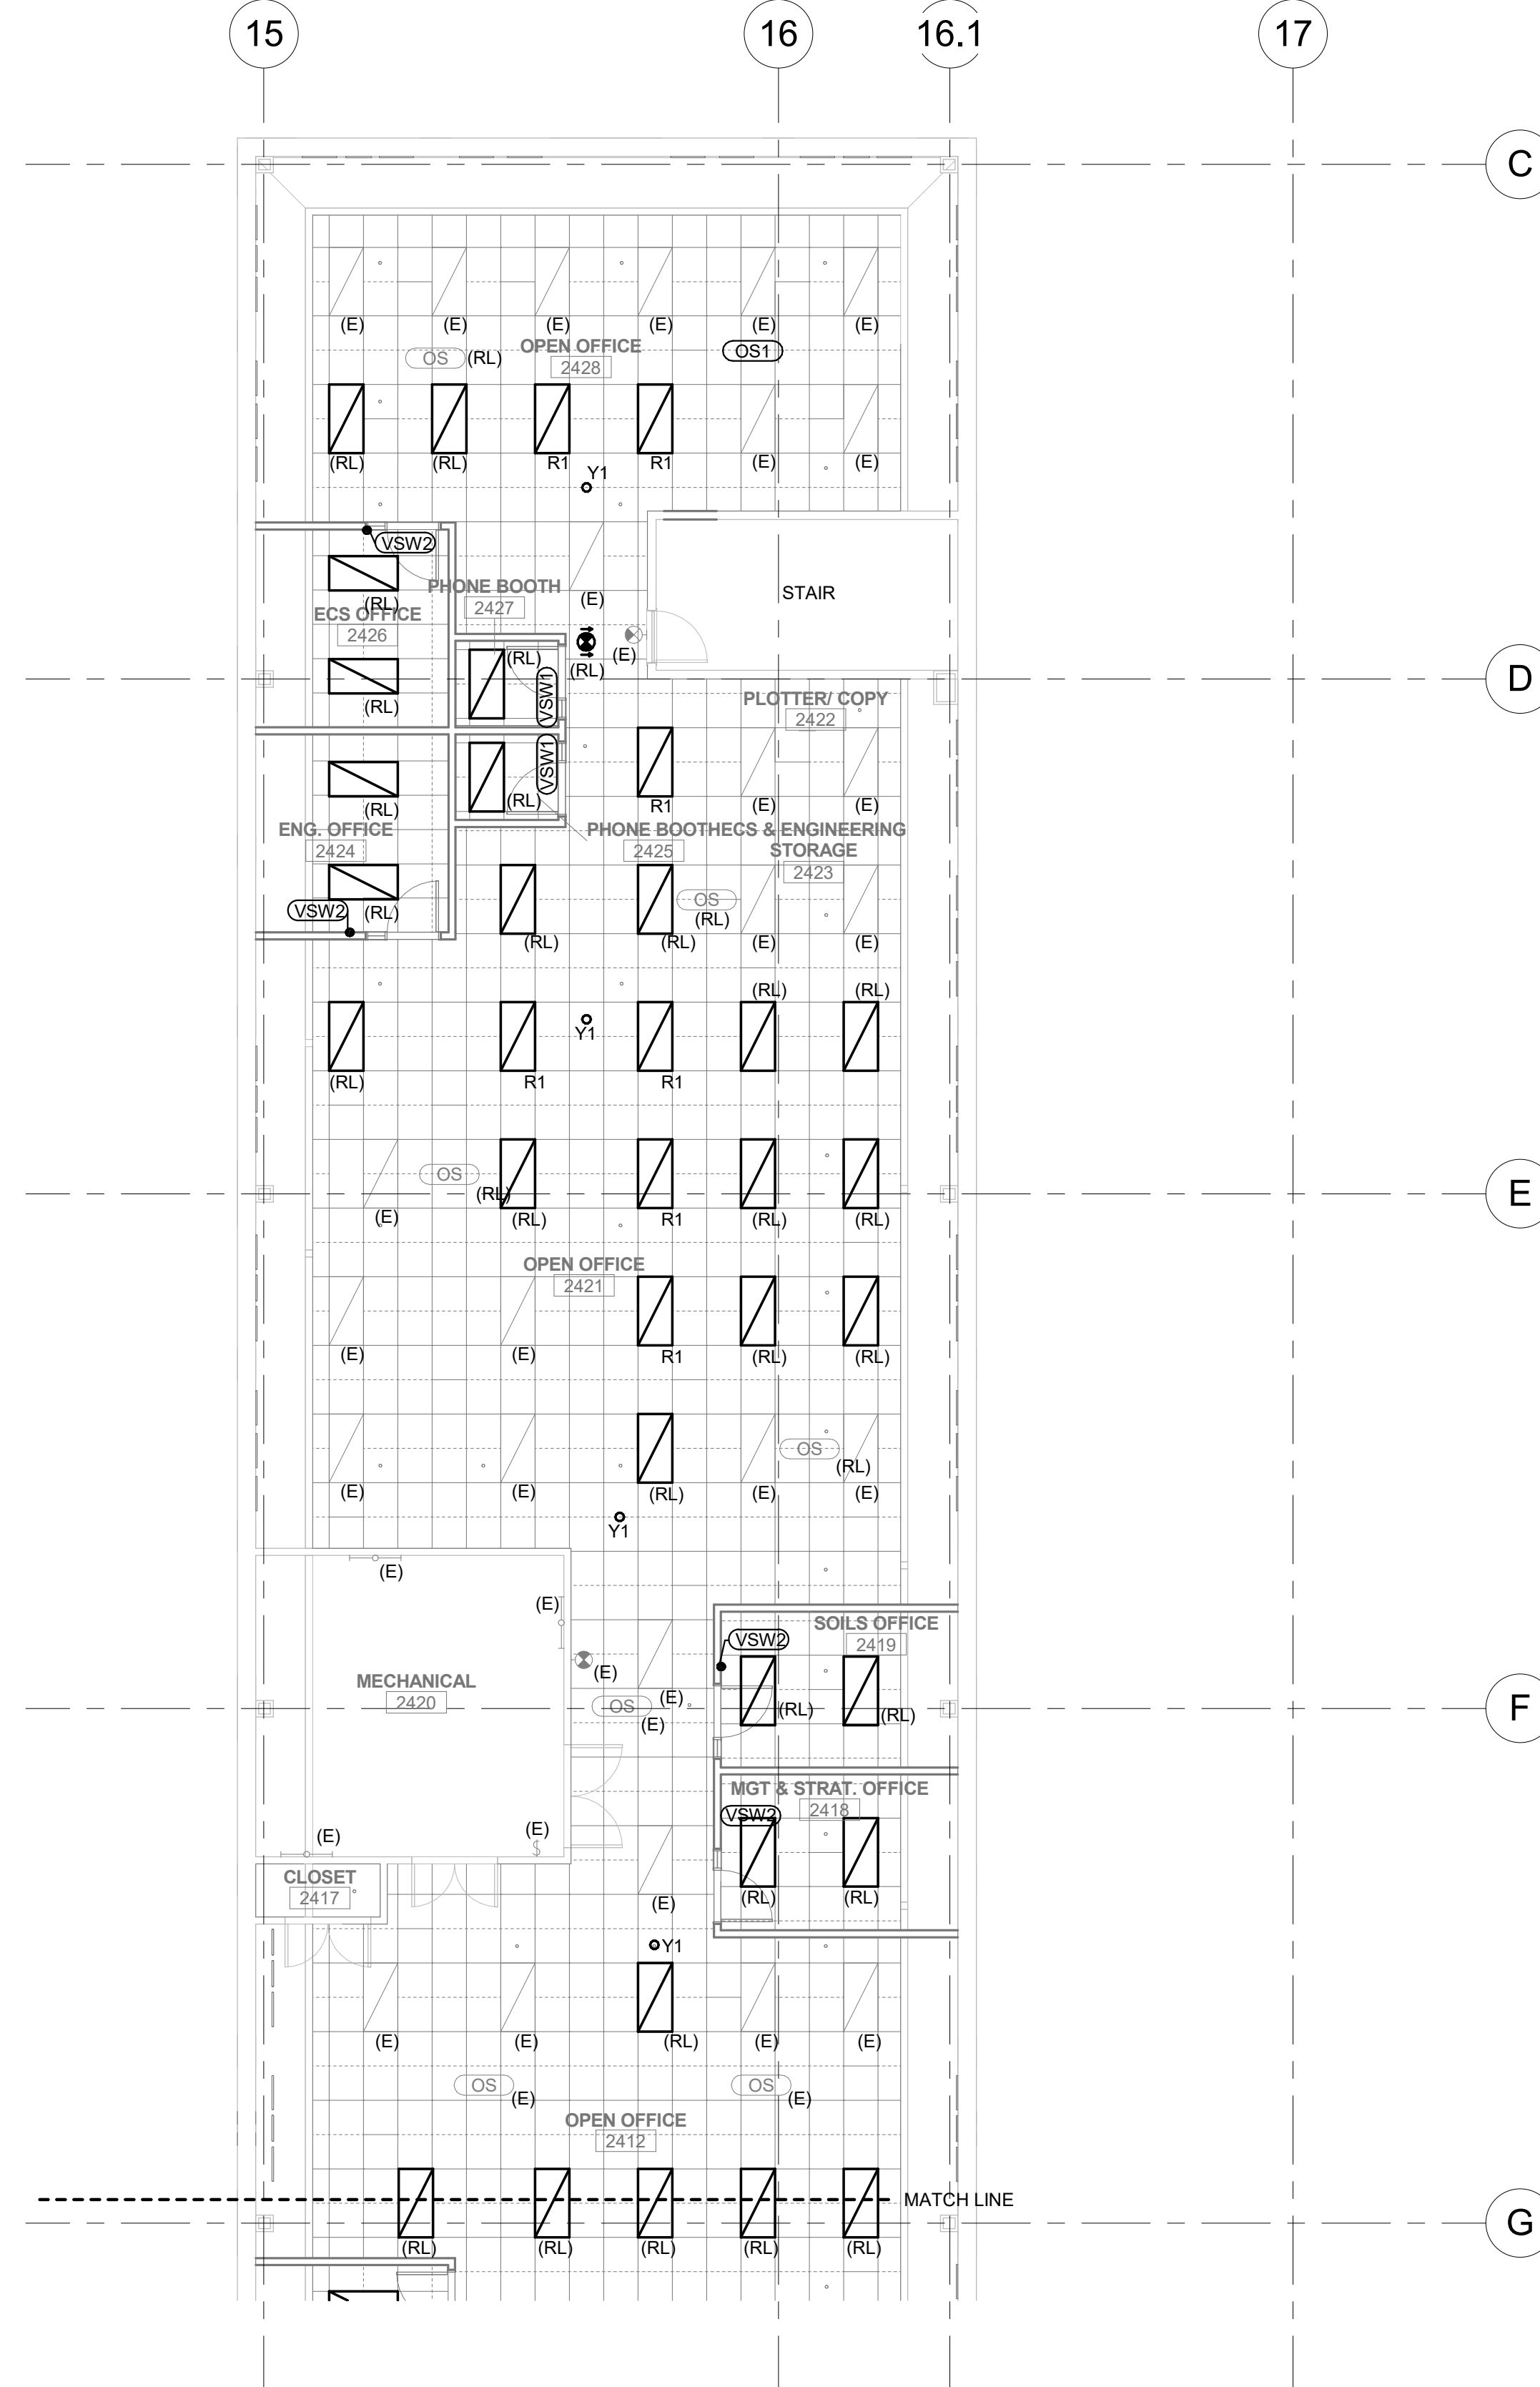1 NORTH
 ELECTRICAL LIGHTING PLAN - AREA B
 1/8" = 1'-0"

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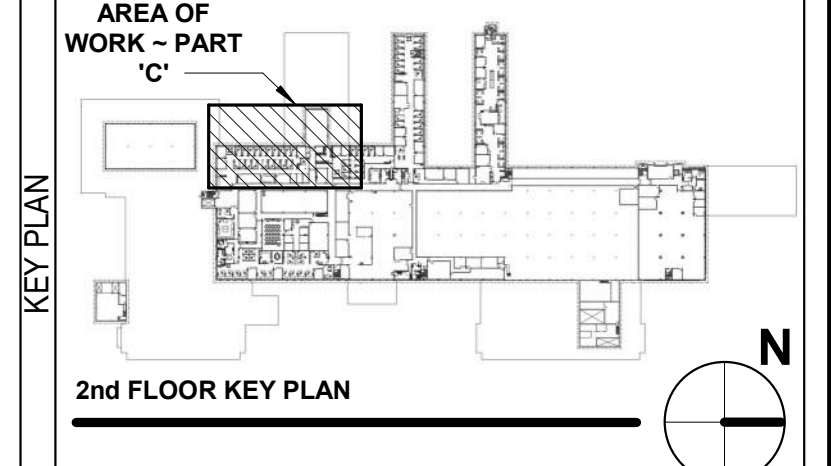
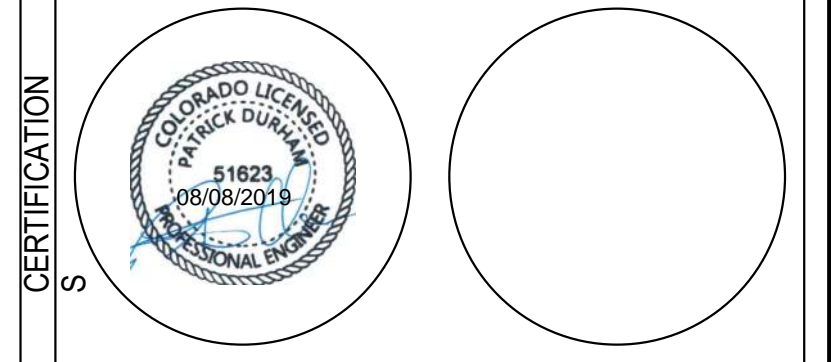
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GENERAL SERVICES ADMINISTRATION

GSA


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SUB A/E	
CONSTR. CON.	
BUILDING	
NAME	BUILDING 56
STREET	6TH STREET
CITY/ST./ZIP	DENVER, COLORADO 80255
BUILDING NO.	BUILDING 56
OTHER BUILDING NOS	
FACILITY CODE	
PROJECT	
PROJECT TITLE	BUILDING 56 - NRCS
PROJECT DESCRIPTION	BUILDING 56 - 2ND FLOOR NRCS CONSOLIDATION
PROJECT NO.	EP-GS-P-08-16-JB-7053
GSA PM	BEN REKO
SUBMISSION	100% CONSTRUCTION DOCUMENTS
SUB. DATE	7/25/2019
DRAWING TITLE	ELECTRICAL LIGHTING PLAN - AREA C
FILE NAME	
FLOOR NO.	
DRAWN BY	DATE DRAFTED:
CHECKED BY	SHEET SIZE: 22X34
DRAWING NO.	E 3 03
DISCIPLINE	SHEET TYPE SEQUENCE
SHEET 36	OF 50

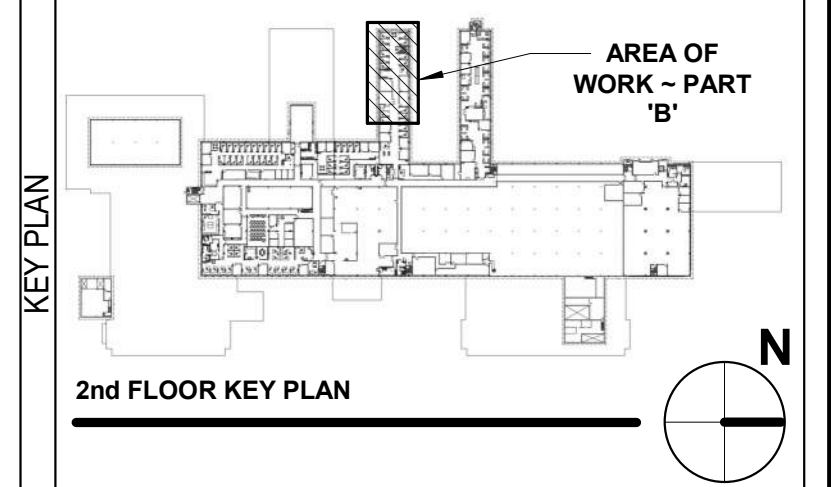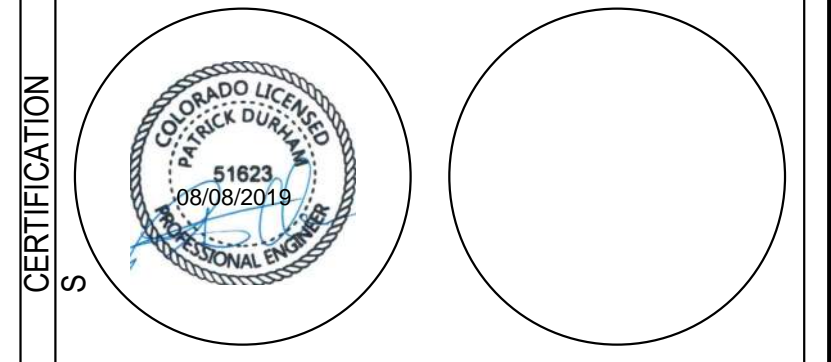

ELECTRICAL LIGHTING PLAN - AREA C
1/8" = 1'-0"

8/8/2019 8:25:33 AM

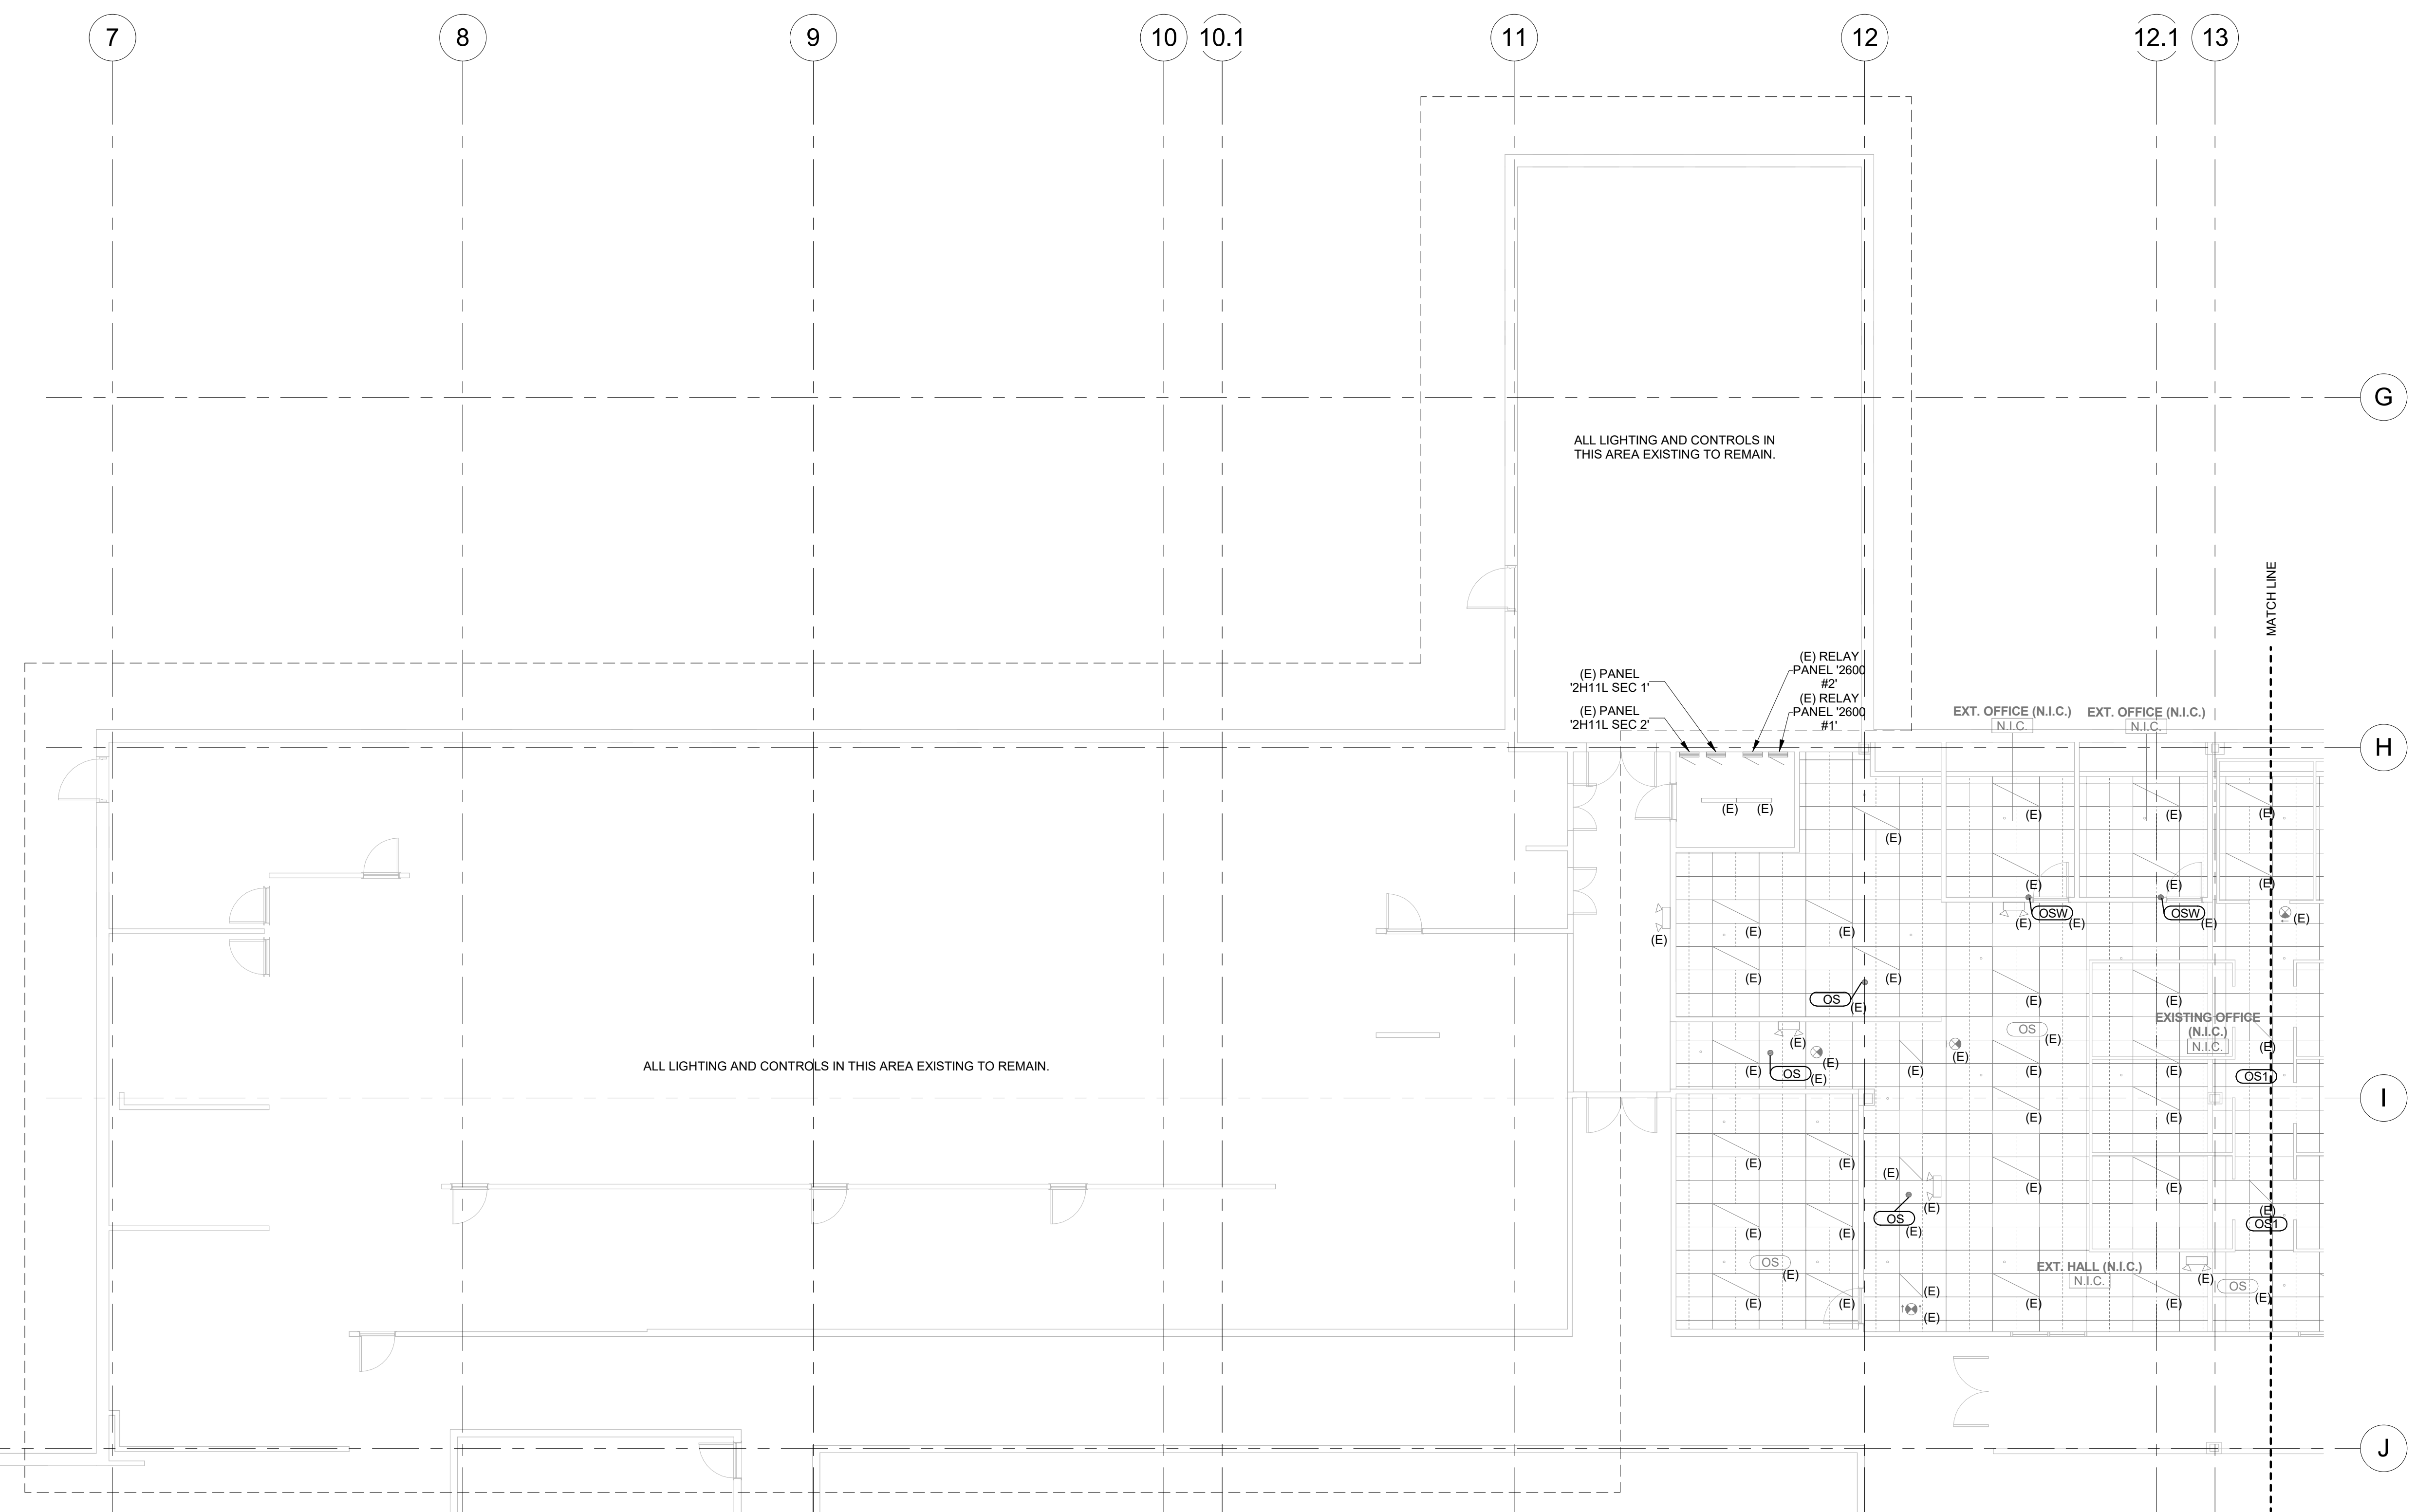

LIGHTING FIXTURE SCHEDULE

TYPE	DESCRIPTION	MANUFACTURER	CATALOG NUMBER	VOLTAGE	LAMP QUAN.	LAMP WATTAGE	LAMP	MAX WATTAGE	DIMMING	MOUNTING LOCATION	BOF/RFD/OFH	NOTES
(E)	EXISTING TO REMAIN							0 VA				
(ER)	EXISTING TO BE RELOCATED							0 VA				
(R)	REMOVE EXISTING							0 VA				
(RL)	RELOCATED EXISTING							0 VA				
R1	2X4 RECESSED DIRECT/INDIRECT TROFFER TO MATCH EXISTING	COLUMBIA LIGHTING	LLT24-40MLG-FA A12F-ED-U	120-277V	1	38 W	LED	38 VA	0-10V	CEILING RECESSED	4-1/4" RFD	
RD	2X2 RECESSED DIRECT/INDIRECT TROFFER TO MATCH EXISTING	COLUMBIA LIGHTING	LLT24-40MLG-FA A12F-ED-U	120-277V	1	27 W	LED	27 VA	0-10V	CEILING RECESSED	4-1/4" RFD	
S1	4' LED STRIP LIGHT	COLUMBIA LIGHTING	CSL4-4040	120-277V	1	40 W	LED	40 VA	0-10V	CEILING SURFACE	2-11/16" RFD	
Y1	RECESSED LED DOWN LIGHT EMERGENCY FIXTURE	BARRON LIGHTING GROUP	NFDL1-WB-10L-W H-G2	120-277V	1	11 W	LED	11 VA	NONE	CEILING RECESSED	5" RFD	

MECHANICAL EQUIPMENT SCHEDULE

KEY	DESCRIPTION	VOLTS	PH	LOAD HP, W, A	MOCP/ MFS	FEEDER	DISCONNECT	CIRCUIT	NOTES
TF 1	TRANSFER FAN	115	1	0.5A	15A	2#12, 1#12G, 3/4"C	20A/1P \$TO	TBD	

GENERAL NOTES:

- A. REFER TO MECHANICAL PLANS FOR SPECIFIC EQUIPMENT LOCATIONS AND REQUIREMENTS.
- B. PRIOR TO ROUGH-IN, COORDINATE ALL MECHANICAL EQUIPMENT POWER AND CONNECTION REQUIREMENTS WITH MECHANICAL CONTRACTOR'S FINAL SHOP DRAWINGS.
- C. PROVIDE ALL 120V CONTROL WIRING. REFER TO SPECIFICATIONS FOR FURTHER CONTROL WIRING CLARIFICATION.
- D. EXTERIOR DISCONNECT SWITCHES ARE TO BE PROVIDED AS NEMA 3R EQUIPMENT UNLESS OTHERWISE NOTED.
- E. PROVIDE DUCT DETECTION ON ALL RETURN AIR SYSTEMS OF 2,000 CFM OR GREATER, AND FOR ALL SUPPLY AIR SYSTEMS 15,000 CFM OR GREATER, INCLUDING THOSE SYSTEMS SERVING MULTIPLE FLOORS. PROVIDE ADDITIONAL DUCT DETECTORS AND INSTALL REMOTE INDICATOR LIGHTS AS REQUIRED BY LOCAL AUTHORITY HAVING JURISDICTION.
- F. EC TO PROVIDE HAND/OFF/AUTO STARTERS FOR ALL MOTORS WHEN NOT INDICATED AS TO BE PROVIDED BY THE MECHANICAL CONTRACTOR ON THE MECHANICAL PLANS. SIZE OF STARTER TO BE BASED UPON SIZE OF MOTOR HORSEPOWER INDICATED.

SPECIFIC NOTES:


- 1.

MECHANICAL EQUIPMENT NOTES

A	REFER TO MECHANICAL PLANS FOR SPECIFIC EQUIPMENT LOCATIONS AND REQUIREMENTS.
B	PRIOR TO ROUGH-IN, COORDINATE ALL MECHANICAL EQUIPMENT POWER AND CONNECTION REQUIREMENTS WITH MECHANICAL CONTRACTOR'S FINAL SHOP DRAWINGS.
C	PROVIDE ALL 120V CONTROL WIRING. REFER TO SPECIFICATIONS FOR FURTHER CONTROL WIRING CLARIFICATION.
C	FOR ANY VAV SYSTEM COORDINATE POWER REQUIREMENTS WITH MECHANICAL CONTRACTOR AND PROVIDE 120V CONNECTIONS AT EACH VAV BOX, OR AT CENTRAL CONTROL PANEL LOCATION(S) AS REQUIRED. IF EXACT QUANTITIES AND LOCATIONS FOR CONTROL PANELS ARE NOT KNOWN AT BID TIME, E.C. IS TO INCLUDE ONE 120V CONNECTION AT EACH VAV DEVICE IN THE BASE BID PRICE AND PROVIDE A CREDIT DURING CONSTRUCTION IF LESS CONNECTIONS ARE REQUIRED.
E	EXTERIOR DISCONNECT SWITCHES ARE TO BE PROVIDED AS NEMA 3R EQUIPMENT UNLESS OTHERWISE NOTED.
F	PROVIDE WEATHERPROOF 120 VOLT GFCI RECEPTACLES WITHIN 25' OF ALL ROOFTOP HEATING, VENTILATING, AND AIR CONDITIONING EQUIPMENT. CIRCUIT TO SPARE CIRCUIT ON NEAREST 120V PANELBOARD OR AS INDICATED ON PLANS.
C	PROVIDE DUCT DETECTION ON ALL RETURN AIR SYSTEMS OF 2,000 CFM OR GREATER, AND FOR ALL SUPPLY AIR SYSTEMS 15,000 CFM OR GREATER, INCLUDING THOSE SYSTEMS SERVING MULTIPLE FLOORS. PROVIDE ADDITIONAL DUCT DETECTORS AND INSTALL REMOTE INDICATOR LIGHTS AS REQUIRED BY LOCAL AUTHORITY HAVING JURISDICTION.
F	FOR ANY BOILER MECHANICAL SYSTEM, E.C. IS TO PROVIDE AN EMERGENCY PUSHBUTTON OFF AND ANY CONTROL WIRING REQUIRED. COORDINATE EXACT REQUIREMENTS WITH MECHANICAL CONTRACTOR AND EQUIPMENT PRIOR TO INSTALLATION.
I	EC TO PROVIDE HAND/OFF/AUTO STARTERS FOR ALL MOTORS WHEN NOT INDICATED AS TO BE PROVIDED BY THE MECHANICAL CONTRACTOR ON THE MECHANICAL PLANS. SIZE OF STARTER TO BE BASED UPON SIZE OF MOTOR HORSEPOWER INDICATED.

LIGHTING CONTROL DEVICES

TYPE	DESCRIPTION	PROGRAMMING REQUIREMENTS	DETAILS
STANDALONE CONTROL SYSTEMS			
OS	EXISTING CEILING-MOUNTED OCCUPANCY SENSOR	EXISTING	
OS1	AUTOMATIC ON, AUTOMATIC OFF AFTER 15 MINUTES OF UNOCCUPIED SPACE. LOCAL OFF FOR MAINTENANCE VIA LOCAL KEYED SWITCH (IF APPLICABLE)	CEILING MOUNTED, DUAL TECH, OCCUPANCY SENSOR, LINE VOLTAGE	EXISTING (E) OR REMOVED (R)
OSW	EXISTING WALL-MOUNTED OCCUPANCY SENSOR	EXISTING	
PP1	POWER PACK, 20A, 120-277 UNIVERSAL VOLTAGE TO BE CONTROLLED BY LOW VOLTAGE TOGGLE SWITCH W1		
VSC1	ON VIA LOCAL SWITCH, AUTOMATIC OFF AFTER 15 MINUTES OF UNOCCUPIED SPACE.	CORNER MOUNTED AT 8'-0" AFF. DUAL TECH, OCCUPANCY SENSOR SET TO VACANCY MODE, LOW VOLTAGE	
VSW1	ON VIA LOCAL SWITCH, AUTOMATIC OFF AFTER 15 MINUTES OF UNOCCUPIED SPACE.	WALLSWITCH MOUNT, DUAL TECH, OCCUPANCY SENSOR SET TO VACANCY MODE, SINGLE RELAY	
VSW2	ON VIA LOCAL SWITCH, AUTOMATIC OFF AFTER 15 MINUTES OF UNOCCUPIED SPACE.	WALLSWITCH MOUNT, DUAL TECH, OCCUPANCY SENSOR SET TO VACANCY MODE, DUAL RELAY	
W1	LOW VOLTAGE ON/OFF TOGGLE SWITCH		

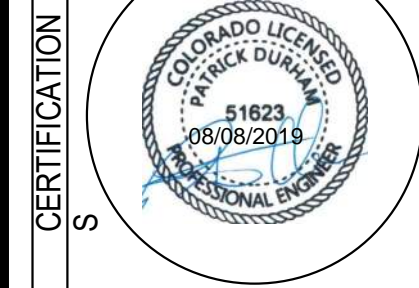

CERTIFICATION

KEY PLAN

MARK	DATE	DESCRIPTION

REVISION NOTES

A/E CON. NO.	GS-08P-JB-D-0017
A/E TASK NO.	EP-GS-P-08-16-JB-7053
CONS. CONTR.	GS-08P-13-JB-D-0032
CONS. WORK	
PRIM A/E	ANDERSON HALLAS ARCHITECT PC
SUB A/E	
CONSTR. CON.	

CONTRACTORS

NAME	BUILDING 56
STREET	6TH STREET
CITY/ST./ZIP	DENVER, COLORADO 80255
BUILDING NO.	BUILDING 56
OTHER BUILDING NOS	
FACILITY CODE	
PROJECT TITLE	BUILDING 56 - NRCS
PROJECT DESCRIPTION	BUILDING 56 - 2ND FLOOR NRCS CONSOLIDATION
PROJECT NO.	EP-GS-P-08-16-JB-7053
GSA PM	BEN REKO
SUBMISSION SUB. DATE	100% CONSTRUCTION DOCUMENTS 7/25/2019

BUILDING

DRAWING TITLE	ELECTRICAL SCHEDULES
FILE NAME	
FLOOR NO.	
DRAWN BY	DATE DRAFTED:
CHECKED BY	SHEET SIZE: 22X34
DRAWING NO.	E 7 00
	DISCIPLINE SHEET TYPE SEQUENCE
	SHEET 38 OF 50

PROJECT




GENERAL SERVICES ADMINISTRATION

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Project Manager
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Principal: Dave Anderson
AIA, LEED AP
daveanderson@andarch.com



CERTIFICATION

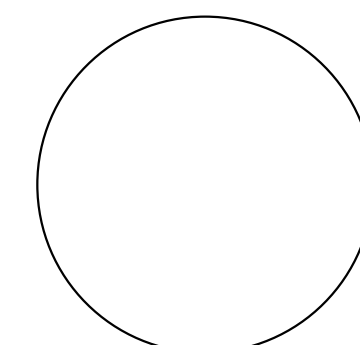KEY PLAN

REVISION NOTES

GRAPHIC SCALE

CONTRACTORS

BUILDING

PROJECT

DRAWING

MARK DATE DESCRIPTION

A/E CON. NO. GS-08P-JB-D-0017

A/E TASK NO. EP-GS-P-08-16-JB-7053

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SUB A/E

CONSTR. CON.

NAME BUILDING 56

STREET 6TH STREET

CITY/ST/ZIP DENVER, COLORADO 80255

BUILDING NO. BUILDING 56

OTHER

BUILDING NOS

FACILITY CODE

PROJECT BUILDING 56 - NRCS

TITLE BUILDING 56 - 2ND FLOOR NRCS

DESCRIPTION CONSOLIDATION

PROJECT NO. EP-GS-P-08-16-JB-7053

GSA PM BEN REKO

SUBMISSION 100% CONSTRUCTION DOCUMENTS

SUB. DATE 7/25/2019

DRAWING TITLE ELECTRICAL PANEL SCHEDULES

FILE NAME

FLOOR NO.

DRAWN BY DATE DRAFTED:

CHECKED BY SHEET SIZE: 22X34

DRAWING NO. E 7 11

DISCIPLINE SHEET TYPE SEQUENCE

SHEET 40 OF 50

EXISTING PANEL '2H11PC' table with columns: CIR. NO, CCT TYPE, LOAD VA, LOAD DESCRIPTION, CIRCUIT BRKR, BUS, CIRCUIT BRKR, LOAD DESCRIPTION, LOAD VA, CCT TYPE, CIR NO. Includes load schedule and notes.

EXISTING PANEL 'L218' table with columns: CIR. NO, CCT TYPE, LOAD VA, LOAD DESCRIPTION, CIRCUIT BRKR, BUS, CIRCUIT BRKR, LOAD DESCRIPTION, LOAD VA, CCT TYPE, CIR NO. Includes load schedule and notes.

EXISTING PANEL '2H11L SEC 1' table with columns: CIR. NO, CCT TYPE, LOAD VA, LOAD DESCRIPTION, CIRCUIT BRKR, BUS, CIRCUIT BRKR, LOAD DESCRIPTION, LOAD VA, CCT TYPE, CIR NO. Includes load schedule and notes.

EXISTING PANEL '2H11L SEC 2' table with columns: CIR. NO, CCT TYPE, LOAD VA, LOAD DESCRIPTION, CIRCUIT BRKR, BUS, CIRCUIT BRKR, LOAD DESCRIPTION, LOAD VA, CCT TYPE, CIR NO. Includes load schedule and notes.




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T:303.985.3300
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MARK	DATE	DESCRIPTION

A/E CON. NO.	GS-08P-JB-D-0017
A/E TASK NO.	EP-GS-P-08-16-JB-7053
CONS. CONTR.	GS-08P-13-JB-D-0032
CONS. WORK	
PRIM A/E	ANDEKLMON HALLAS ARCHITECT PC
SUB A/E	
CONSTR. CON.	
NAME	BUILDING 56
STREET	6TH STREET
CITY/ST./ZIP	DENVER, COLORADO 80255
BUILDING NO.	BUILDING 56
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PROJECT TITLE	BUILDING 56 - NRCS
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PROJECT NO.	EP-GS-P-08-16-JB-7053
GSA PM	BEN REKO
SUBMISSION	100% CD ISSUE
SUB. DATE	07/25/19
DRAWING TITLE	FP NOTES AND DETAILS
FILE NAME	NRCS BLDG 56 17-889.dwg
FLOOR NO.	2ND FLOOR
DRAWN BY	BE DATE DRAFTED 04/15/2019
CHECKED BY	KLM SHEET SIZE 22X34
DRAWING NO.	FP 1 01
	DISCIPLINE SHEET TYPE SEQUENCE
	SHEET 41 OF 50

FIRE SPRINKLER SYSTEM DESIGN INFORMATION

SCOPE: THIS PROJECT IS TO REVISE THE EXISTING AUTOMATIC FIRE SPRINKLER SYSTEM IN THE REMODELED AREA USING QUICK RESPONSE SPRINKLER HEADS.

CODES AND STANDARDS

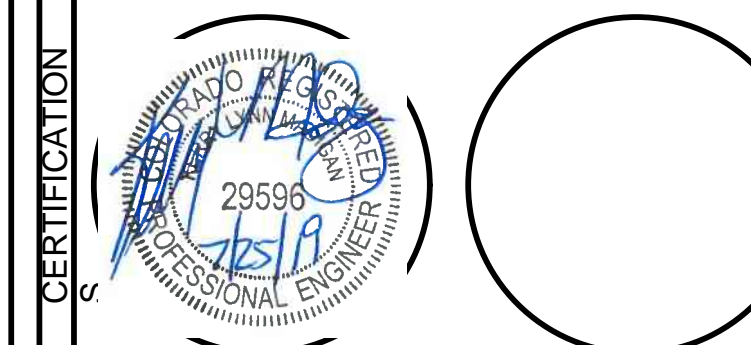- 2015 IBC
- 2015 IFC
- NFPA 13 2016
- 2014 NEC
- GSA PBS P-100

1. THE EXISTING FIRE SPRINKLER SYSTEM (UPRIGHTS & PENDENTS) SHALL BE REVISED TO PROVIDE COVERAGE FOR THE REMODELED AREAS. NEW SPRINKLER DESIGN AND INSTALLATION WILL BE IN ACCORDANCE WITH NFPA 13 (2016 ED.) AND GSA REQUIREMENTS. GENERAL SERVICES ADMINISTRATION REPRESENTATIVE IS THE AUTHORITY HAVING JURISDICTION.

2. THE INTEGRITY OF THE EXISTING FIRE SUPPRESSION SYSTEM SHALL BE MAINTAINED DURING CONSTRUCTION. PROTECT EXISTING EQUIPMENT AND PIPING.

3. THE CONTRACTOR SHALL PROVIDE FIRE WATCH PER THE GUIDELINES FOR "GSA FIRE WATCH" AND SHALL MEET ALL FIRE WATCH REQUIREMENTS.

4. THE SYSTEM SHALL BE TESTED PER GSA PBS P-100 TECHNICAL GUIDE F.11.07.0494.

5. SPRINKLER DESIGN SHOWN PROVIDES LIGHT HAZARD DENSITY PROTECTION FOR ALL FINISHED AREAS.

6. NEW MECHANICAL TEES ARE NOT ALLOWED ON THIS PROJECT.

7. ALL STEEL PIPING 2" AND SMALLER SHALL BE SCHEDULE 40 AND SHALL BE THREADED. ALL STEEL PIPE LARGER THEN 2" SHALL BE MINIMUM SCHEDULE 40. PIPING LESS THEN SCHEDULE 40 SHALL BE ROLL GROOVED. ALL PIPING TO MATCH EXISTING INCLUDING, SIZES, PIPE SCHEDULES, RISER NIPPLE, ETC.

8. ALL DASHED PIPE IS EXISTING.

9. ALL SPRINKLER HEAD COUNTS TO BE VERIFIED BY SPRINKLER CONTRACTOR. ALL SPRINKLER HEAD AND SPRINKLER PIPE ELEVATIONS SHALL BE VERIFIED IN FIELD.

10. ALL HEADS IN FINISHED CEILING (GY OR ACT) SHALL BE REPLACED WITH QUICK RESPONSE CONCEALED SPRINKLER.

11. SPRINKLER LOCATIONS SHALL BE MODIFIED IF POSSIBLE TO AVOID CEILING OBSTRUCTIONS (E.G. LIGHTS) SO THAT TWO-PIECE ESCUTCHEONS ARE NOT REQUIRED.

12. NO MORE THEN 2 HEADS OFF 1" OUTLET.

13. CONTRACTOR TO VERIFY ALL BRANCHLINE AND MAIN PIPING SIZES.

14. FIRE ALARM PANEL IS LOCATED IN FIRE COMMAND CONTROL CENTER LOCATED ON MAIN LEVEL.

15. FIRE ALARM PANEL IS EST3.

17. EXISTING SYSTEM IS A PIPE SCHEDULED SYSTEM. UPRIGHTS ARE SPACED AT 130 MAX.

19. 18" CLEARANCE SHALL BE MAINTAINED FROM SPRINKLER HEADS TO ALL FILING SYSTEMS.


REMODEL LEGEND

- EXISTING SPRINKLER HEAD LOCATION
- A ADDED SPRINKLER
- R RELOCATED SPRINKLER
- E E EXISTING TO REMAIN
- P PLUGGED OUTLET


FIRE PROTECTION SYMBOL LEGEND

⊗	SYSTEM RISER	P	PLUG OUTLET
○	PIPE RISE	▲xxx'	HEAD ELEVATION
●	PIPE DROP	⊗	WELD PIPE FAB. TAG
▶	PIPE REDUCER	⊗	PIPE FAB. TAG
◻	PIPE CAP	⊕	4-WAY EARTHQUAKE BRACE
◻	PIPE PLUG	↓	2-WAY EARTHQUAKE BRACE
⌑	PIPE COUPLING	⌑	FIRE DEPT CONNECTION
⊗	FIRE HOSE CABINET	⊗15	HORN/STROBE # INDICATES CANDELA
⊗	AUXILARY DRAIN	A	ADD SPRINKLER HEAD
⊗	CONTROL VALVE	R	RELOCATED SPRINKLER HEAD
⊗	INSP. TEST CONN.	P	PLUGGED OUTLET
⊗	PIPE HANGER	▬	NEW PIPE
⊗	HYDRAULIC NODE	▬	EXISTING PIPE
⊗	PIPE ELEVATION		
⊗	SHEET NOTE		

PLAN VIEW

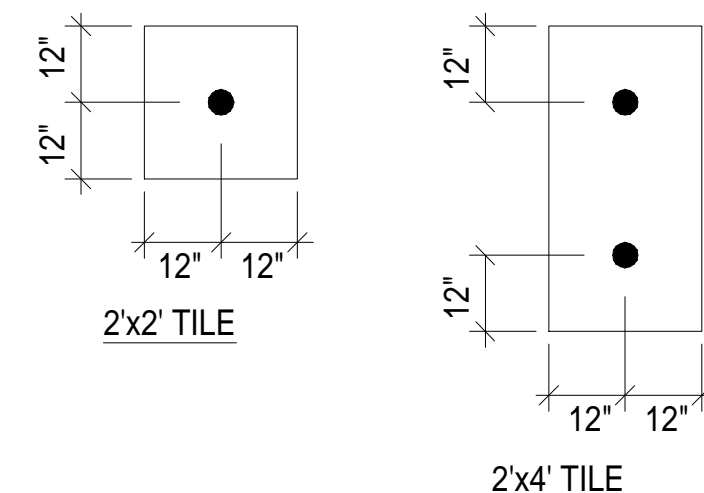

SPRINKLER HEAD POSITION AT ACOUSTIC CEILING TILES

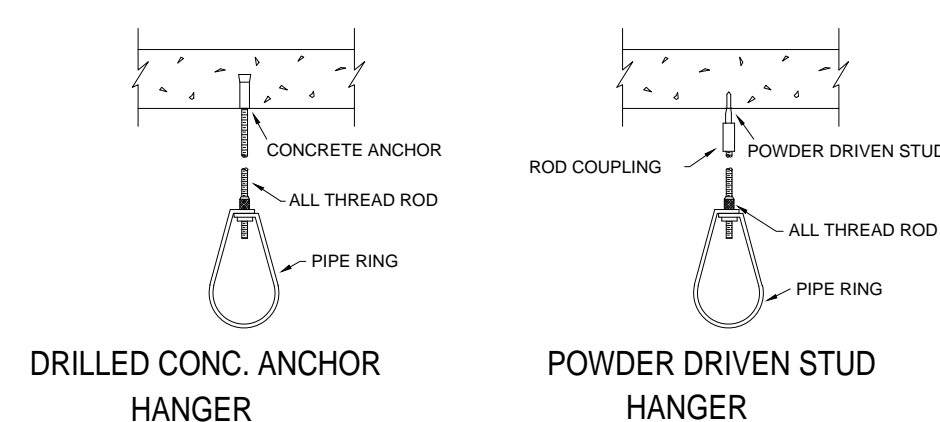

HANGER DETAILS

FIRE SPRINKLER LEGEND


BID NOTE:
THESE DRAWINGS ARE DIAGRAMMATIC ONLY. THE AWARDED CONTRACTOR SHALL BE RESPONSIBLE FOR PRODUCTION OF ALL SUBMITTAL DOCUMENTS, HYDRAULIC CALCULATIONS, BATTERY CALCULATIONS, VOLTAGE DROPS, CONDUIT FILLS AND OBTAINING ALL REQUIRED PERMITS AND APPROVALS. THE AWARDED CONTRACTOR SHALL BE RESPONSIBLE FOR ANY REQUIRED OFFSETS OF SPRINKLER PIPING AS NEEDED FOR ONSITE COORDINATION WITH OTHER TRADES.

100% CONSTRUCTION DOCUMENTS

BUILDING 56 - 2ND FLOOR
NRCS CONSOLIDATION
-- FOR CONSTRUCTION --

REMODEL LEGEND

- EXISTING SPRINKLER HEAD LOCATION
- ⊙ A ADDED SPRINKLER
- ⊙ R RELOCATED SPRINKLER
- ⊙ E + E EXISTING TO REMAIN
- ⊙ P PLUGGED OUTLET

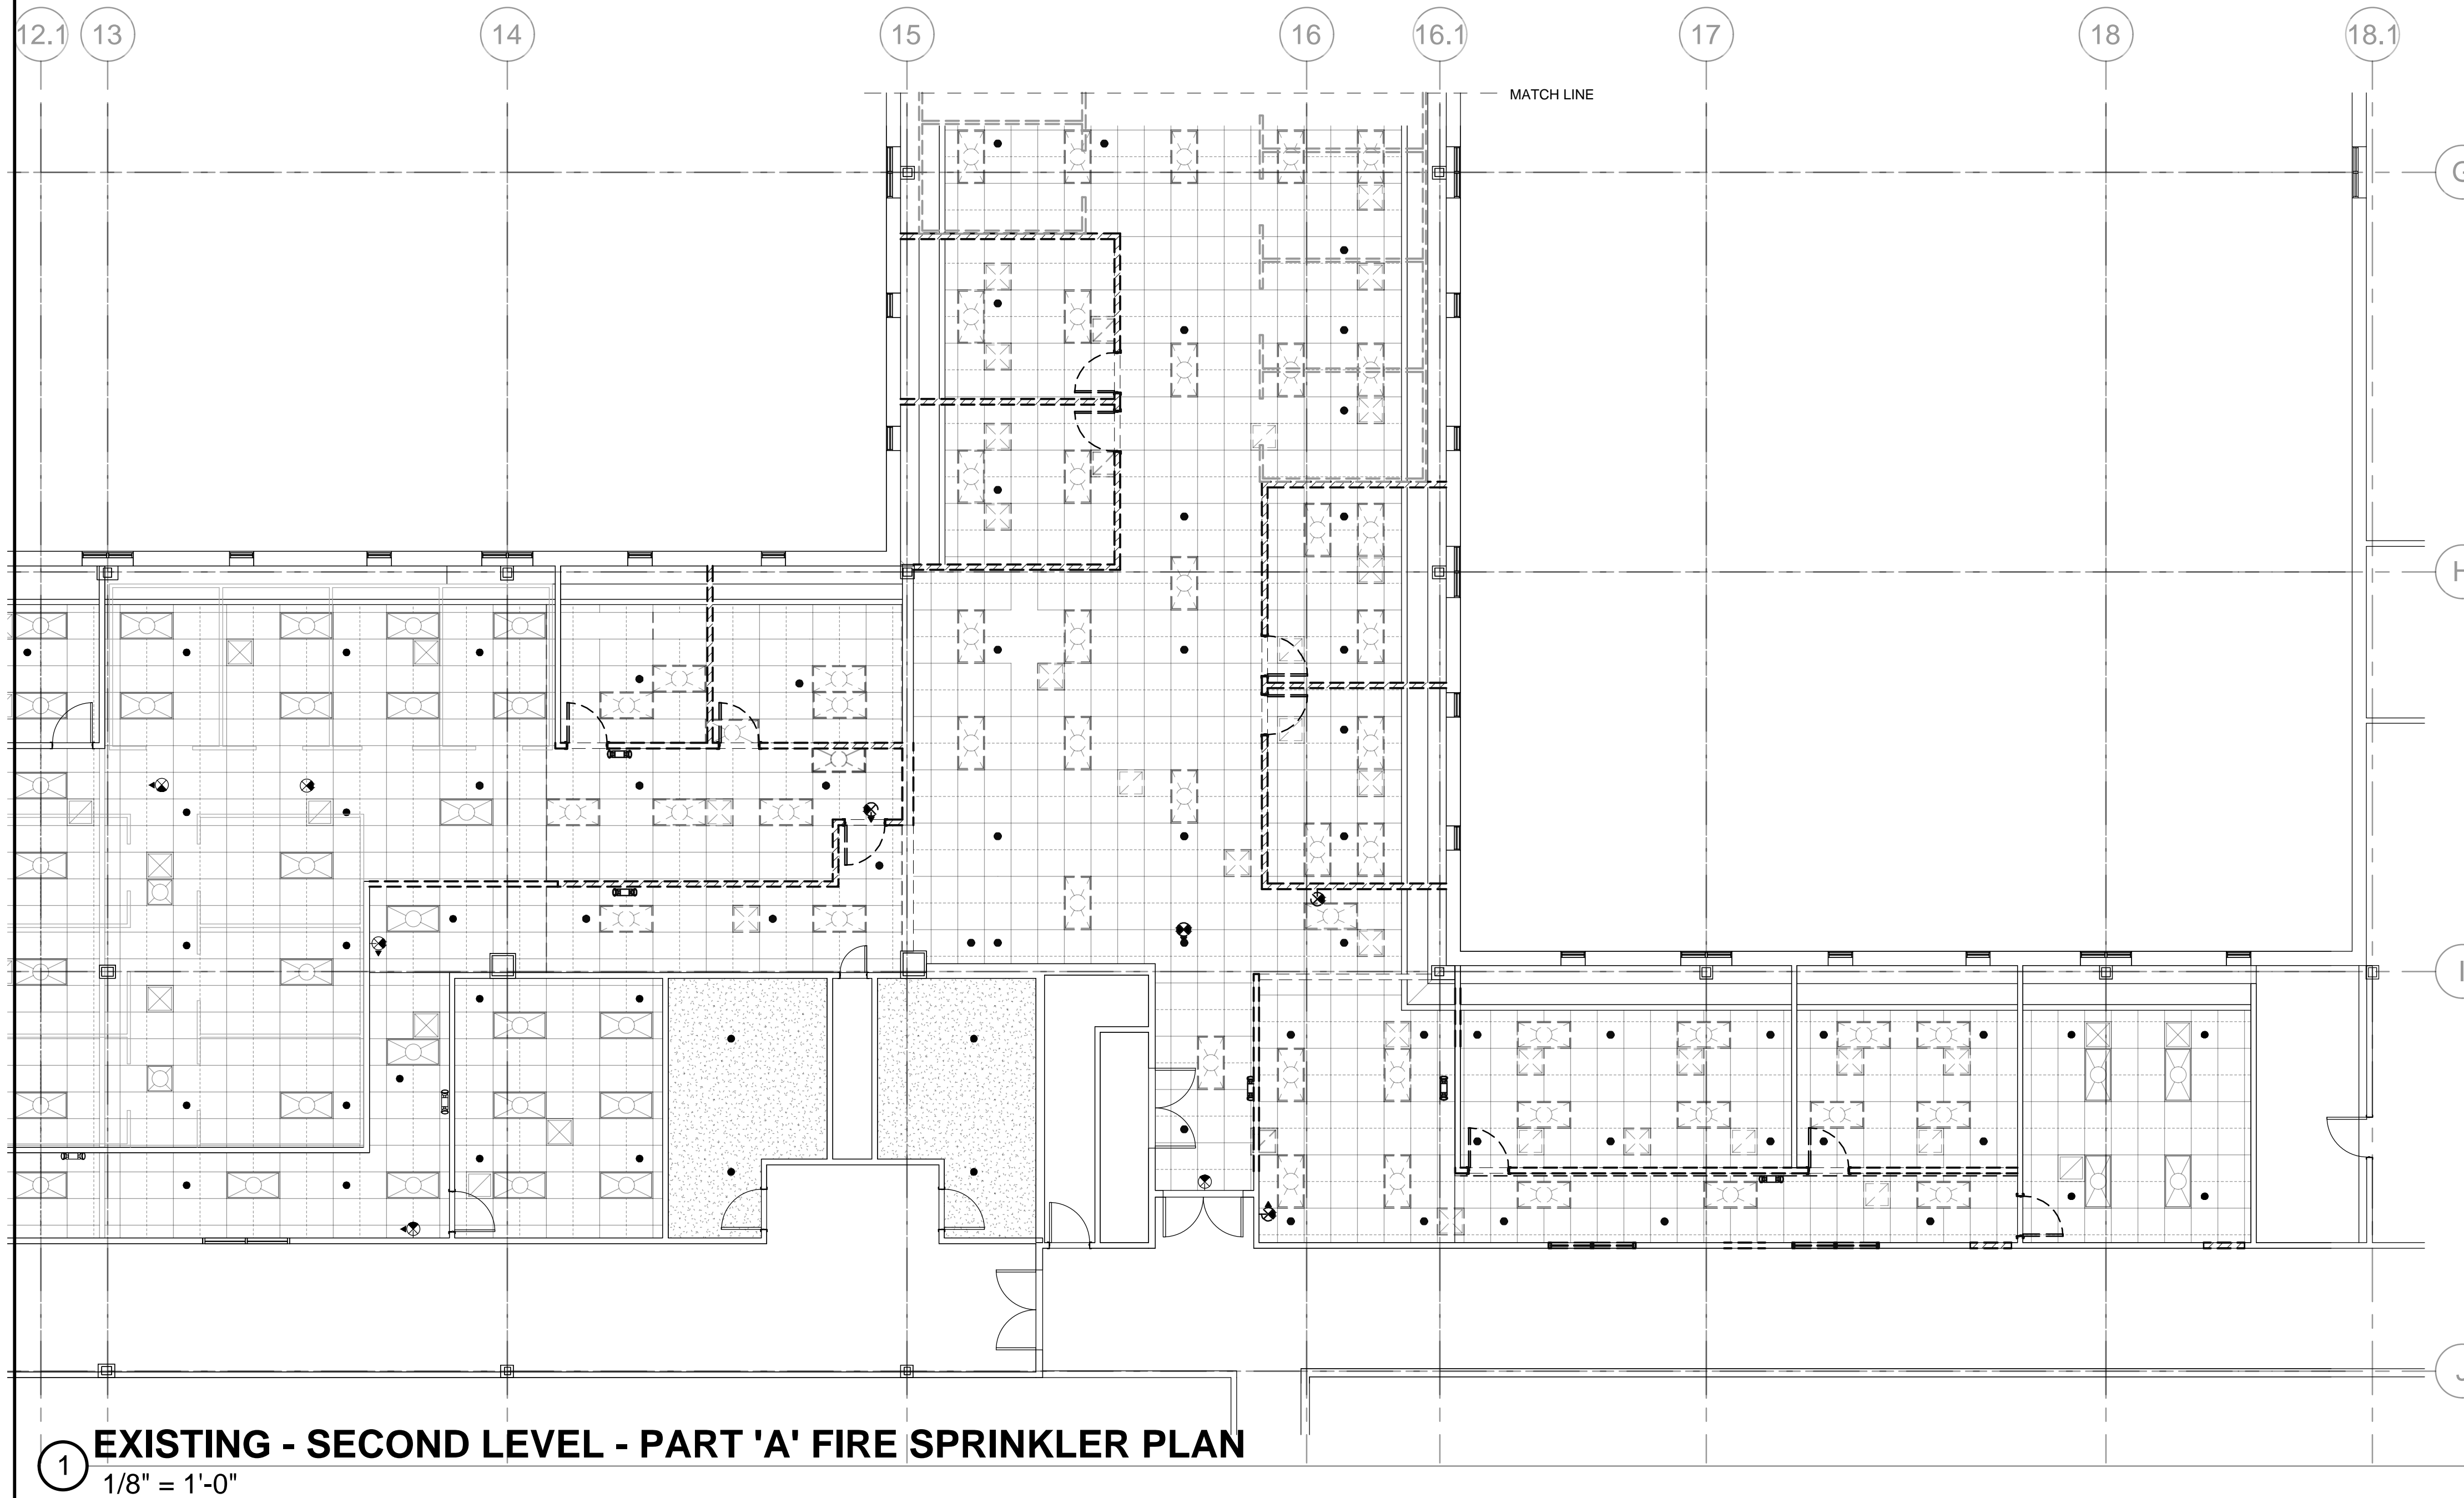

1 EXISTING - SECOND LEVEL - PART 'A' FIRE SPRINKLER PLAN
1/8" = 1'-0"


GENERAL PLAN NOTES

1. SPRINKLER HEADS SHALL BE RELOCATED OR ADDED TO PROVIDED PROPER COVERAGE
2. PLEASE REFER TO MECHANICAL AND ELECTRICAL SHEETS FOR FIXTURE DEMOLITION.
3. FIRE ALARM DEVICES SHALL BE RELOCATED OR ADDED TO PROVIDE PROPER COVERAGE

100% CONSTRUCTION DOCUMENTS
*BUILDING 56 - 2ND FLOOR
NRCS CONSOLIDATION
-- FOR CONSTRUCTION --*

	GENERAL SERVICES ADMINISTRATION <small>Ben Reko Project Manager D.F.C. BUILDING 41 - SUITE 246 DENVER, COLORADO - 80255 303.236.0855 Phone 220.412.2812 Cell benjamin.reko@gsa.gov</small>																																				
	 ANDERSON HALLAS ARCHITECTS, PC 715 FOURTEENTH STREET GOLDEN, COLORADO 80401 (303) 278-4378 FAX (303) 278-0521 Principal: Dave Anderson AIA, LEED AP daveanderson@andarch.com																																				
 VERITAS FIRE ENGINEERING, INC. 12364 W Alameda PKWY #135 LAKEWOOD, CO 80228 T:303.985.3300 F:303.985.5594 VERITASFIRE.COM																																					
CERTIFICATION																																					
KEY PLAN																																					
REVISION NOTES	<table border="1" style="width: 100%; border-collapse: collapse;"> <thead> <tr> <th style="width: 10%;">MARK</th> <th style="width: 15%;">DATE</th> <th>DESCRIPTION</th> </tr> </thead> <tbody> <tr><td> </td><td> </td><td> </td></tr> <tr><td> </td><td> </td><td> </td></tr> <tr><td> </td><td> </td><td> </td></tr> <tr><td> </td><td> </td><td> </td></tr> <tr><td> </td><td> </td><td> </td></tr> <tr><td> </td><td> </td><td> </td></tr> <tr><td> </td><td> </td><td> </td></tr> <tr><td> </td><td> </td><td> </td></tr> <tr><td> </td><td> </td><td> </td></tr> <tr><td> </td><td> </td><td> </td></tr> <tr><td> </td><td> </td><td> </td></tr> </tbody> </table>	MARK	DATE	DESCRIPTION																																	
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SHEET	42 OF 50																																				

4/18/2019 12:20:01 PM

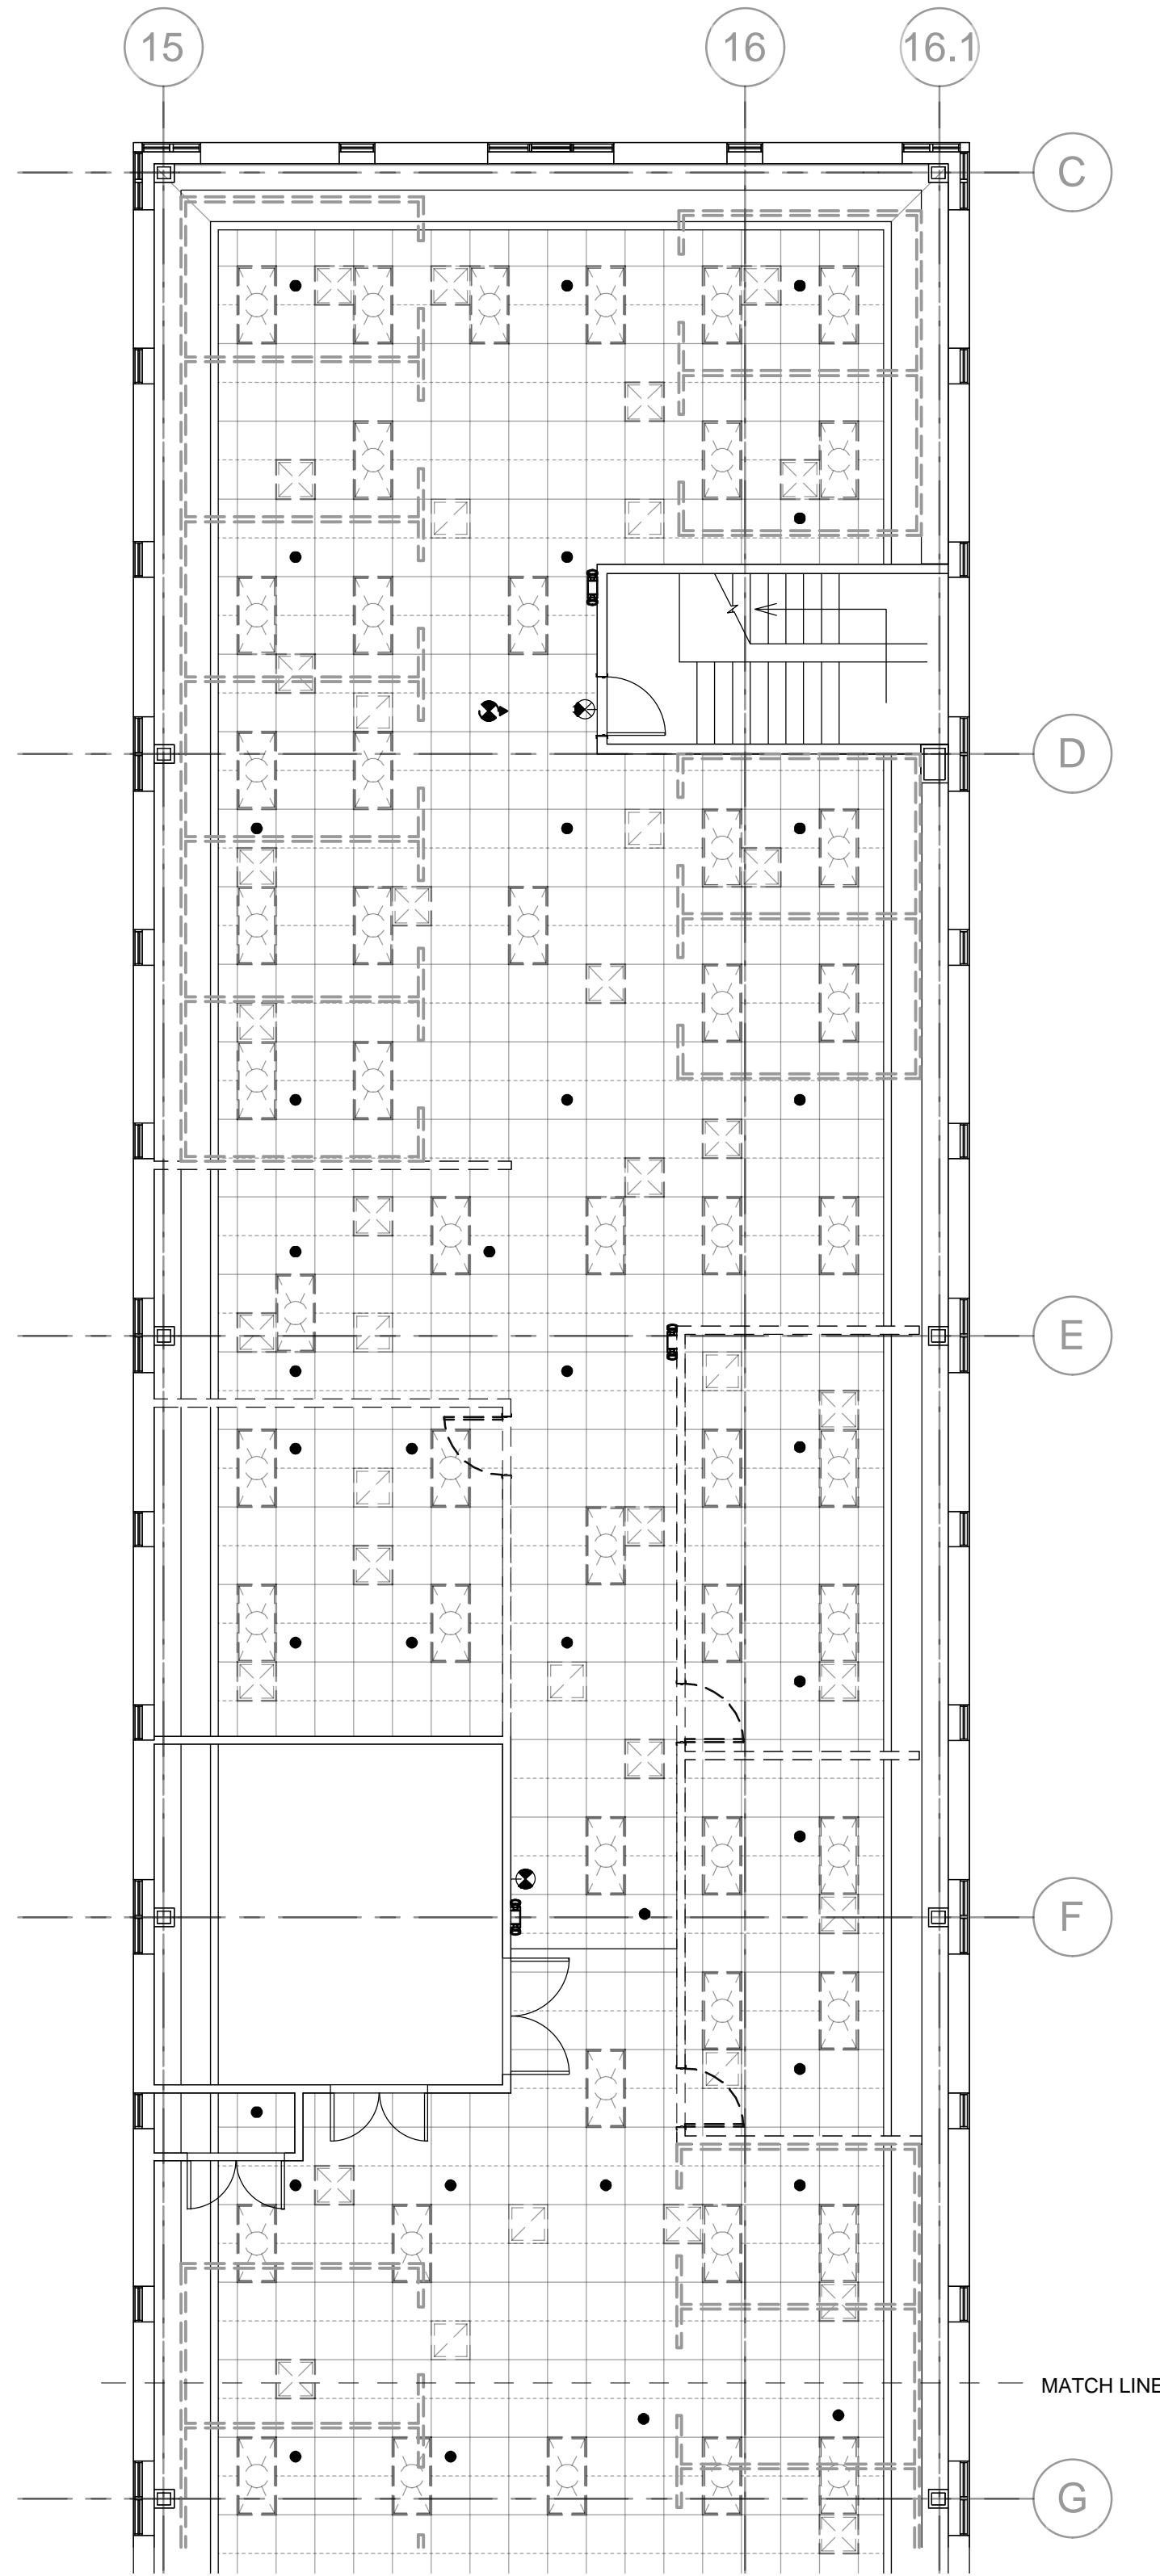

REMODEL LEGEND

- EXISTING SPRINKLER HEAD LOCATION
- ⦿ A ADDED SPRINKLER
- ⦿ R RELOCATED SPRINKLER
- ⦿ E EXISTING TO REMAIN
- P PLUGGED OUTLET

① **EXISTING - SECOND LEVEL - PART 'B' FIRE SPRINKLER PLAN**
 1/8" = 1'-0"

GENERAL PLAN NOTES

1. SPRINKLER HEADS SHALL BE RELOCATED OR ADDED TO PROVIDED PROPER COVERAGE
2. PLEASE REFER TO MECHANICAL AND ELECTRICAL SHEETS FOR FIXTURE DEMOLITION.
3. FIRE ALARM DEVICES SHALL BE RELOCATED OR ADDED TO PROVIDE PROPER COVERAGE

100% CONSTRUCTION DOCUMENTS
BUILDING 56 - 2ND FLOOR
NRCS CONSOLIDATION
-- FOR CONSTRUCTION --


GSA GENERAL SERVICES ADMINISTRATION
 Project Manager: **Ben Reko**
 D.F.C. BUILDING 41 - SUITE 246
 DENVER, COLORADO - 80255
 303.236.0855 Phone | 230.412.2812 Cell
 benjamin.reko@gsa.gov

ANDERSON HALLAS ARCHITECTS, PC
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 (303) 278-4378
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 Principal: Dave Anderson
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VERITAS
 FIRE ENGINEERING, INC.
 12364 W Alameda PKWY #135
 LAKEWOOD, CO 80228
 T:303.985.3300
 F:303.985.5594
 VERITASFIRE.COM

CERTIFICATION

(Professional Engineer Seal)
 29596
 PROFESSIONAL ENGINEER

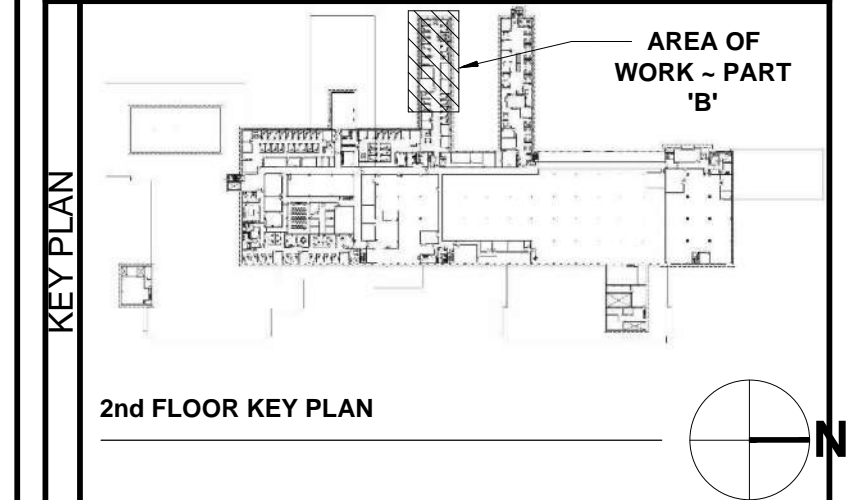

MARK	DATE	DESCRIPTION

CONTRACTORS GRAPHIC SCALE


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A/E TASK NO.	EP-GS-P-08-16-JB-7053
CONS. CONTR.	GS-08P-13-JB-D-0032
CONS. WORK	
PRIM A/E	ANDEKLMON HALLAS ARCHITECT PC
SUB A/E	
CONSTR. CON.	

NAME	BUILDING 56
STREET	6TH STREET
CITY/ST./ZIP	DENVER, COLORADO 80255
BUILDING NO.	BUILDING 56
OTHER BUILDING Nos	
FACILITY CODEs	

PROJECT TITLE	BUILDING 56 - NRCS
PROJECT DESCRIPTION	BUILDING 56 - 2ND FLOOR NRCS CONSOLIDATION
PROJECT NO.	EP-GS-P-08-16-JB-7053
GSA PM	BEN REKO
SUBMISSION	100% CD ISSUE
SUB. DATE	07/25/19
DRAWING TITLE	FIRE SPRINKLER DEMO PLAN - PART 'A'
FILE NAME	NRCS BLDG 56 17-889.dwg
FLOOR NO.	2ND FLOOR
DRAWN BY	BE DATE DRAFTED 04/15/2019
CHECKED BY	KLM SHEET SIZE 22X34
DRAWING NO.	FP 1 03
DISCIPLINE	SHEET TYPE SEQUENCE
SHEET	43 OF 50

REMODEL LEGEND

- EXISTING SPRINKLER HEAD LOCATION
- ⦿ A ADDED SPRINKLER
- ⦿ R RELOCATED SPRINKLER
- ⦿ E E EXISTING TO REMAIN
- ✱ P PLUGGED OUTLET

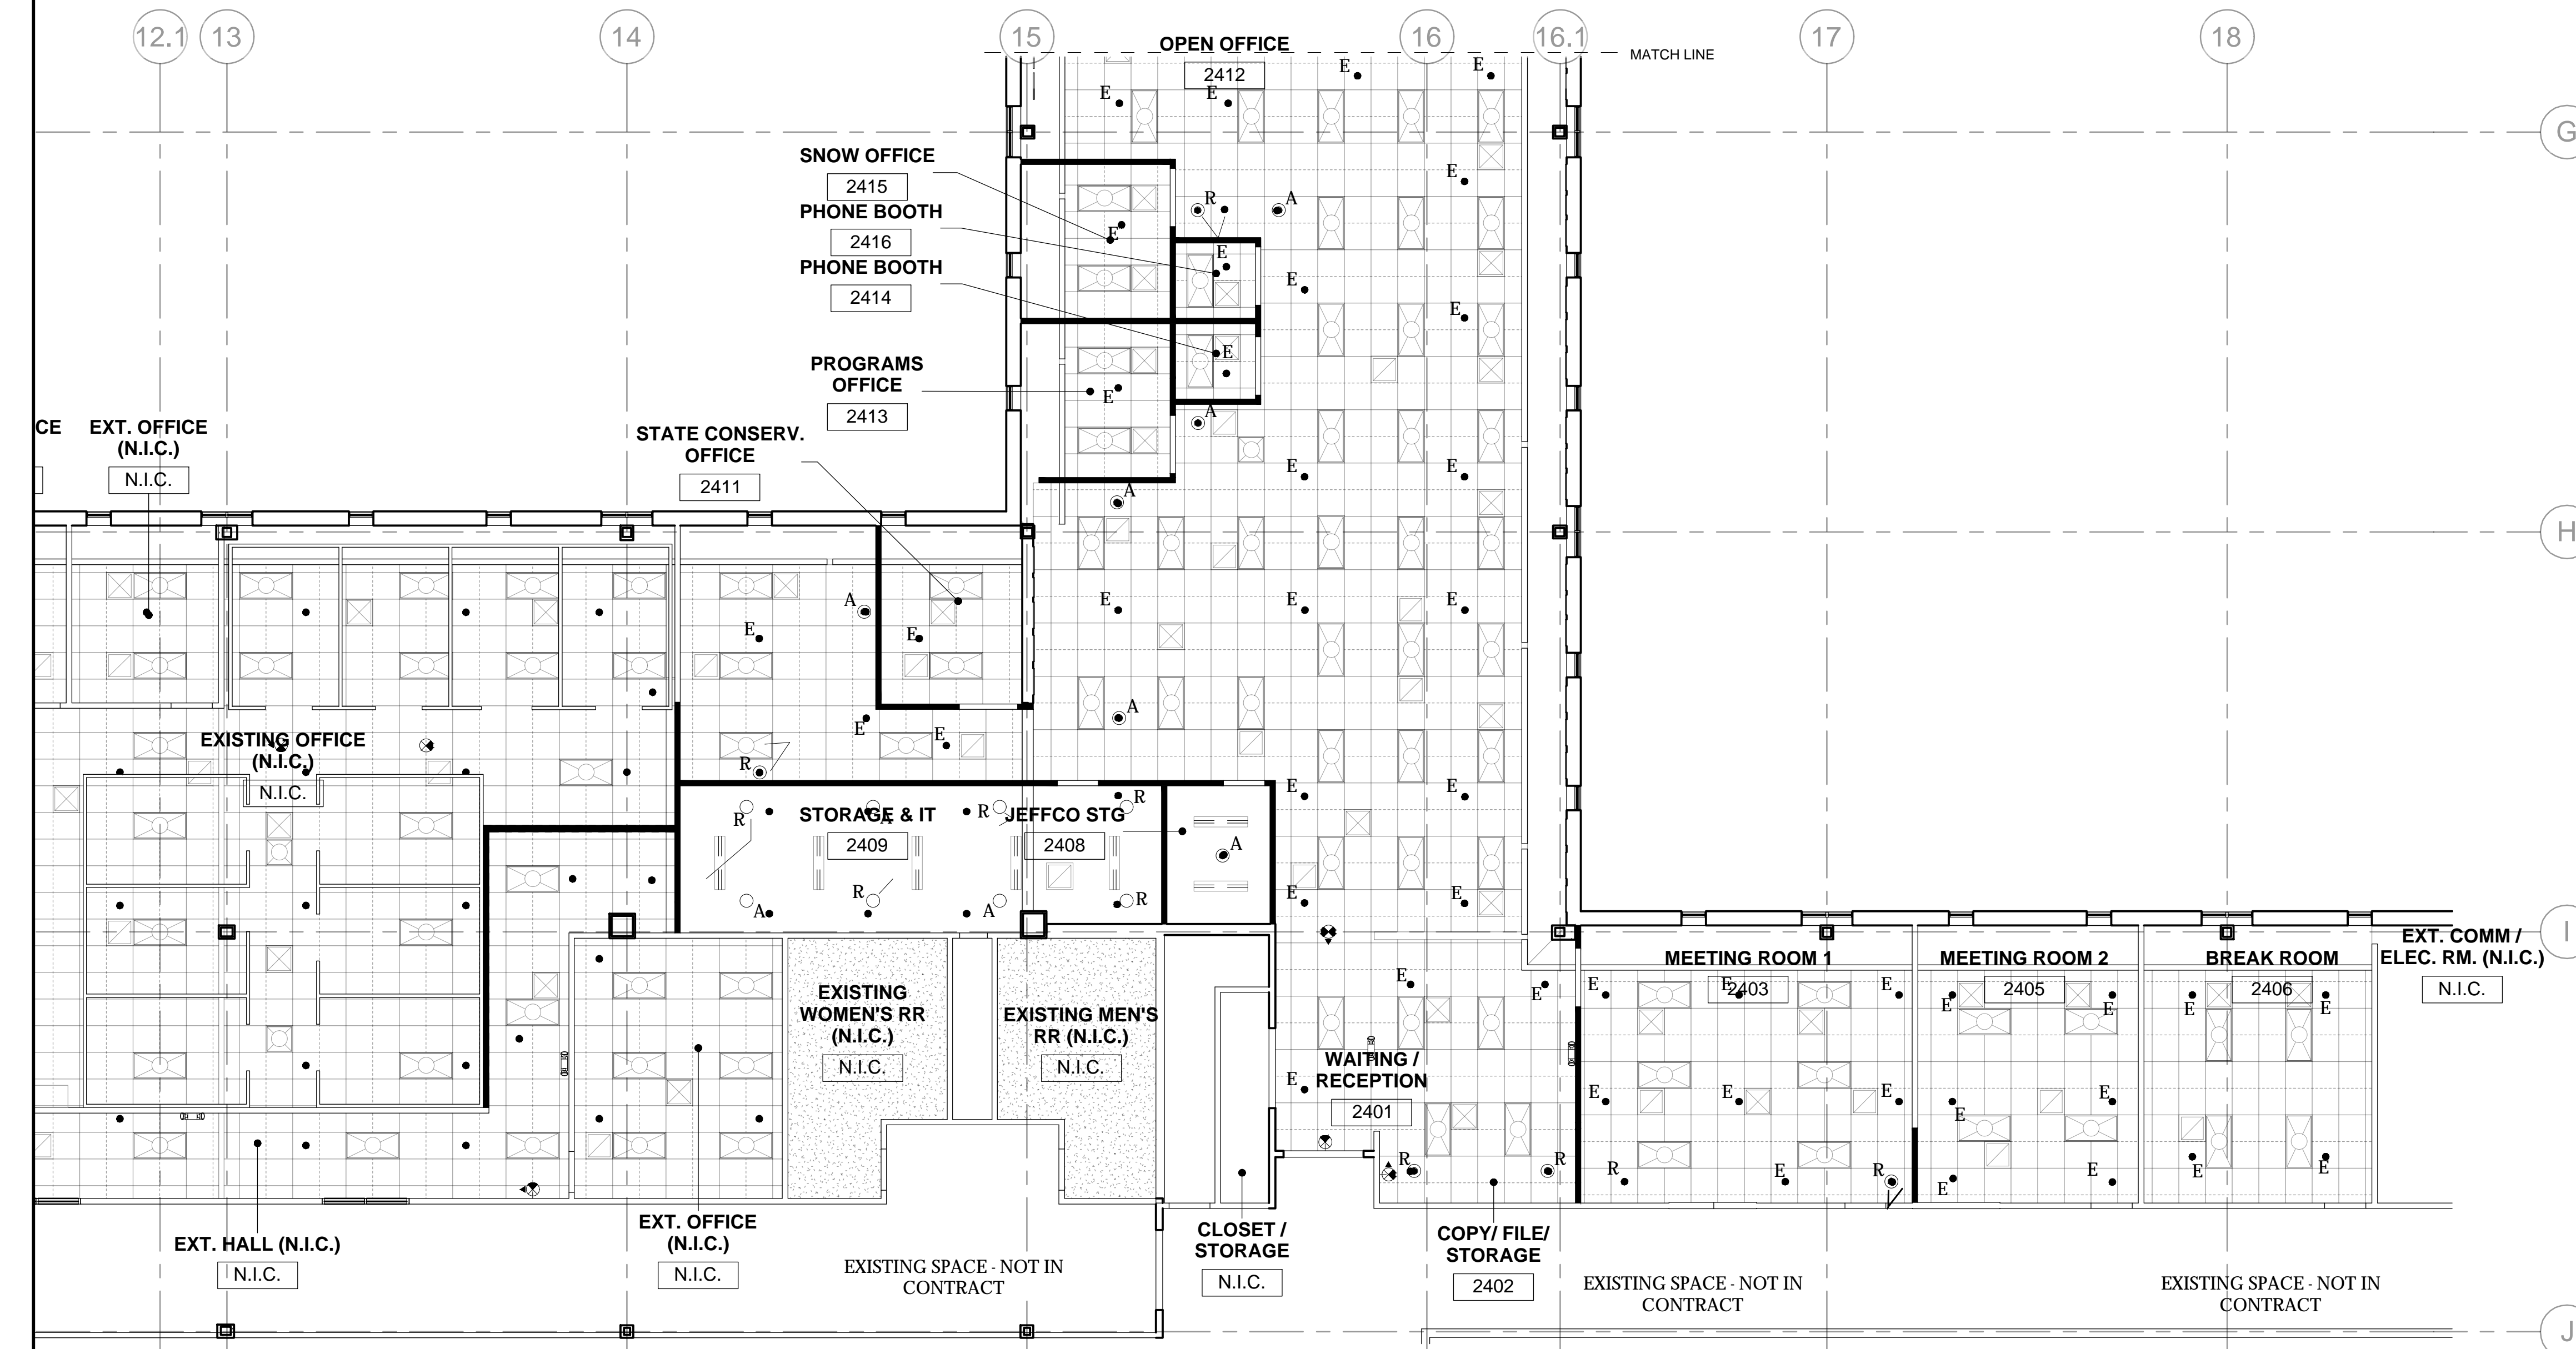


1 SECOND LEVEL - PART 'A' FIRE SPRINKLER PLAN
 1/8" = 1'-0"

GENERAL PLAN NOTES


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DRAWING NO.		FP 1 04
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		SHEET 44 OF 50

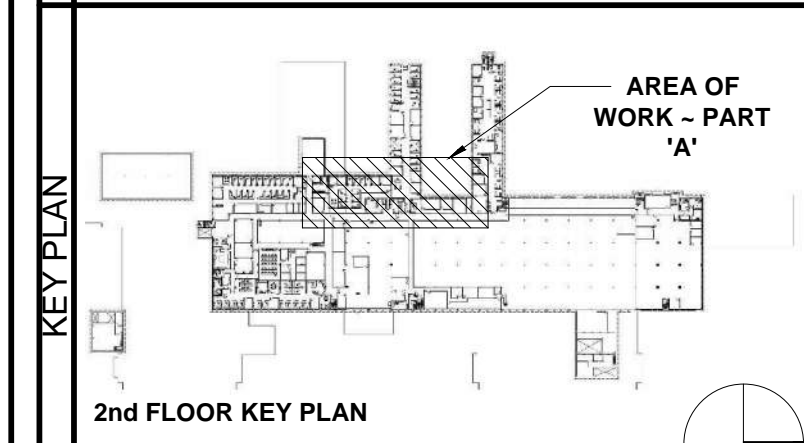

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	GENERAL SERVICES ADMINISTRATION <small>Ben Reko Project Manager D.F.C. BUILDING 41 - SUITE 246 DENVER, COLORADO - 80255 303.236.0855 Phone 720.412.2812 Cell benjamin.reko@gsa.gov</small>																																										
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FIRE ALARM SYSTEM DESIGN INFORMATION






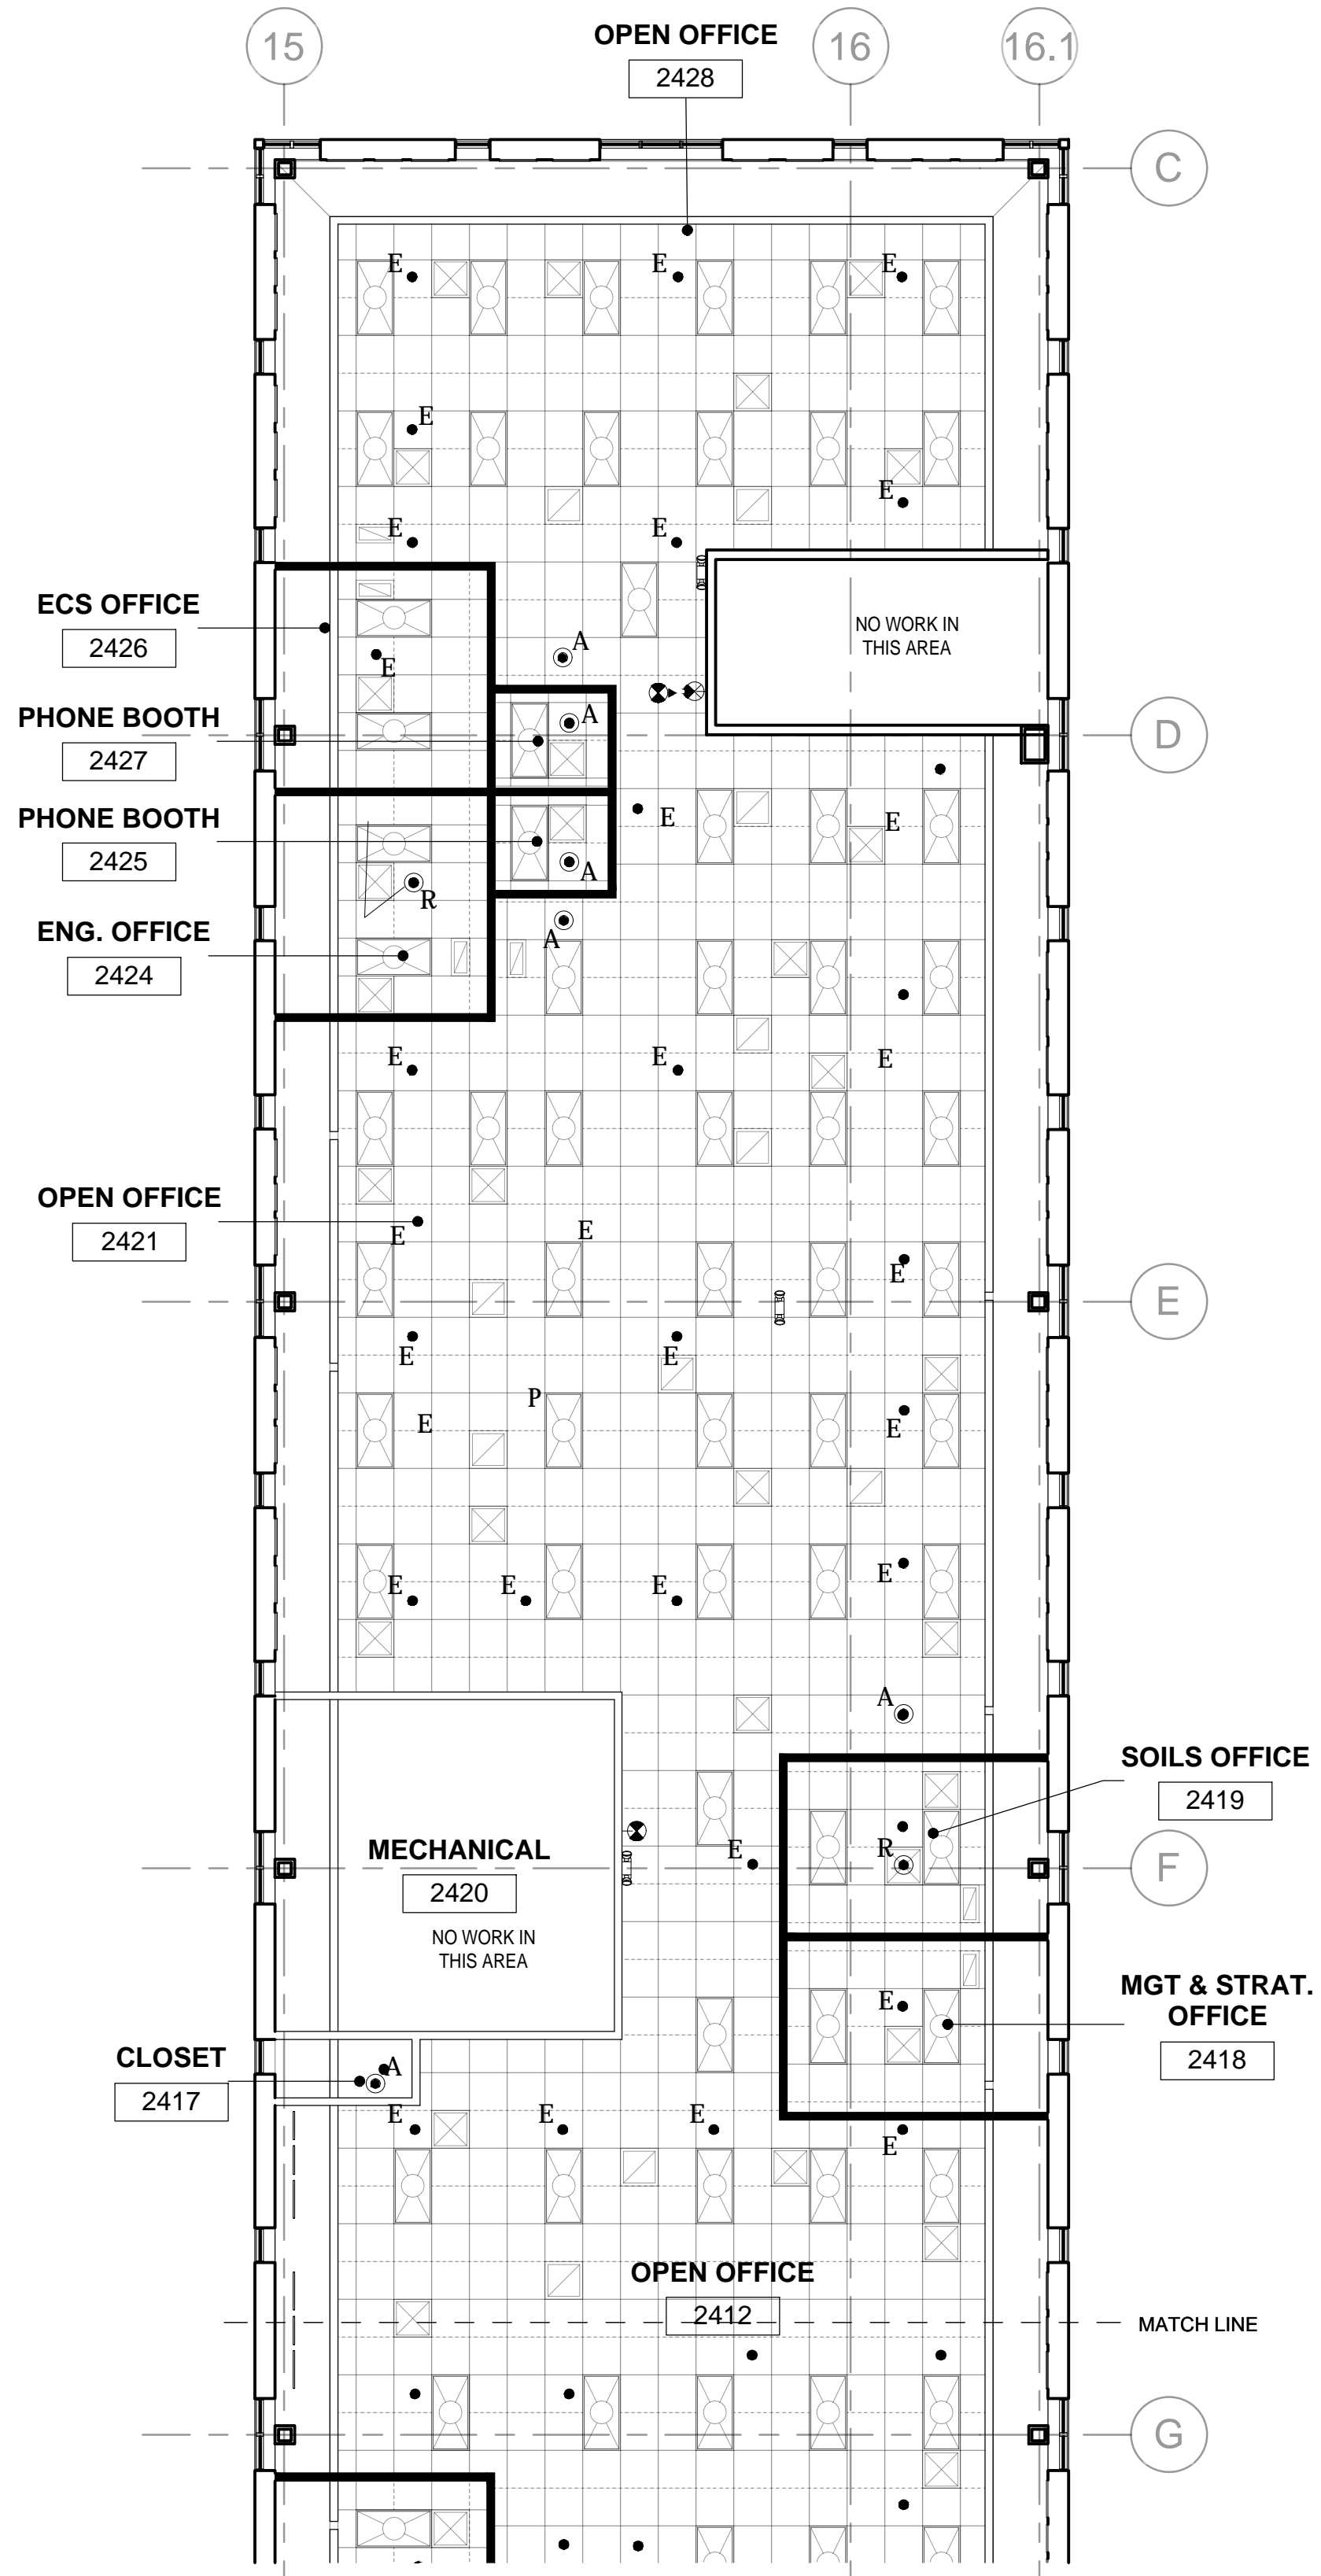








SCOPE: THIS PROJECT IS TO REVISE AND EXTEND A FIRE DETECTION AND NOTIFICATION SYSTEM IN THE REMODELED AREA.

CODES AND STANDARDS

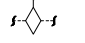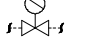
- 2015 IBC
- NFPA 72 2013
- 2014 NEC
- GSA PBS P-100

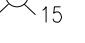GENERAL NOTES

1. TEMPORARILY RE-ROUTE WIRING AND PROTECT AND SUPPORT EXISTING EQUIPMENT DURING CONSTRUCTION OPERATIONS TO MAINTAIN SYSTEM OPERABILITY.
2. ALL NEW FIRE CABLING THROUGH THE PROJECT SPACE IS TO BE PLACED IN CONDUIT. NO RUNS OF MORE THAN FOUR FEET OF FLEX CONDUIT ARE ALLOWED. ALL FIRE ALARM CONDUITS SHALL BE IDENTIFIED BY RED MARKINGS EVERY 20 FEET. ALL FIRE ALARM JUNCTION BOXES SHALL BE IDENTIFIED BY RED JUNCTION COVER PLATES.
3. NEW SPEAKER/STROBES OR STROBES SHALL MATCH EXISTING BUILDING DEVICES.
4. GENERAL SERVICES ADMINISTRATION REPRESENTATIVE SHALL BE THE AUTHORITY HAVING JURISDICTION.
5. NOTIFICATION APPLIANCE CIRCUITS SHALL HAVE A MINIMUM OF 25% SPARE CAPACITY.
6. FIRE ALARM WORK SHALL FOLLOW THE ARCHITECTURAL PHASING AS SET OUT ON SHEET NRCS BLDG 56 17-889X.
7. PREVENT NUISANCE ALARMS DURING CONSTRUCTION.
8. THE CONTRACTOR SHALL PROVIDE FIRE WATCH PER THE GUIDELINES FOR "GSA FIRE WATCH" AND SHALL MEET ALL FIRE WATCH REQUIREMENTS.
9. IF ADDITIONAL POWER SUPPLIES ARE REQUIRED, LOCATION SHALL BE APPROVED BY THE CONTRACTING OFFICER.
10. FIRE ALARM CONTROL IS LOCATED IN THE FIRE COMMAND CONTROL CENTER LOCATED ON THE MAIN LEVEL ROOM 101.
11. EXISTING FIRE ALARM PANEL IS A SIMPLEX 4100.

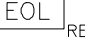SYMBOL	DESCRIPTION
	FIRE ALARM CONTROL PANEL
	FIRE ALARM ANNUNCIATOR
	SMOKE DETECTOR (PHOTOELECTRIC)
	PULL STATION
	VALVE WITH TAMPER SWITCH
	HORN WITH STROBE (NUMBER INDICATES CANDELA) (C INDICATES CEILING MOUNT) STROBE (NUMBER INDICATES CANDELA)
	SPEAKER WITH STROBE (NUMBER INDICATES CANDELA) (C INDICATES CEILING MOUNT-NUMBER WITH X/Xw INDICATES TAPPED WATTAGE)
	CEILING MOUNT SPEAKER (NUMBER INDICATES TAPPED WATTAGE: W-WALL MOUNT) END OF LINE RESISTOR
	FIRE DEPARTMENT CONNECTION
	DUCT DETECTOR
	REMOTE TEST/RESET STATION
	REMOTE INDICATING LIGHT
	HEAT DETECTOR FIXED TEMP
	CEILING HEIGHT

R-RELOCATE
E-EXISTING TO REMAIN
A-NEW

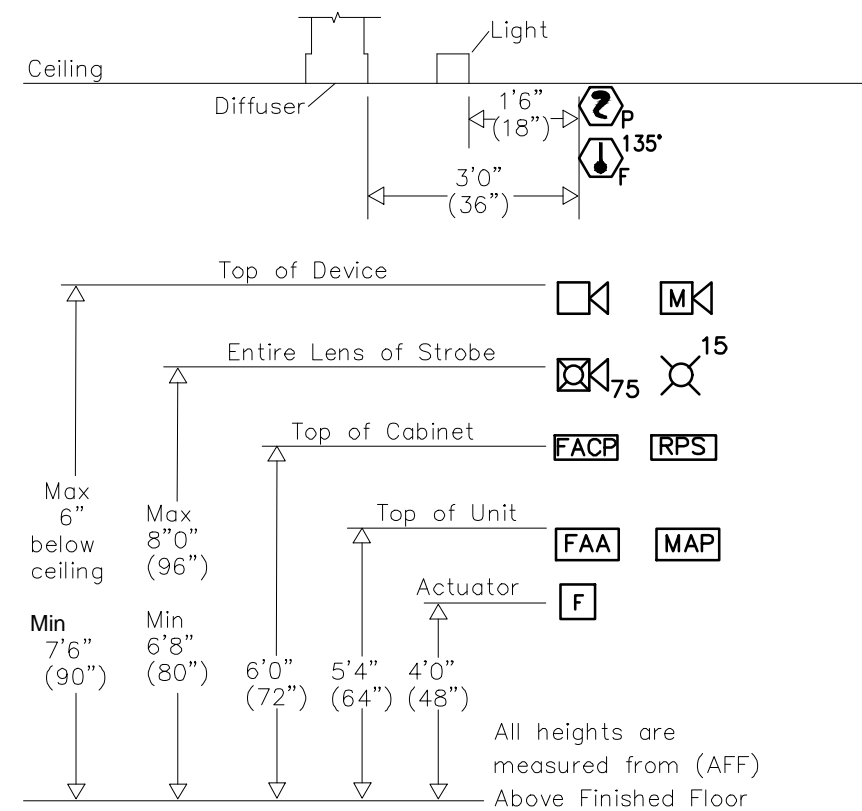

TYPICAL DEVICE MOUNTING HEIGHTS

DESCRIPTION	CLASS	TYPE
SIGNALING LINE CIRCUITS	B	2 #16 AWG FPLP
HORN/STROBE CIRCUITS	A	2 #14 AWG FPLP
INITIATING DEVICE CIRCUITS	B	2 #18 AWG FPLP
SBUS (RS485) CIRCUIT		4 #16 AWG FPLP
REMOTE TEST STATION		4 #18 AWG FPLP

Wire is to be run exposed above 8 feet AFF, power limited

WIRE CHART


BID NOTE:
THESE DRAWINGS ARE DIAGRAMMATIC ONLY. THE AWARDED CONTRACTOR SHALL BE RESPONSIBLE FOR PRODUCTION OF ALL SUBMITTAL DOCUMENTS, HYDRAULIC CALCULATIONS, BATTERY CALCULATIONS, VOLTAGE DROPS, CONDUIT FILLS AND OBTAINING ALL REQUIRED PERMITS AND APPROVALS. THE AWARDED CONTRACTOR SHALL BE RESPONSIBLE FOR ANY REQUIRED OFFSETS OF SPRINKLER PIPING AS NEEDED FOR ONSITE COORDINATION WITH OTHER TRADES.

100% CONSTRUCTION DOCUMENTS

BUILDING 56 - 2ND FLOOR

NRCS CONSOLIDATION

-- FOR CONSTRUCTION --



GENERAL SERVICES ADMINISTRATION

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


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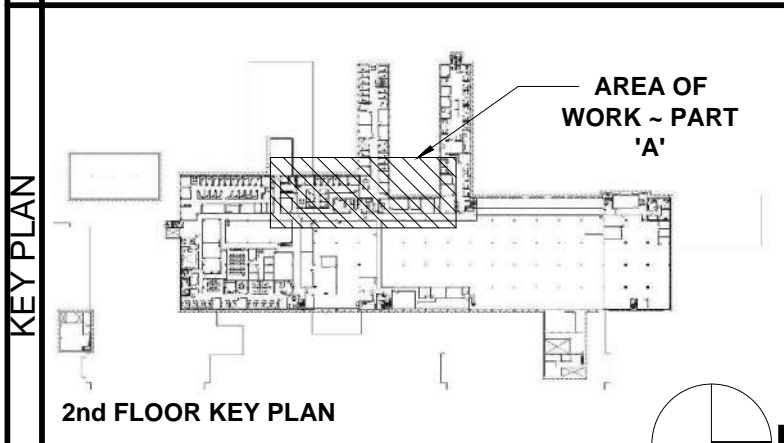
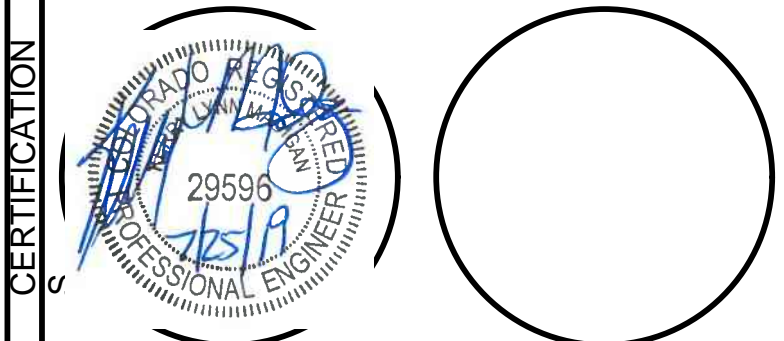
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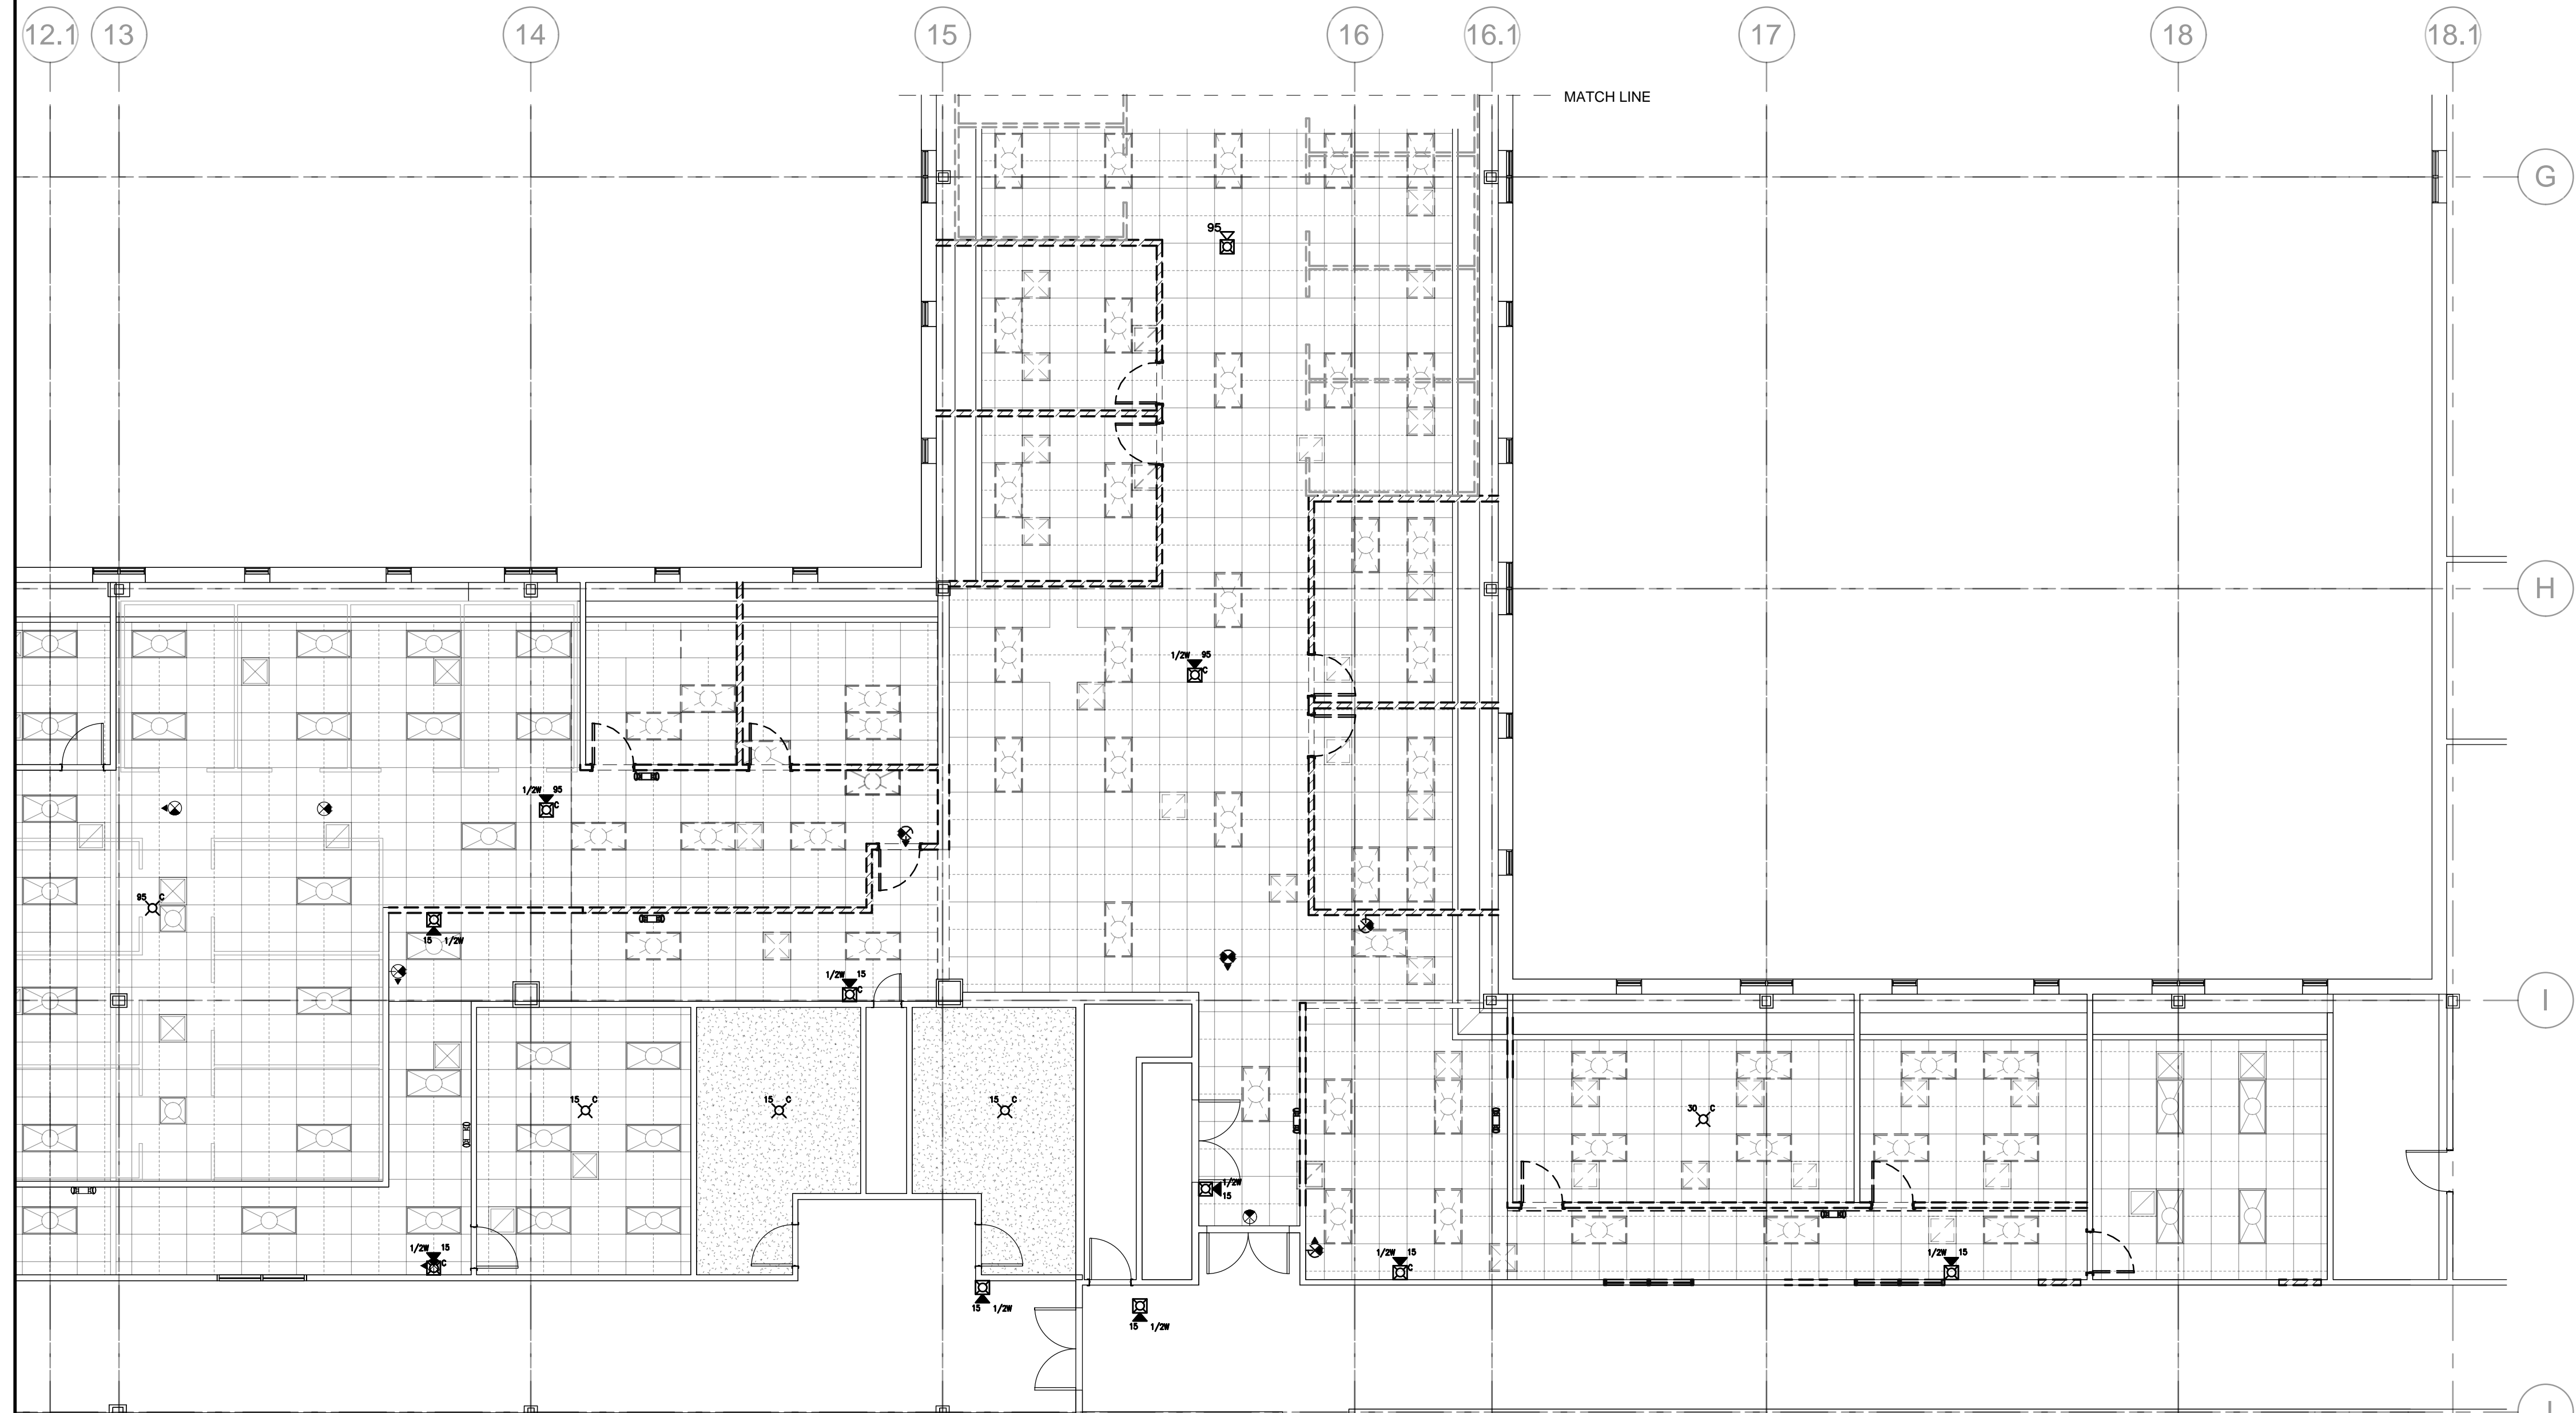
CERTIFICATION	KEY PLAN	REVISION NOTES

MARK	DATE	DESCRIPTION

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[DD]	DUCT DETECTOR
[RTS]	REMOTE TEST/RESET STATION
[RIL]	REMOTE INDICATING LIGHT
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[R]	R-RELOCATE
[E]	E-EXISTING TO REMAIN
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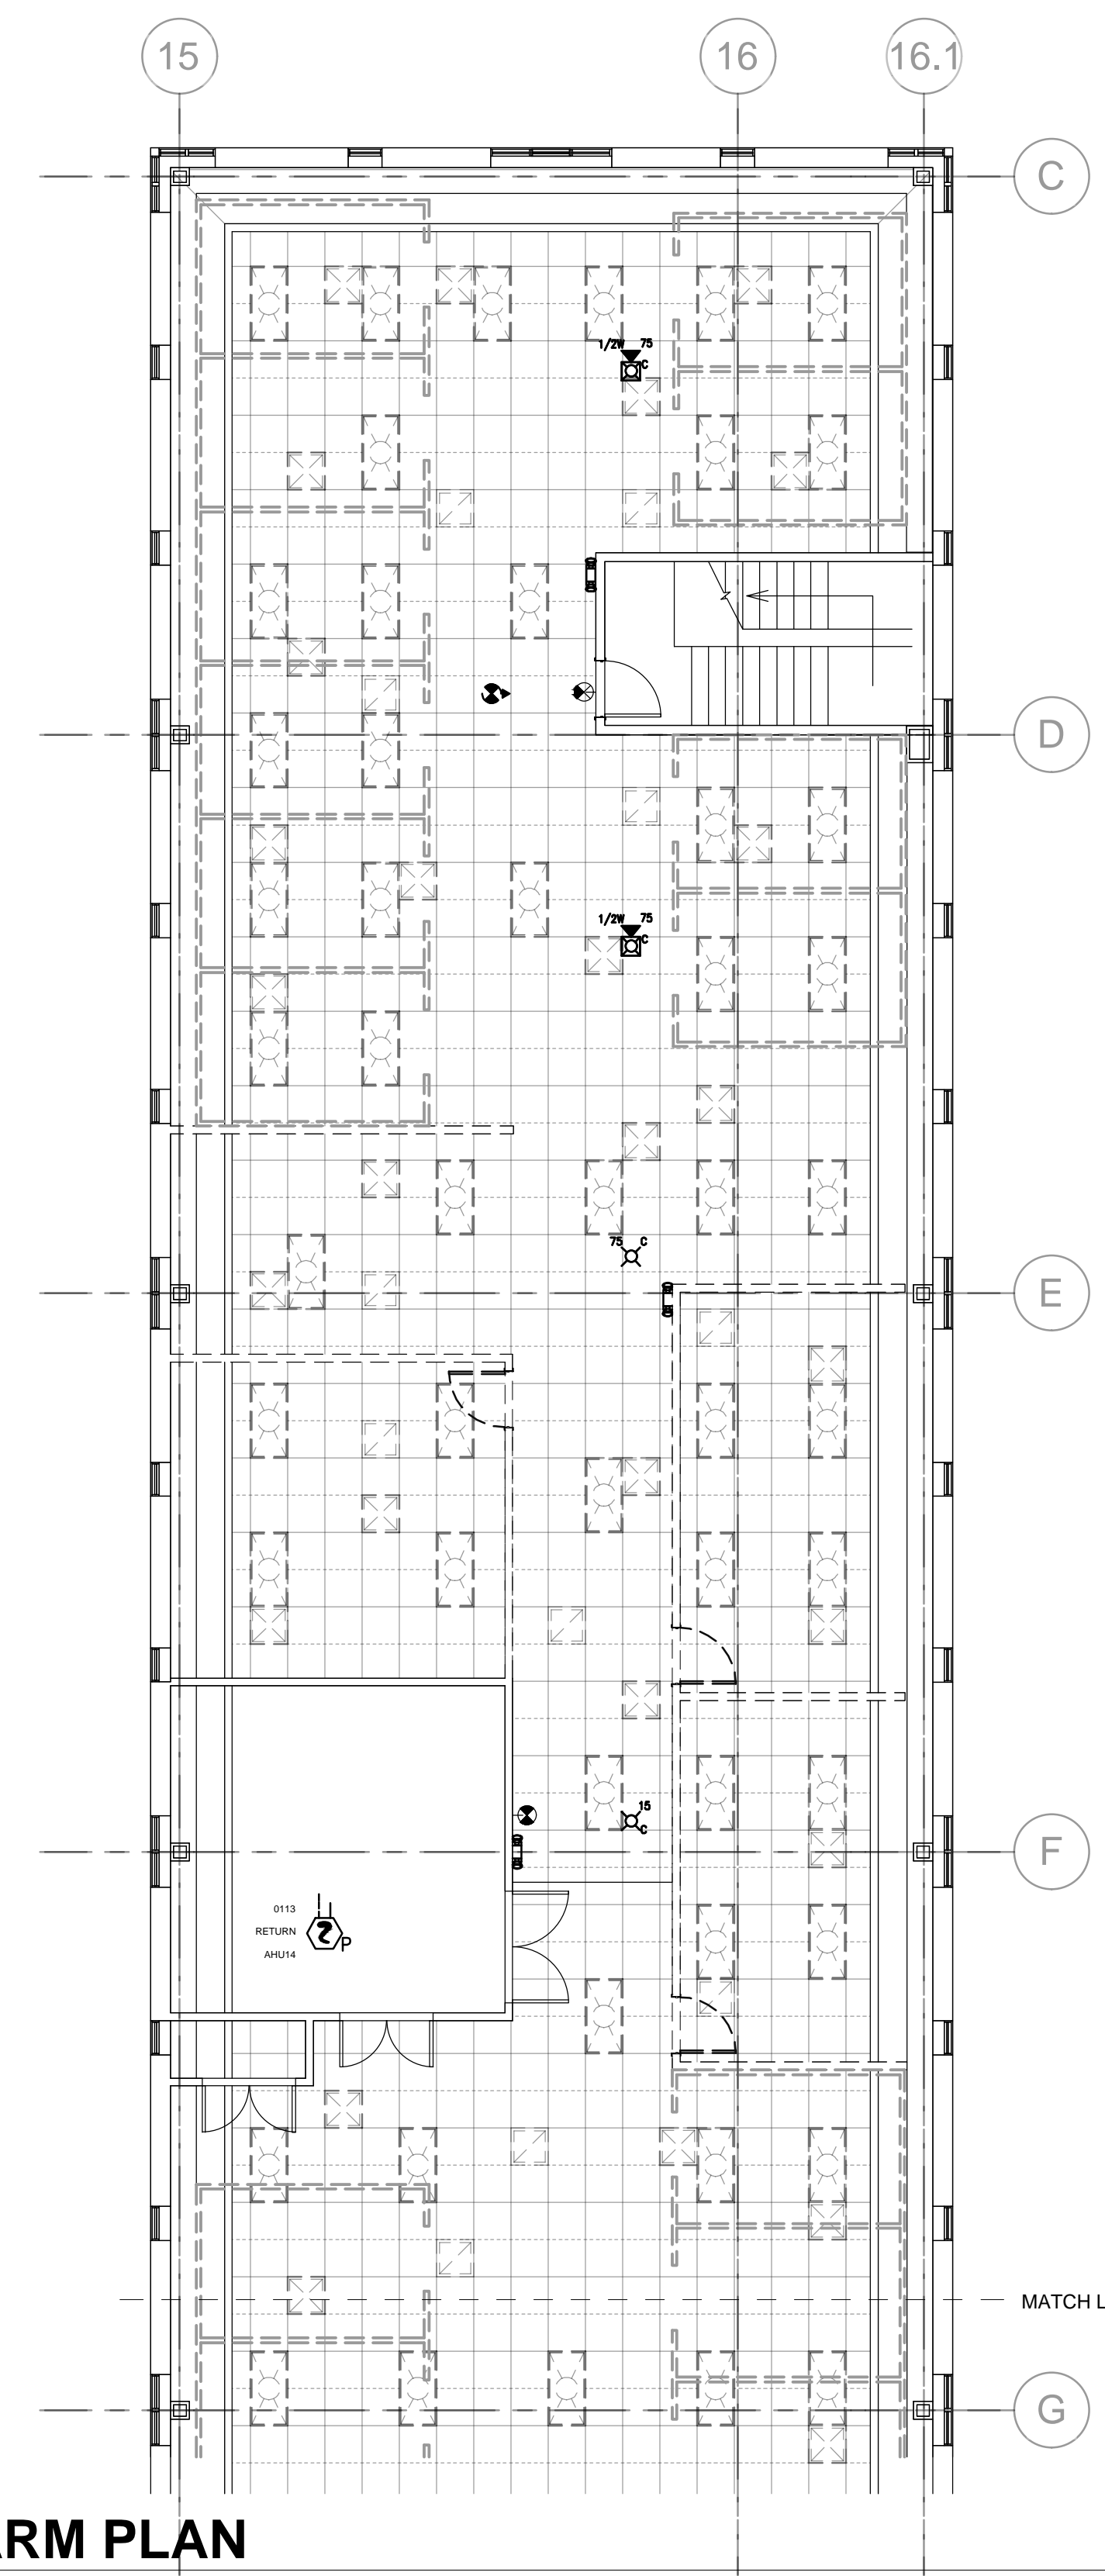
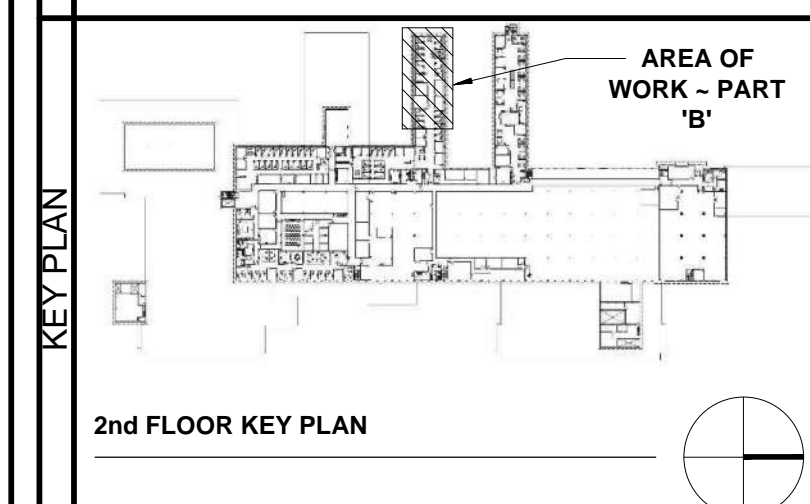
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SUB A/E	
CONSTR. CON.	
NAME	BUILDING 56
STREET	6TH STREET
CITY/ST./ZIP	DENVER, COLORADO 80255
BUILDING NO.	BUILDING 56
OTHER BUILDING NOS	
FACILITY CODE	
PROJECT TITLE	BUILDING 56 - NRCS
PROJECT DESCRIPTION	BUILDING 56 - 2ND FLOOR NRCS CONSOLIDATION
PROJECT NO.	EP-GS-P-08-16-JB-7053
GSA PM	BEN REKO
SUBMISSION	100% CD ISSUE
SUB. DATE	07/25/19
DRAWING TITLE	FIRE ALARM DEMO PLAN - PART 'A'
FILE NAME	NRCS BLDG 56 17-889.dwg
FLOOR NO.	2ND FLOOR
DRAWN BY	BE DATE DRAFTED 04/15/2019
CHECKED BY	KLM SHEET SIZE 22X34
DRAWING NO.	FAD1 02
DISCIPLINE	
SHEET TYPE	
SEQUENCE	
SHEET 47	OF 50



SYMBOL	DESCRIPTION
[FAACP]	FIRE ALARM CONTROL PANEL
[FAA]	FIRE ALARM ANNUCIATOR
[SD-P]	SMOKE DETECTOR (PHOTOELECTRIC)
[P]	PULL STATION
[WFS]	WATERFLOW SWITCH
[VTS]	VALVE WITH TAMPER SWITCH
[HST-N]	HORN WITH STROBE (NUMBER INDICATES CANDELA) (C INDICATES CEILING MOUNT)
[HST-S]	HORN WITH STROBE (NUMBER INDICATES CANDELA) (S INDICATES WALL MOUNT)
[SW-N]	SPEAKER WITH STROBE (NUMBER INDICATES CANDELA) (C INDICATES CEILING MOUNT)
[SW-S]	SPEAKER WITH STROBE (NUMBER INDICATES CANDELA) (S INDICATES WALL MOUNT)
[W-T]	WALL MOUNT SPEAKER (NUMBER INDICATES TAPPED WATTAGE)
[EOL-RE]	END OF LINE RESISTOR
[FDC]	FIRE DEPARTMENT CONNECTION
[DD]	DUCT DETECTOR
[RTS]	REMOTE TEST/RESET STATION
[RIL]	REMOTE INDICATING LIGHT
[HDT-F]	HEAT DETECTOR FIXED TEMP
[CH-10'-0"]	CEILING HEIGHT
[R]	RELOCATE
[E]	EXISTING TO REMAIN
[A]	NEW

REVISION NOTES

MARK	DATE	DESCRIPTION

CONTRACTOR'S GRAPHIC SCALE

A/E CON. NO.	GS-08P-JB-D-0017
A/E TASK NO.	EP-GS-P-08-16-JB-7053
CONS. CONTR.	GS-08P-13-JB-D-0032
CONS. WORK	
PRIM A/E	ANDEKLMON HALLAS ARCHITECT PC
SUB A/E	
CONSTR. CON.	
NAME	BUILDING 56
STREET	6TH STREET
CITY/ST./ZIP	DENVER, COLORADO 80255
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FLOOR NO.	2ND FLOOR
DRAWN BY	BE DATE DRAFTED 04/15/2019
CHECKED BY	KLM SHEET SIZE 22X34
DRAWING NO.	FAD1 03
DISCIPLINE	
SHEET	48
OF	50

EXISTING - SECOND LEVEL - PART 'A' FIRE ALARM PLAN
 1/8" = 1'-0"

GENERAL PLAN NOTES


- SPRINKLER HEADS SHALL BE RELOCATED OR ADDED TO PROVIDED PROPER COVERAGE
- PLEASE REFER TO MECHANICAL AND ELECTRICAL SHEETS FOR FIXTURE DEMOLITION.
- FIRE ALARM DEVICES SHALL BE RELOCATED OR ADDED TO PROVIDE PROPER COVERAGE

100% CONSTRUCTION DOCUMENTS

*BUILDING 56 - 2ND FLOOR
 NRCS CONSOLIDATION*

-- FOR CONSTRUCTION --

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1 SECOND LEVEL - PART 'A' FIRE ALARM PLAN
1/8" = 1'-0"

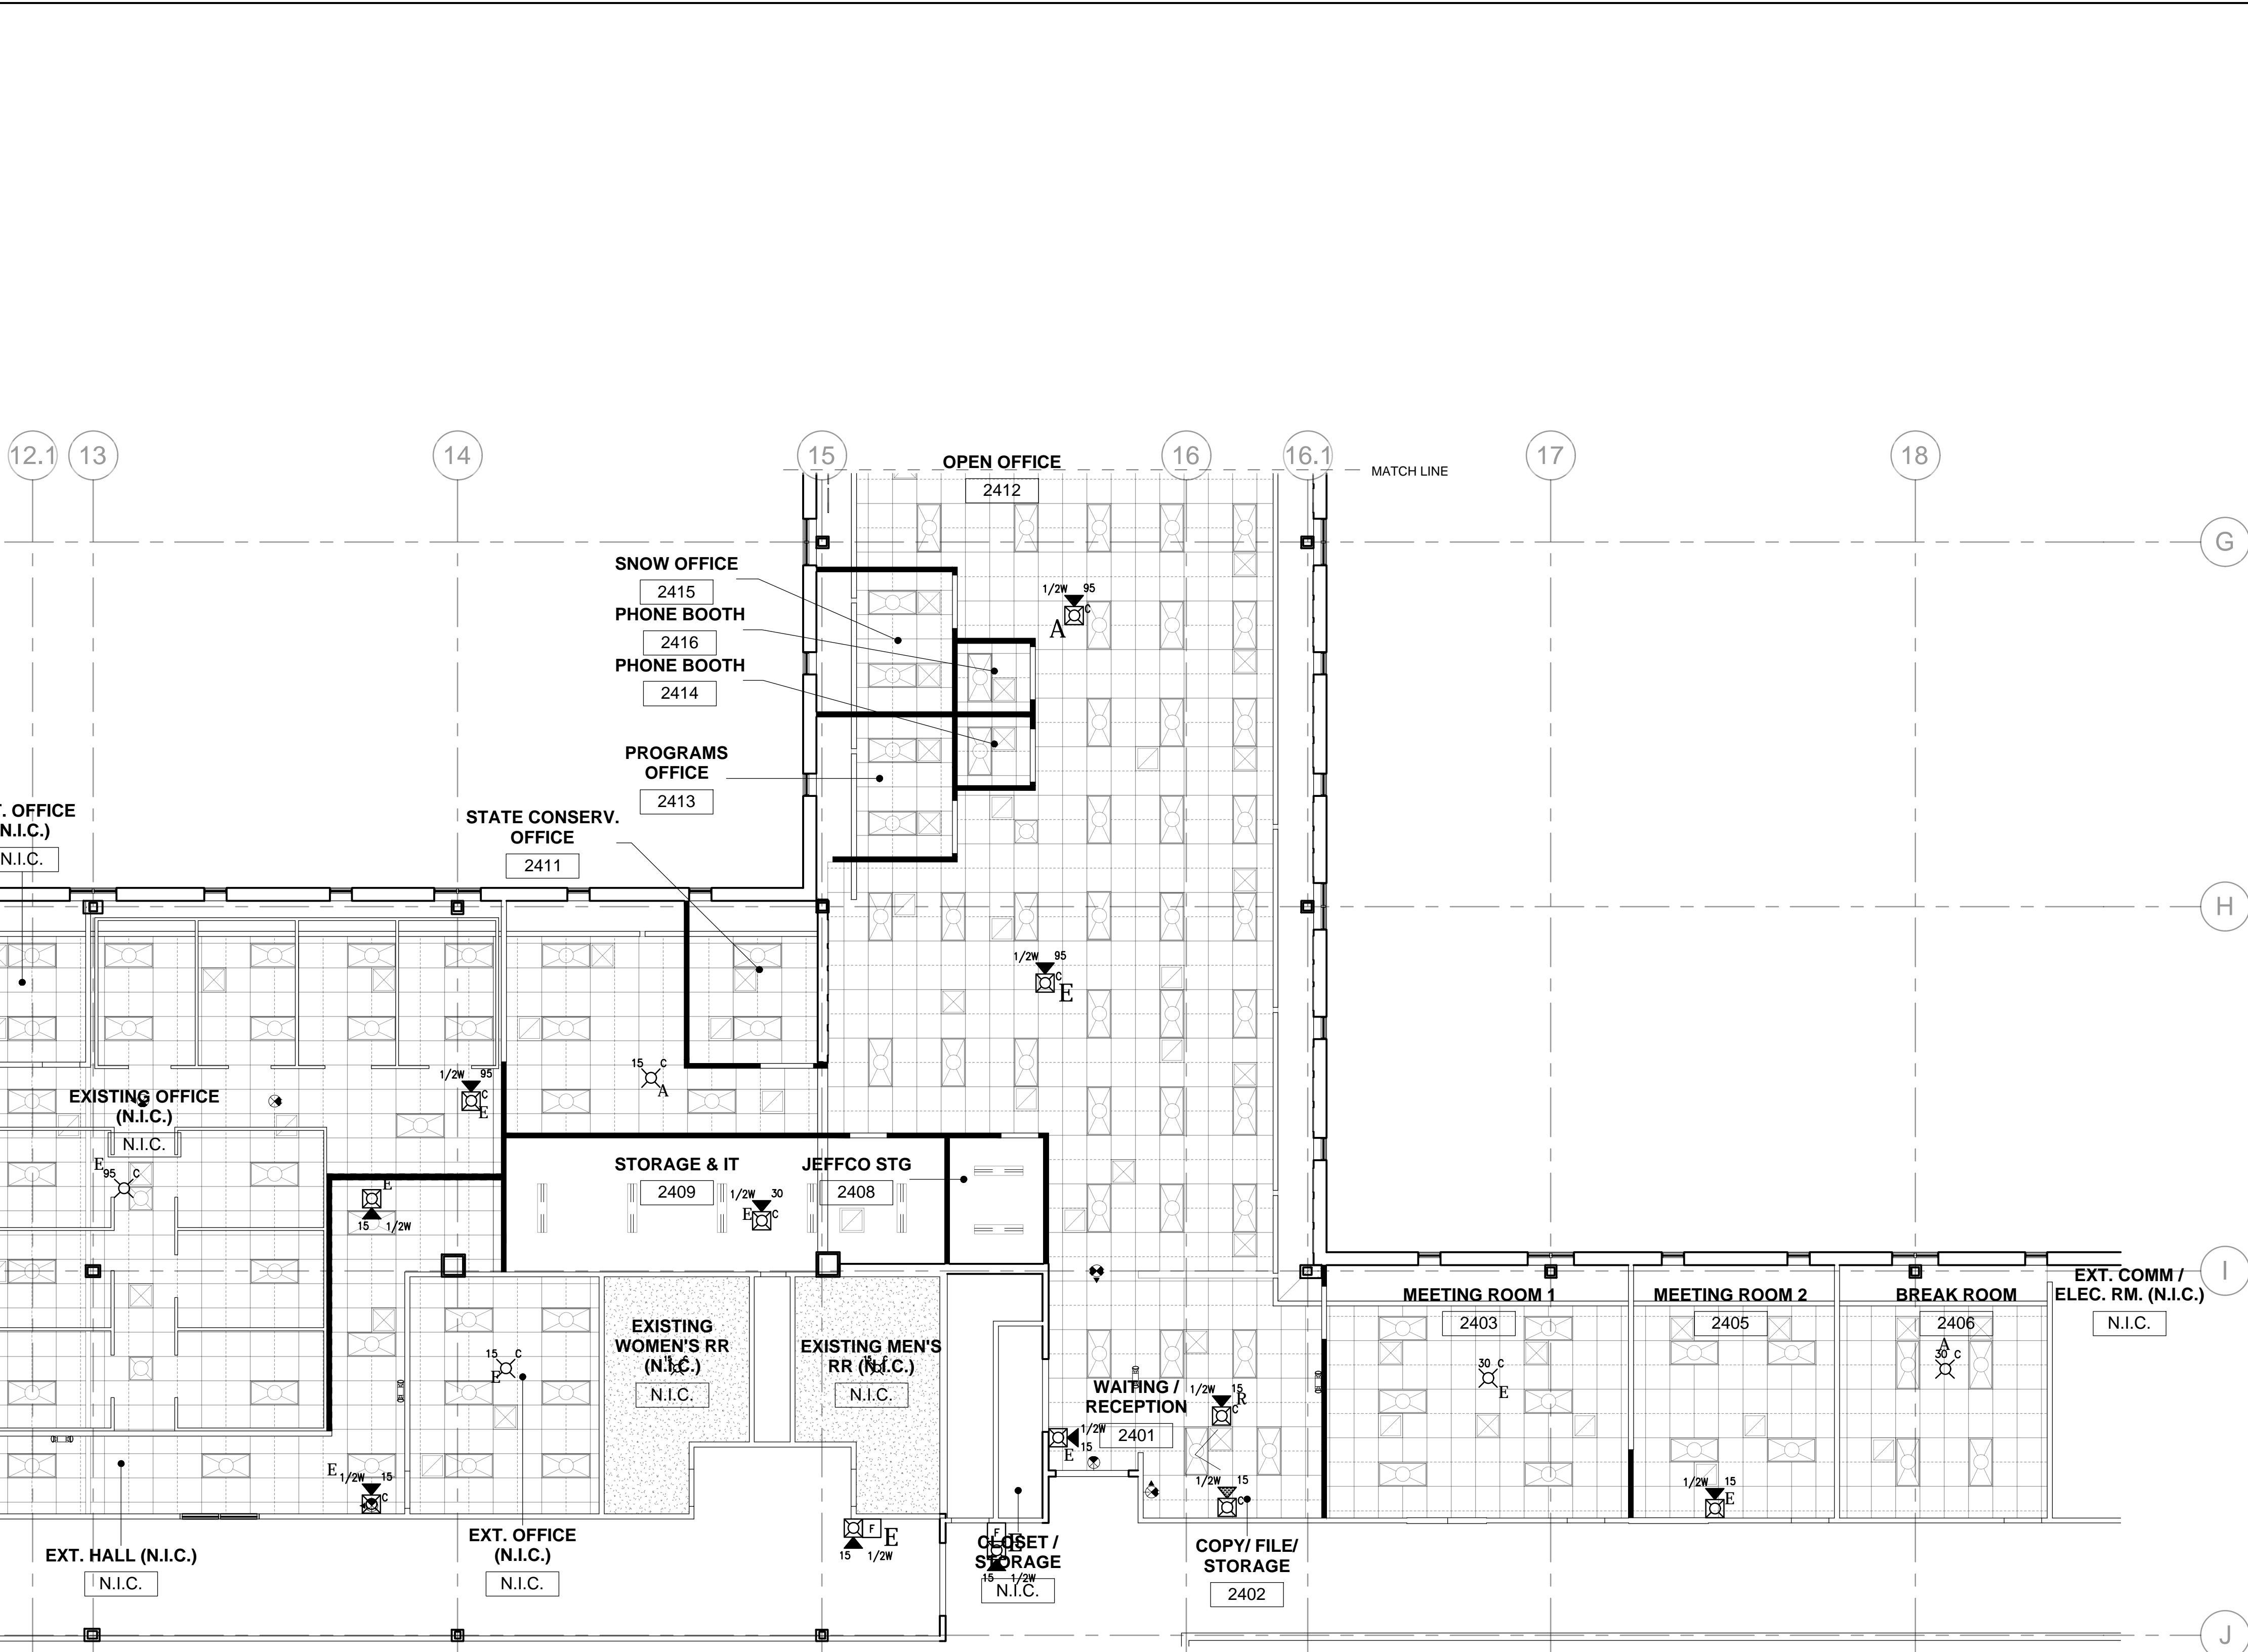GENERAL PLAN NOTES

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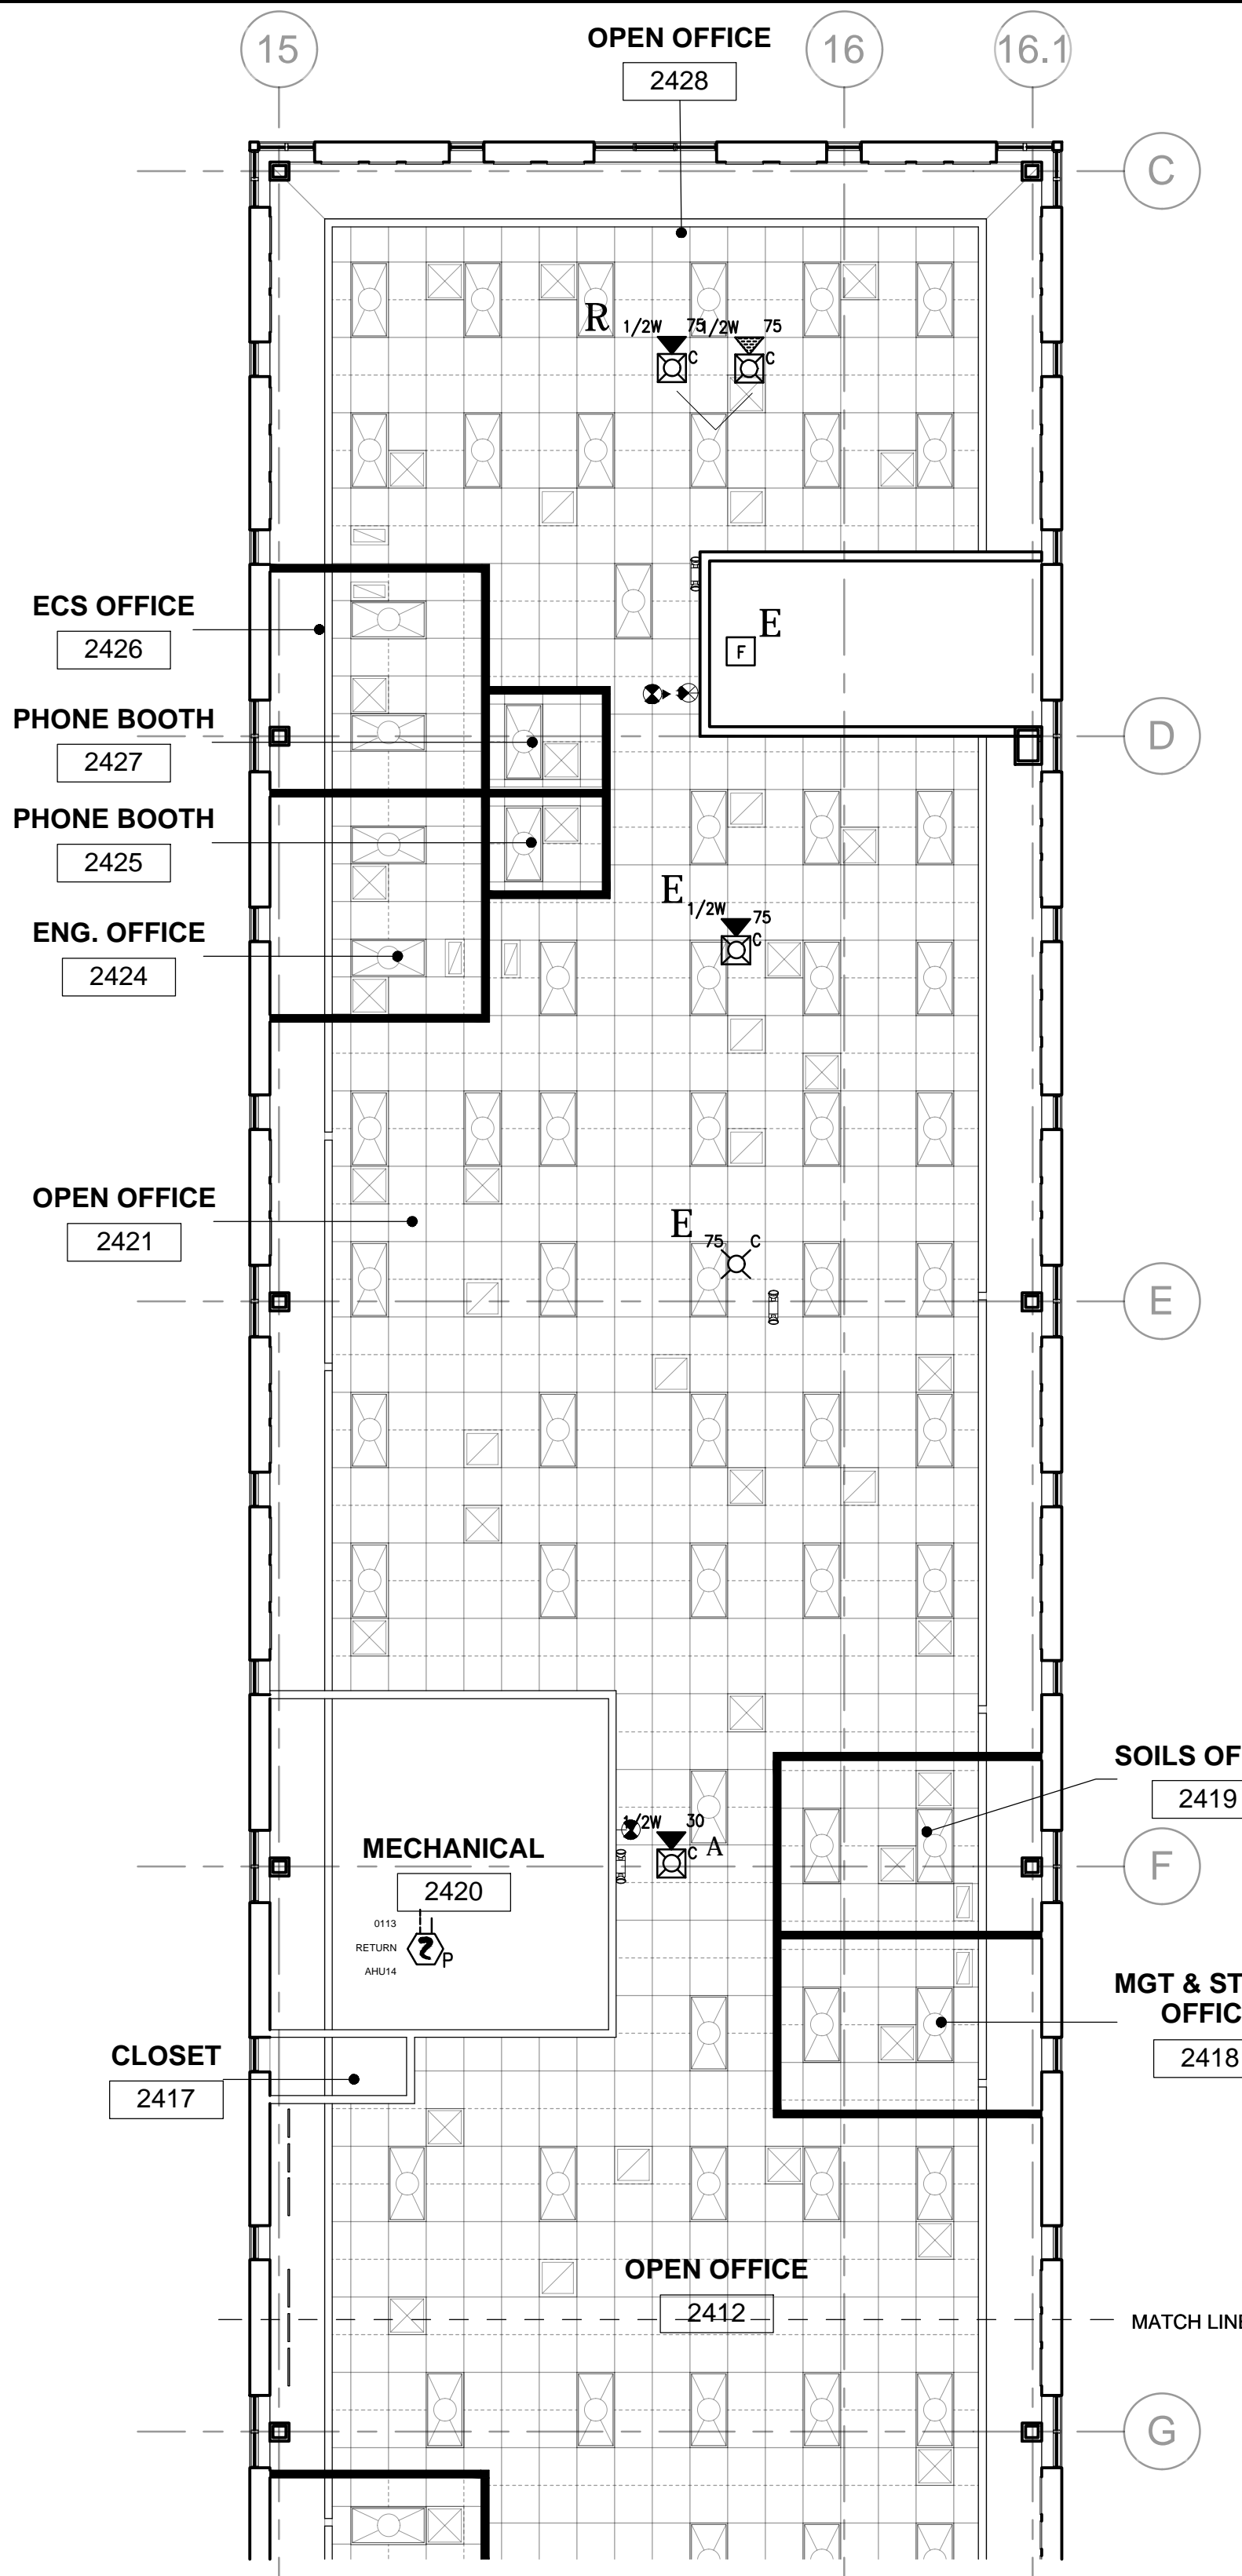
100% CONSTRUCTION DOCUMENTS
BUILDING 56 - 2ND FLOOR
NRCS CONSOLIDATION
-- FOR CONSTRUCTION --

SYMBOL	DESCRIPTION
[FACP]	FIRE ALARM CONTROL PANEL
[FAA]	FIRE ALARM ANUNCIATOR
[P]	PULL STATION
[WFS]	WATERFLOW SWITCH
[VTS]	VALVE WITH TAMPER SWITCH
[HWS]	HORN WITH STROBE (NUMBER INDICATES CANDELA) (C INDICATES CEILING MOUNT) STROBE (NUMBER INDICATES CANDELA)
[SWS]	SPEAKER WITH STROBE (NUMBER INDICATES CANDELA) (C INDICATES CEILING MOUNT) NUMBER WITH X/W INDICATES TAPPED WATTAGE
[CSM]	CEILING MOUNT SPEAKER (NUMBER INDICATES TAPPED WATTAGE: W-WALL MOUNT)
[EOLR]	END OF LINE RESISTOR
[FDC]	FIRE DEPARTMENT CONNECTION
[DD]	DUCT DETECTOR
[RTS]	REMOTE TEST/RESET STATION
[RIL]	REMOTE INDICATING LIGHT
[HDT]	HEAT DETECTOR FIXED TEMP
[CH]	CEILING HEIGHT
[R]	R-RELOCATE
[E]	E-EXISTING TO REMAIN
[A]	A-NEW

	GENERAL SERVICES ADMINISTRATION	
	Project Manager Ben Reko D.F.C. BUILDING 41 - SUITE 246 DENVER, COLORADO - 80255 303.236.0855 Phone 248.412.2812 Cell benjamin.reko@gsa.gov	
	ANDERSON HALLAS ARCHITECTS, PC 715 FOURTEENTH STREET GOLDEN, COLORADO 80401 (303) 278-4378 FAX (303) 278-0521 Principal: Dave Anderson AIA, LEED AP daveanderson@andarch.com	
	 VERITAS FIRE ENGINEERING, INC. 12364 W Alameda PKWY #135 LAKEWOOD, CO 80228 T:303.985.3300 F:303.985.5594 VERITASFIRE.COM	
CERTIFICATION		
KEY PLAN		
REVISION NOTES	MARK	DATE DESCRIPTION
CONTRACTOR'S GRAPHIC SCALE		
BUILDING		
PROJECT		
DRAWING		

A/E CON. NO.	GS-08P-JB-D-0017
A/E TASK NO.	EP-GS-P-08-16-JB-7053
CONS. CONTR.	GS-08P-13-JB-D-0032
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PRIM A/E	ANDEKLMON HALLAS ARCHITECT PC
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NAME	BUILDING 56
STREET	6TH STREET
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BUILDING NO.	BUILDING 56
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PROJECT NO.	EP-GS-P-08-16-JB-7053
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SUBMISSION	100% CD ISSUE
SUB. DATE	07/25/19
DRAWING TITLE	FIRE ALARM PLAN - PART 'A'
FILE NAME	NRCS BLDG 56 17-889.dwg
FLOOR NO.	2ND FLOOR
DRAWN BY	BE DATE DRAFTED:
CHECKED BY	KLM SHEET SIZE 22X34
DRAWING NO.	FA 1 04
	DISCIPLINE SHEET TYPE SEQUENCE
	SHEET 49 OF 50

4/18/2019 12:20:01 PM



SYMBOL	DESCRIPTION
	FIRE ALARM CONTROL PANEL
	FIRE ALARM ANNUCIATOR
	SMOKE DETECTOR (PHOTOELECTRIC)
	PULL STATION
	WATERFLOW SWITCH
	VALVE WITH TAMPER SWITCH
	HORN WITH STROBE (NUMBER INDICATES CANDELA) (C INDICATES CANDELA) (C INDICATES CANDELA)
	CEILING MOUNT STROBE (NUMBER INDICATES CANDELA)
	SPEAKER WITH STROBE (NUMBER INDICATES CANDELA) (C INDICATES CANDELA) (C INDICATES CANDELA)
	CEILING MOUNT SPEAKER (NUMBER INDICATES CANDELA) (C INDICATES CANDELA) (C INDICATES CANDELA)
	END OF LINE RESISTOR
	FIRE DEPARTMENT CONNECTION
	DUCT DETECTOR
	REMOTE TEST/RESET STATION
	REMOTE INDICATING LIGHT
	HEAT DETECTOR FIXED TEMP
	CEILING HEIGHT
	R-RELOCATE
	E-EXISTING TO REMAIN
	A-NEW

1 SECOND LEVEL - PART 'B' FIRE ALARM PLAN
1/8" = 1'-0"

GENERAL PLAN NOTES

- SPRINKLER HEADS SHALL BE RELOCATED OR ADDED TO PROVIDED PROPER COVERAGE
- PLEASE REFER TO MECHANICAL AND ELECTRICAL SHEETS FOR FIXTURE DEMOLITION.
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100% CONSTRUCTION DOCUMENTS
BUILDING 56 - 2ND FLOOR
NRCS CONSOLIDATION
-- FOR CONSTRUCTION --

<p>GENERAL SERVICES ADMINISTRATION Ben Reko Project Manager D.F.C. BUILDING 41 - SUITE 246 DENVER, COLORADO - 80255 303.236.0855 Phone 220.412.2812 Cell benjamin.reko@gsa.gov</p>																																																																															
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